Appendix F:

CDOT US-24 Corridor Plans

Oversight / NHS FHWA REGION VIII OVERSIGHT? ☑ NO □ YES NATIONAL HIGHWAY SYSTEM? □ NO ☑ YES

DEPARTMENT OF TRANSPORTATION STATE OF COLORADO

Related Projects:

P. E. UNDER PROJECT: Project Number Project Code:

XXXXXXXXX XXXXX

R.O.W. Projects:


R.O.W. Project Description

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CONSTRUCTION BID PLANS OF PROPOSED **PROJECT NO. NH 0242-056** US 24 - WALDO CANYON POST FIRE FLOOD MITIGATION **EL PASO COUNTY**

CONSTRUCTION PROJECT CODE NO. 19358

DWG NO.	SHEET NO.	INDEX OF SHEETS
1C 2 3A-5A 6-8 9 10A 11-12 13C 14C 15		TITLE SHEET R=3 STANDARD PLANS LIST SUMMARY OF APPROX. QUANTITIES R=1 SUMMARY OF APPROX. QUANTITIES GENERAL NOTES STORMWATER MANAGEMENT PLANS STORMWATER MANAGEMENT PLANS SURVEY CONTROL TABULATION CONSTRUCTION TRAFFIC CONTROL TABULATION TABULATION OF POTHOLES
		POUR POINT A
16 17-18 19-23 24-25 26-27 28-29	A-1 A-2 TO A-3 A-4 TO A-8 A-9 TO A-10 A-11 TO A-12 A-13 TO A-14	TABULATION OF QUANTITIES REMOVALS / RESETS PLAN DRAINAGE DETAILS GRADING/INITIAL EROSION CONTROL PLANS GRADING/INTERIM EROSION CONTROL PLANS GRADING/FINAL EROSION CONTROL PLANS
		POUR POINT B
30 31 32-36 37 38 39	B-1 B-2 B-3 TO B-7 B-8 B-9 B-10	TABULATION OF QUANTITIES REMOVALS / RESETS PLAN DRAINAGE DETAILS GRADING/INITIAL EROSION CONTROL PLAN GRADING/INTERIM EROSION CONTROL PLAN GRADING/FINAL EROSION CONTROL PLAN
		POUR POINT C
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PROJECT LOCATION MAP

4000'
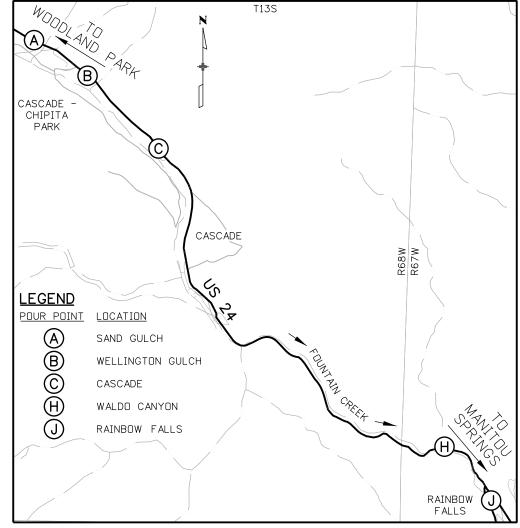
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Horiz. Scale: 1:4000	Vert. Scale: As Noted	Œ
Unit Information	Unit Leader Initials	Œ
FELSBURG	6300 South Syracuse Way Suite 600	R
HOLT & ULLEVIG	Centennial, CO 80111 (303) 721-1440	\cup

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\mathbb{R} -1	04-16-13	UPDATE SHEETS	CDT	
R-2	04-19-13	UPDATE SHEET	CDT	
\mathbb{R} -3	04-22-13	REVISED SHEET NUMBER	CDT	

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	As Constructed	Contract Information	Project No./Code	
	, 10 0011011 00100	Contractor:	NH 0242-056	
	No Revisions:	Resident Engineer: DAVE WATT		
	Revised:	Project Engineer: LESLEY MACE	19358	
		PROJECT STARTED: / / ACCEPTED: / /		
	Void:	Comments:	Sheet Number 1C	

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M-203-12	2	SUPERELEVATION STREE	TS (2 SHEETS)	13-14
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COLORADO DEPARTMENT OF TRANSPORTATION M&S STANDARDS PLANS LIST July 04, 2012

Revised on March 5, 2013

ALL OF THE M&S STANDARD PLANS, AS SUPPLEMENTED AND REVISED, APPLY TO THIS PROJECT WHEN USED BY DESIGNATED PAY ITEM OR SUBSIDIARY ITEM.

NEW OR REVISED STANDARD PLAN SHEETS APPLICABLE TO THIS PROJECT, INDICATED BY A MARKED BOX , WILL BE ATTACHED TO THE PLANS.

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S STANDARD

TITLE

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Unit Information	Unit Leader Initials				Г
FELSBURG HOLT & ULLEVIG	6300 South Syracuse Way Suite 600 Centennial, CO 80111 (303) 721-1440	00			

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SUMMARY OF APPROXIMATE QUANTITIES

Index			Contract Item No.	Contract Item	Unit		Pour Point A Sand Gulch		Point B ton Gulch	Pour Point C Cascade		cade Waldo C		Pour Point J Rainbow Falls				Proje	ct Totals
look	Page	Sheet	1 -1			Plan	As Const.	Plan	As Const.	Plan	As Const	Plan	As Const.	Plan	As Const.	Plan	As Const.	Plan	As Co
			201-00001	CLEARING AND GRUBBING	LS	1		1		ð,		1		1	12.11		11.71	5	
			202-00010	REMOVAL OF TREE	EA	13		45		17						59		134	
			202-00010	REMOVAL OF TREE	EA	13	1	45		30			1			29		134	
			202-00027	REMOVAL OF RIPRAP	SY									86				86	
			202-00035	REMOVAL OF PIPE	LF			3				4						7	
			202-00220	REMOVAL OF ASPHALT MAT	SY					792						100		892	
			202-00495	REMOVAL OF PORTIONS OF PRESENT STRUCTURE	LS			12								1		1	
			202-01000	REMOVAL OF FENCE	LF	99		207		137								443	
			202-04002	CLEAN CULVERT	EA	1		1		7	-	i						10	-
			202-05026	SAWING ASPHALT MATERIAL (6 INCH)	LF											200		200	
			203-00010	UNCLASSIFIED EXCAVATION (COMPLETE IN PLACE)	CY	893		2973		3000				12916				19782	
			203-00060	EMBANKMENT MATERIAL (COMPLETE IN PLACE)	CY									450				450	
			203-00598	ROCK SCALING	HR			11 - 11						60				60	
	П		203-01500	BLADING	HR											200		200	
	-		203-01510	BACKHOE	HR											200		200	
			203-01550	DOZING	HR											200		200	
1	П		203-01590	FRONT END LOADER (RUBBER TIRE)	HR.											200		200	
			203-01594	POTHOLING	HR											50		50	
			203-01622	SWEEPING (WITH PICKUP BROOM)	HR	40		40		40		40		40				200	
			206-00000	STRUCTURE EXCAVATION	CY									450				450	
			206-00510	FILTER MATERIAL (CLASS A)	CY						100			200				200	

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Unit Information	Unit Leader Initials
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Sheet Revisions

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	DOT	1480 QuailLake Loop Colorado Springs, CO Phone: 719-227-3201	80806 FAX: 719-227-329

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SUMMARY OF APPROXIMATE QUANTITIES

Index			Contract Item No.	Contract Item	Unit	Pour Point A Sand Gulch		Pour Point B Wellington Gulch		Pour Point C Cascade		Pour Point H Waldo Canyon				Overall Project		Project Totals	
Book	Page	Sheet				Plan	As Const.	Plan	As Const.	Plan	As Const.	Plan	As Const.	Plan	As Const.	Plan	As Const.	Plan	As Cons
			207-00205	TOPSOIL	CY	100		217		320				202				839	
			208-00002	EROSION LOG (12 INCH)	ĻF	208		293		1300				455				2256	
			208-00020	SILT FENCE	LF					241								241	
			208-00034	GRAVEL BAG	LF	40		60		486		150		490				1226	
			208-00041	ROCK CHECK DAM	EA									1				1	
			208-00045	CONCRETE WASHOUT STRUCTURE	EA	2		1		1		1		2				7	
			208-00070	VEHICLE TRACKING PAD	EA	2		ţ		4		1		2				7	
			208-00103	REMOVAL AND DISPOSAL OF SEDIMENT (LABOR)	HR	80		80		80		80		80				400	
			208-00105	REMOVAL AND DISPOSAL OF SEDIMENT (EQUIPMENT)	HR	40		40		40		40		40				200	
			208-00205	EROSION CONTROL SUPERVISOR	DAY	30		30		30		30		30				150	
			208-00301	TEMPORARY DIVERSION	LF									300				300	
			210-00475	RESET CLOSED CIRCUIT TELEVISION POLE	EA									1				1	
			210-00810	RESET GROUND SIGN	EA									1				1	
			210-01050	RESET CHAIN LINK FENCE	ĹF	12												12	
			210-01130	RESET GUARDRAIL TYPE 3	LF					43								43	
			210-02900	RELAY RIPRAP	CY							15						15	
			211-03005	DEWATERING	LS						-					ì		1 -	
			212-00006	SEEDING (NATIVE)	AC	0.3		0.7		0.4				0.25				1.65	
			212-00032	SOIL CONDITIONING	AC	0.3		0.7		0.4				0.25				1.65	

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Unit Information	Unit Leader Initials
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SUMMARY OF APPROXIMATE QUANTITIES

Index			Contract Item No.	Contract Item	Unit		Point A d Gulch		Point B ston Gulch		Point C scade		Point H Canyon		Point J ow Falls	Overa	l Project	Proje	ct Totals
Book	Page	Sheet	East of the	A 3 3 4 4 7 7 7 7 7 7 7 7 7 7 7 7 7 7 7 7	150	Plan	As Const.	Plan	As Const.	Plan	As Const.	Plan	As Const.	Plan	As Const.	Plan	As Const.	Plan	As Con
			213-00002	MULCHING (WEED FREE)	AC	0.3		0.7		0.4				0.25				1.65	
			-00000	In the subtract for a colourse	100														
	-		214-00000	LANDSCAPE MAINTENANCE	LS		ļ								-	1		1	
			214-00215	DECIDUOUS TREE (1.5 INCH CALIPER)	EA			45										45	
			214-00450	EVERGREEN TREE (5 GALLON CONTAINER)	EA	13				17								30	
			216-00041	SOIL RETENTION BLANKET (STRAW/COCONUT)	SY	512		1165		2105				563				4345	
			217-00000	HERBICIDE TREATMENT	SY											2000		2000	
			250-00010	ENVIRONMENTAL HEALTH AND SAFETY MANAGEMENT	LS											1		1	
	Ш		304-06000	AGGREGATE BASE COURSE (CLASS 6)	СУ	11		63		23	-			79		50		226	
			403-00721	HOT MIX ASPHALT (PATCHING)	TON											500		500	
			411-10255	EMULSIFIED ASPHALT (SLOW-SETTING)	GAL											10		10	T
			420-00102	GEOTEXTILE (EROSION CONTROL) (CLASS 1)	sy	192		314		1171				540				2217	
			504-06315	GROUND NAIL (15 FOOT)	EA			-			l le district			60				60	
			506-00010	RIPRAP (SPECIAL)	CY									35				35	
			506-00030	GROUTED RIPRAP	CY	51				120								171	
			506-00036	GROUTED RIPRAP (36 INCH) (SPECIAL)	CY									275				275	
			506-00218	RIPRAP (18 INCH)	CY									275				275	
			506-00236	RIPRAP (36 INCH)	CY			90										90	
			506-00412	SOIL RIPRAP (12 INCH)	CY	94		118		423				81				716	
			506-01020	GEOGRID REINFORCEMENT	sy					1				856				856	
			507-00725	SLOPE AND DITCH PAVING (SPECIAL)	CY	22				120			4					142	

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Unit Information	Unit Leader Initials
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Colorado	Department of Transportation
D 07	1480 QuailLake Loop

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480 QuailLake Loop colorado Springs, CD hone: 719-227-3201	80806 FAX: 719-227-3298

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SUMMARY OF APPROXIMATE QUANTITIES

	Index		Contract Item No.	Contract Item	Unit		Point A d Gulch		Point B ton Gulch		Point C scade		Point H Canyon		Point J ow Falls	Overal	Project	Proje	ct Totals
Book	Page	Sheet	20090000000			Plan	As Const.	Plan	As Const.	Plan	As Const.	Plan	As Const.	Plan	As Const.	Plan	As Const.	Plan	As Con
			601-01000	CONCRETE CLASS B	CY	43		22		103		15					-	183	
			601-03050	CONCRETE CLASS D (WALL)	CY							13						13	
			602-00000	REINFORCING STEEL	LB							750						750	
			603-01240	24 INCH REINFORCED CONCRETE PIPE (CIP)	LF					154								154	
			603-01420	42 INCH REINFORCED CONCRETE PIPE (CIP)	LF					108								108	
			603-05024	24 INCH REINFORCED CONCRETE END SECTION	EA					4								4	
			603-05042	42 INCH REINFORCED CONCRETE END SECTION	EA					2								2	
			604-50050	INLET GRATING AND FRAME SPECIAL	EA					1								1	
			607-01000	FENCE BARBED WIRE WITH METAL POSTS	LF	120												120	
			607-53172	FENCE CHAIN LINK (72 INCH)	LF									174		4000		4174	
			607-53173	FENCE CHAIN LINK (SPECIAL) (72 INCH)	LF			260										260	
			607-55100	WIRE MESH	SF									52330				52330	
			607-60212	12 FOOT GATE SINGLE (CHAIN LINK)	EA			2										2	
			607-60274	24 FOOT GATE DOUBLE (CHAIN LINK)	EA											Ť		1	
			608-00100	REINFORCED GRASS/CONCRETE POROUS PAVEMENT	SY	354		1598		491								2443	
			609-21020	CURB AND GUTTER TYPE 2 (SECTION II-B)	LF				PI					390				390	
			615-00620	LOG DEFLECTOR	EA	-1		1		+								2	
			620-00002	FIELD OFFICE (CLASS 2)	EA											ă		*	
			620-00012	FIELD LABORATORY (CLASS 2)	EA			1								1		1	

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SUMMARY OF APPROXIMATE QUANTITIES

	Index ook Page Sheet		Contract Item No.	Contract Item	Unit		Point A		Point B ton Gulch		Point C scade		Point H Canyon		r Point J bow Falls	Overa	l Project	Proje	ect Totals
Book	Page	Sheet				Plan	As Const.	Plan	As Const.	Plan	As Const.	Plan	As Const.	Plan	As Const.	Plan	As Const.	Plan	As Cons
			620-00020	SANITARY FACILITY	EA											2		2	
					100														
			625-00000	CONSTRUCTION SURVEYING	LS											1		1	_
			626-00000	MOBILIZATION	LS											1		1	
			626-01000	PUBLIC INFORMATION SERVICES	LS											1		1	
			627-00001	PAVEMENT MARKING PAINT	GAL											5		5	
			630-00000	FLAGGING	HR											125		125	
			630-00007	TRAFFIC CONTROL INSPECTION	DAY											125		125	
			630-00012	TRAFFIC CONTROL MANAGEMENT	DAY											50		50	
			630-80001	FLASHING BEACON (PORTABLE)	EA											8		8	
			630-80335	BARRICADE (TYPE 3 M-A)(TEMPORARY)	EA											3		3	
			630-80341	CONSTRUCTION TRAFFIC SIGN (PANEL SIZE A)	EA											28		28	
			630-80342	CONSTRUCTION TRAFFIC SIGN (PANEL SIZE B)	EA											50		50	
	Ħ		630-80344	CONSTRUCTION TRAFFIC SIGN (SPECIAL)	SF											64		64	
			630-80355	PORTABLE MESSAGE SIGN PANEL	EA											2		2	
			630-80357	ADVANCED WARNING OR SEQUENCING ARROW PANEL (A)	EA											2		2	
	П		630-80360	DRUM CHANNELIZING DEVICE	EA											250		250	
			630-80370	CONCRETE BARRIER (TEMPORARY)	LF											3000		3000	
			630-80380	TRAFFIC CONE	EA											250		250	
			630-85000	IMPACT ATTENUATOR (TEMPORARY)	EA											5		5	
			641-10000	SHOTCRETE	SY									139				139	

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SUMMARY OF APPROXIMATE QUANTITIES

Contract Item No.	Contract Item	Unit	040-4				Pour Point C Cascade		Pour Point H Waldo Canyon		Pour Point J Rainbow Falls		Overall Project		Project Totals	
			Plan	As Const.	Plan	As Const.	Plan	As Const.	Plan	As Const.	Plan	As Const.	Plan	As Const.	Plan	As Const.
700-70010	F/A MINOR CONTRACT REVISION	FA											1		1	
700-70016	F/A FUEL COST ADJUSTMENT	FA											1		1	+
700-70019	F/A ASPHALT CEMENT COST ADJUSTMENT	FA											1		1	
700-70034	F/A DOZING	FA											1		1	
700-70380	F/A EROSION CONTROL	FA											1		1	
700-70550	F/A BLADING SHOULDER	FA											1		1	
700-73352	F/A MISCELLANEOUS UTILITY RELOCATIONS	FA											1		1	
	700-70010 700-70016 700-70019 700-70034 700-70380 700-70550	700-70010 F/A MINOR CONTRACT REVISION 700-70016 F/A FUEL COST ADJUSTMENT 700-70019 F/A ASPHALT CEMENT COST ADJUSTMENT 700-70034 F/A DOZING 700-70380 F/A EROSION CONTROL 700-70550 F/A BLADING SHOULDER	700-70010 F/A MINOR CONTRACT REVISION FA 700-70016 F/A FUEL COST ADJUSTMENT FA 700-70019 F/A ASPHALT CEMENT COST ADJUSTMENT FA 700-70034 F/A DOZING FA 700-70380 F/A EROSION CONTROL FA 700-70550 F/A BLADING SHOULDER FA	Contract Item No. Contract Item Unit Sand Plan	Plan As Const. 700-70010 F/A MINOR CONTRACT REVISION FA 700-70016 F/A FUEL COST ADJUSTMENT FA 700-70019 F/A ASPHALT CEMENT COST ADJUSTMENT FA 700-70034 F/A DOZING FA 700-70380 F/A EROSION CONTROL FA 700-70550 F/A BLADING SHOULDER FA	Contract Item No. Contract Item Unit Sand Gulch Welling	Contract Item No. Contract Item No. Contract Item Unit Sand Gulch Wellington Gulch	Contract Item No. Contract Item No. Contract Item Unit Sand Gulch Wellington Gulch Ca	Contract Item No. Contract Item Unit Sand Gulch Wellington Gulch Cascade	Contract Item No. Contract Item No. Contract Item Unit Sand Gulch Wellington Gulch Cascade Waldow Plan As Const. Plan Plan As Const. Plan P	Contract Item No. Plan As Const. Plan Plan	Contract Item No. Plan As Const. Plan As Const.	Contract Item No Plan As Const. Plan Pl	Contract Item No. Cont	Contract Item No. Con	Contract Item No. Cont

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Colorado Department of Transportation

1480 Quail Lake Loop
Colorado Springs, CD 80806
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SEE PROJECT CONTROL SHEET FOR HORIZONTAL CONTROL TO BE USED ON THIS PROJECT.

ALL CONSTRUCTION SHALL BE COMPLETED PER THE COLORADO DEPARTMENT OF TRANSPORTATION (CDOT) STANDARD PLANS AND SPECIFICATIONS, LATEST EDITION, OR AS SHOWN.

UTILITY LINES AS SHOWN ON THE PLAN SHEETS ARE PLOTTED FROM THE BEST AVAILABLE INFORMATION. THE CONTRACTORS ATTENTION IS DIRECTED TO SUBSECTION 105.11 DF THE STANDARD SPECIFICATIONS CONCERNING UTILITIES. THE CONTRACTOR SHALL COMPLY WITH ARTICLE 1.5 OF TITLE 9, CRS ("EXCAVATION REQUIREMENT") WHEN EXCAVATING OR GRADING IS PLANNED IN THE AREA OF UNDERGROUND UTILITIES. THE CONTRACTOR SHALL NOTIFY ALL AFFECTED UTILITIES AT LEAST 2 BUSINESS DAYS, NOT INCLUDING THE ACTUAL DAY OF NOTICE, PRIOR TO COMMENCING SUCH OPERATIONS. THE CONTRACTOR SHALL CONTACT UNCC AT 811 OR 1-800-922-1987 TO HAVE LOCATION OF UNCC REGISTERED LINES MARKED BY MEMBER COMPANIES. ALL OTHER UNDERGROUND FACILITIES SHALL BE LOCATED BY CONTACTING THE RESPECTIVE OWNER. UTILITY SERVICE LATERALS SHALL ALSO BE LOCATED PRIOR TO BEGINNING EXCAVATION OR GRADING.

THE CONTRACTOR SHALL BE RESPONSIBLE FOR THE CONTACTING AND COORDINATING WITH THE APPROPRIATE UTILITY REPRESENTATIVE TO BE ON-SITE DURING POTHOLING. THE CONTRACTOR SHALL REFER TO THE UTILITY SPECIFICATION FOR ADDITIONAL REQUIREMENTS.

ANY CURB AND GUTTER OR ASPHALT OR CONCRETE PAVEMENT, WHICH IS TO REMAIN AND IS DAMAGED AS THE RESULT OF THE CONTRACTOR'S OPERATION, SHALL BE REPLACED AT THE CONTRACTOR'S EXPENSE.

FOR PRELIMINARY PLAN QUANTITIES OF PAVEMENT MATERIALS, THE FOLLOWING RATES OF APPLICATION WERE USED:

A TACK COAT IS REQUIRED BETWEEN LAYERS OF BITUMINOUS PAVEMENT. DILUTED EMULSIFIED ASPHALT FOR TACK COAT SHALL CONSIST OF 1 PART EMULSIFIED ASPHALT AND 1 PART WATER.

WHERE NEW PAVEMENT IS TO ABUT EXISTING PAVEMENT, THE EXISTING PAVEMENT SHALL BE REMOVED TO A NEAT VERTICAL LINE USING A CUTTING SAW OR OTHER METHOD AS APPROVED BY THE ENGINEER. SAW CUTTING ASPHALT WILL NOT BE PAID FOR SEPARATELY, BUT SHALL BE INCLUDED IN THE WORK.

ANY LAYER OF BITUMINOUS PAVEMENT THAT IS TO HAVE A SUCCEEDING LAYER PLACED THEREON SHALL BE COMPLETED FULL WIDTH BEFORE A SUCCEEDING LAYER IS PLACED.

ASPHALT PATCHING SHALL BE TO THE DEPTH OF THE SURROUNDING EXISTING PAVEMENT AS DIRECTED BY THE ENGINEER. THICKNESS OF SUBSEQUENT LIFTS MUST BE EQUAL OR GREATER THAN THE LIFT DIRECTLY ABOVE. THE MINIMUM LIFT THICKNESS SHALL BE 2 AND 3 INCHES RESPECTIVELY.

PRIOR TO PLACING BITUMINOUS PAVEMENT, THE PAVED SURFACE SHALL BE SWEPT AND CLEANED. THIS WILL NOT BE PAID FOR SEPARATELY, BUT SHALL BE INCLUDED IN THE COST OF THE HOT MIX ASPHALT PAVEMENT ITEM.

WATER SHALL BE USED AS A DUST PALLIATIVE WHERE REQUIRED. LOCATIONS SHALL BE AS DIRECTED BY THE ENGINEER. WATER FOR DUST PALLIATIVE WILL NOT BE PAID FOR SEPARATELY, BUT SHALL BE INCLUDED IN THE WORK.

MOISTURE-DENSITY CONTROL WILL BE REQUIRED FOR THE FULL DEPTH OF THOSE EMBANKMENTS ON THIS PROJECT.

EXCAVATION REQUIRED FOR COMPACTION OF BASES OF CUTS AND FILLS WILL BE CONSIDERED AS SUBSIDIARY TO THAT OPERATION AND WILL NOT BE PAID FOR SEPARATELY.

TYPE OF COMPACTION FOR THIS PROJECT WILL BE AASHTO T-99 FOR COHESIVE SOILS AND T-180 FOR GRANULAR SOILS AS DESCRIBED IN SECTION 203.07 OF THE CDOT STANDARD SPECIFICATIONS.

THE MINIMUM THICKNESS OF TOPSOIL SHALL BE 6 INCHES. TOPSOIL SHALL BE OBTAINED FROM A CONTRACTOR SOURCE APPROVED BY THE ENGINEER. IF THE TOPSOIL IS NOT GENERATED WITHIN THE PROJECT LIMITS, IT SHALL BE TREATED WITH AN HERBICIDE APPLICATION AFTER PLACEMENT AND BEFORE NATIVE SEEDING.

TO PROVIDE FOR ADEQUATE SULFATE RESISTANCE IN ALL CONCRETE SUPPLIED FOR THIS PROJECT, SEVERITY OF POTENTIAL EXPOSURE IS CLASS 0. THE CONTRACTOR MAY AT HIS OWN EXPENSE HAVE A CERTIFIED LABORATORY TEST THE SUBGRADE AS PER THE FIELD MATERIALS MANUAL. TESTING SHALL BE THE SAME SCHEDULE AND FREQUENCY AS REQUIRED FOR A PRELIMINARY SOILS SURVEY. THE CONTRACTOR MAY PROPOSE A DIFFERENT CLASS OF EXPOSURE FOR THE PROJECT BASED ON THOSE TEST RESULTS.

THE CONTRACTOR SHALL PROTECT ALL EXISTING SURVEY MONUMENTATION DESIGNATED TO REMAIN FROM DAMAGE DURING CONSTRUCTION OPERATIONS. ANY MONUMENTS DISTURBED BY THE CONTRACTOR THAT ARE NOT DESIGNATED FOR RELOCATION, SHALL BE RESET AT THE CONTRACTOR'S EXPENSE. THE CONTRACTOR AND ENGINEER SHALL NOTE THOSE MONUMENTS IN THE FIELD PRIOR TO CONSTRUCTION. SEE TABULATION OF SURVEY FOR ADDITIONAL INFORMATION.

THIS PROJECT IS COVERED BY A COLORADO DISCHARGE PERMIT SYSTEM - STORMWATER CONSTRUCTION PERMIT (CDPS-SCP). ALL PERMIT REQUIREMENTS SHALL BE ADHERED TO BY THE CONTRACTOR. REFER TO STANDARD SPECIAL PROVISION REVISION OF SECTION 107 - TRANSFER OF STORMWATER PERMIT TO CONTRACTOR FOR ADDITIONAL INFORMATION.

THE CONTRACTOR WILL BE RESPONSIBLE FOR THE ACCEPTANCE AND CONTROL OF ALL SURFACE AND SUBSURFACE DRAINAGE AND GROUNDWATER ENTERING THE WORK AREA. THIS SHALL BE INCLUDED IN THE COST OF THE WORK.

UNLESS OTHERWISE DIRECTED BY THE ENGINEER, THE CONTRACTOR SHALL LIMIT CONSTURCTION ACTIVITIES TO THOSE AREAS WITHIN THE LIMITS OF DISTURBANCE AND/OR TOES OF SLOPE AS SHOWN ON THE PLANS. ANY DISTURBANCE BEYOND THESE LIMITS SHALL BE RESTORED TO ORIGINAL CONDITION BY THE CONTRACTOR AT THEIR OWN EXPENSE. CONSTRUCTION ACTIVITIES IN ADDITION TO NORMAL CONSTURCTION PROCEDURES SHALL INCLUDE THE PARKING OF VEHICLES OR EQUIPMENT, DISPOSAL OF LITTER AND ANY OTHER ACTION WHICH WOULD ALTER EXISTING CONDITIONS.

CONSTUCTION VEHICLES SHALL ACCESS THE PROJECT FROM PUBLIC PROPERTY, NOT FROM ADJACENT PRIVATE PROPERTIES UNLESS DIRECTED BY THE ENGINEER.

THE FIELD OFFICE, LABORATORY AND ASSOCIATED PARKING (MINIMIMUM 8 SPACES) SHALL BE SECURELY FENCED WITH FENCE CHAIN LINK (72-INCH) AND A LOCKING GATE. FIVE SETS OF KEYS FOR LOCKING THE GATE SHALL BE PROVIDED TO THE ENGINEER. THE OFFICE AND LABRATORY SHALL BE LOCATED IN THE RAINBOW FALLS PARKING LOT OFF OF SERPENTINE DRIVE.

THE CONTRACTOR SHALL BE RESPONSIBLE FOR RESTORING THE FIELD FACILITY AND PARKING AREA TO ITS INITIAL CONDITION AT THE CONCLUSION OF THE PROJECT.

THE CONTRACTOR SHALL POST SIGNS INDICATING THE RAINBOW FALLS PARKING AREA AND TRAIL ARE CLOSED TO CARS AND PEDESTRIANS. THE CONTRACTOR WILL BE RESPONSIBLE FOR SECURITY OF THE STAGING AREA.

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Site Description

Additional information for permitted projects. For information only to fulfill the CDPS-SCP (Colorado Discharge Permit - Stormwater Construction Permit)

- A. <u>Project Site Description</u>: Work includes US24 erosion control mitigation that is required due to results of the 2012 Waldo Canyon fire. Five principal areas adjacent to US24 have been identified by CDOT as requiring erosion and post-fire stormwater mitigation. They are:
 - a. Pour Point A- Sand Gulch- Work includes stabilizing the eroded area at the inlet and outlet ends of an existing box culvert under US24. Maintenance access, a debris rack, and a debris settling area will be constructed.
 - b. Pour Point B- Wellington Gulch- Work includes improving the entrance to an existing corrugated metal pipe. Maintenance access, a debris rack and a debris settling area will be constructed.
 - c. Pour Point C- Cascade- Work includes installing a concrete rundown at the north bank of US24. A debris settling area will also be constructed. A series of existing culverts under US24 will be cleaned and their entrances will be improved. One new US24 culvert will be added.
 - d. Pour Point H- Waldo Canyon- Work includes improving the entrance to an existing corrugated metal pipe. Re-grading and access will be improved.
 - e. Pour Point J- Rainbow Falls Access Road- Fountain Creek bank erosion has occurred due to increased flows since the 2012 fire. Work includes construction of boulder toe wall at the creek and a 450 feet length of adjacent access road. The access road will connect to the existing access located north of Serpentine Drive and end south of Manitou Street. The steep slope between the access and US 24 will be re-graded to a more stable 1 % to 1 slope with a wire mesh cover. A soil nail retaining wall will be constructed at the top of the slope (adjacent to US24). Riprap erosion protection will extend up from the access road to one foot above the 100-year flood elevation.
- B. Proposed Sequencing For Major Activities: Work will include initial stabilization of the site perimeters, diversion of drainages as needed, clearing and grubbing, embankment placement, excavation, boulder or concrete placement, wall construction, grading, slope treatment and final stabilization of the site. Erosion control will be required throughout the construction period. Erosion control devices will be added as listed under section 4C of this document, repaired, modified and maintained as required in order to limit erosion and sedimentation within the project site.
- C. Acres Of Disturbance:

Total area of construction site: 16.66 acres Total area of disturbance: 3.35 acres Acreage of seeding: 2.74 acres

- D. <u>Existing Soil Data</u>: Pendant-Rock outcrop complex, Sphinx, warm-Rock outcrop complex, very slow infiltration rate with high runoff potential when thoroughly wet. The soils consist chiefly of clays that have a high shrink-swell potential, soils that have a high water table, soils that have a claypan or clay layer at or near the surface and soils that shallow over nearly impervious material. These soils have a very slow rate of water transmission.
- E. <u>Existing Vegetation</u>, <u>Including Percent Cover</u>: Existing vegetation consists of native grasses, weeds, sparse trees and shrubs. The estimated percent of ground cover averages about 50 percent cover over the project site.
 Date of survey: November 2012.
- F. <u>Potential Pollutants Sources</u>: See First Construction Activities under Potential Pollutant Sources. The ECS shall prepare a list of all potential pollutants and their locations in accordance with subsection 107.25.
- G. Receiving Water:
 - Outfall locations: The plan sheets show the outfall locations. The ultimate outfall is to Fountain Creek via existing tributary culverts, swales and sheet flows from the US 24 embankment adjacent to Fountain Creek.
 - 2. Names of receiving water(s) on site and the ultimate receiving water: Fountain Creek

- 3. Distance ultimate receiving water is from project: Varies between 0 and 1000 feet.
- 4. Does the receiving water have an approved TMDL: No
- H. Allowable Non-Stormwater Discharges: It is anticipated that dewatering may be required due to shallow ground water in areas of the Fountain Creek Access Road. There are no other anticipated allowable sources of non-stormwater components of the discharge, such as uncontaminated springs, landscape irrigation return flow, dust suppression and fire fighting. Dewatering shall be included in the cost of the work and will not be paid for separately. If encountered, that contractor shall take the following measures:
 - 1. Groundwater and stormwater dewatering: Discharge to the ground of water from construction dewatering activities may be authorized provided that:
 - a. The source is groundwater and/or groundwater combined with stormwater that does not contain pollutants.
 - b. The source and BMPs are identified in the SWMP.
 - c. Discharges do not leave the site as surface runoff or to surface waters.
 - If discharges do not meet the above criteria a separate permit from the Department of Health will be required. Contaminated groundwater requiring coverage under a separate permit may include groundwater contaminated with pollutants from a landfill, mining activities, industrial pollutant plumes, underground storage tank, etc.

I. Environmental Impacts:

- 1. Wetland Impacts: Yes
- 2. Stream Impacts: Yes
- 3. Threatened and Endangered Species: No

Site Map Components

Pre-construction

- A. Construction Site Boundaries: See Grading and Erosion Control Plans.
- B. All Areas Of Ground Surface Disturbance: See Grading and Erosion Control Plans.
- C. Areas Of Cut And Fill: See Grading and Erosion Control Plans.
- D. Location Of All Structural BMPs Identified In The SWMP: See Grading and Erosion Control Plans.
- E. Location of Non-Structural BMPs As Applicable In The SWMP: See Grading and Erosion Control Plans.
- F. Springs, Stream, Wetlands And Other Surface Water: See Grading and Erosion Control Plans.
- G. Protection of Trees, Shrubs, Cultural Resources And Mature Vegetation: See Grading and Erosion Control Plans.
- 3. SWMP Administrator For Design: Edward L. Lind, P.E., Water Resources Engineer for Felsburg Holt & Ullevig, is responsible for developing the SWMP sheets during the design.

4. Stormwater Management Controls First Construction Activities

The Contractor Shall Perform The Following:

- A. <u>Designate A SWMP Administrator/Erosion Control Supervisor</u> (To be filled out at time of construction; designate the individual(s) responsible for implementing, maintaining and revising SWMP, including the title and contact information. The activities and responsibilities of the administrator shall address all aspects of the projects SWMP.)
- B. <u>Potential Pollutant Sources</u>: Evaluate, identify and describe all potential sources of pollutants at the site in accordance with subsection 107.25 and place in the SWMP notebook. All BMPs related to potential pollutants shall be shown on the SWMP site map by the contractor's ECS.
- C. <u>Best Management Practices</u> (BMPs) For Stormwater Pollution Prevention Phased BMP Implementation

During design: fields are marked when used in the SWMP. During construction: the ECS shall update the checked boxes to match site conditions. Clearly describe the relationship between the phases of construction and the implementation of BMP controls. Add a narrative to the table or to the site map describing why the BMPs are being used in specific locations.

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Unit Information Unit Leader Initials					Colorado Springs, CD 80806	Revised:	Designer: CDT Structure	19358
FELSBURG South Syracuse Way					DEPARTMENT OF TRANSPORTATION Phone: 719-227-3201 FAX: 719-227-3298		Detailer: KLT Numbers	
HELSBURG Suite 600 HOLT & Centennial, CO 80111 ULLEVIG (303) 721–1440	0				Region 2 LM	Void:	Sheet Subset: EROSION Subset Sheets: SW-1 of	3 Sheet Number 10

Structural BMP practices for erosion and sediment control; practices may include, but are not limited to:

ВМР	TYPE OF CONTROL	BMP as Designed	on	FIRST CONSTRUCTI ON ACTIVITIES	DURING CONSTRUCTION	INTERIM/FINAL STABILIZATION
Earth Berm/Diversion	erosion	×		×	x	
Check Dams	sediment					
Silt Fence	sediment	×		×	x	
Erosion Logs	sediment	×		×	x	х
Temporary Sediment Trap/Basin	sediment	×		×	x	
Permanent Sediment Trap/Basin	sediment					
Embankment Protector	erosion					
Inlet Protection	erosion					
Outlet Protection	erosion					
Concrete Washouts	construction	x		×	x	
Stabilized Construction Entrance	construction	×		×	x	
Dewatering	sediment	×			x	
Temporary Stream Crossing	erosion	x		×	×	
Other		7				

NON-STRUCTURAL BMP practices for erosion and sediment control; practices may include, but are not limited to:

вмр	Type Of	BMP As Designed	In Use On Site	First Construction Activities	During Construction	Interim/Final Stabilization
Surface Roughening/Grading Techniques	Erosion	x		×	x	x
Seeding Permanent	Erosion	×				×
Seeding Temporary	Erosion	×			×	
Mulch/Mulch Tackifier	Erosion	×			×	×
Soil Binder	Erosion	×			x	
Soil Retention Blanket	Erosion	×			×	×
Vegetative Buffer Strips	Erosion	×		×	×	x
Protection Of Trees	Erosion	×		×	x	
Preservation Of Mature Vegetation	Erosion	×		×	×	х
Other						

- Erosion control devices are used to limit the amount of erosion on site.
- · Sediment control devices are designed to capture sediment on the project site,
- · Construction control are BMPs related to construction access and staging.
- BMP locations are indicated on the erosion control plans.
- BMP installation details and general narratives are in the SWMP notebook.

D. Offsite Drainage (Run On Water)

1. Describe and record BMPs on the SWMP site map that has been implemented to address runon water in accordance with subsection 208.03.

E. Stabilized Construction Entrance/Vehicle Tracking Control

1. BMPs shall be implemented in accordance with subsection 208.04.

F. Perimeter Control

- 1. Perimeter control shall be established as the first item on the SWMP to prevent the potential for pollutants leaving the construction site boundaries, entering the stormwater drainage system, or discharging to state waters.
- 2. Perimeter control may consist of vegetation buffers, berms, silt fence, erosion logs, existing landforms, or other BMPs as approved.
- 3. Perimeter control shall be in accordance with subsection 208.04.

During Construction

Responsibilities of the SWMP administrator/erosion control supervisor during construction.

The SWMP should be considered a "living document" that is continuously reviewed and modified. During construction, the following items shall be added, updated, or amended as needed by the SWMP Administrator/Erosion Control Supervisor (ECS) in accordance with section 208.

- A. Materials Handling and Spill Prevention
- B. Stockpile Management
- C. Grading and Slope Stabilization
- D. Surface Roughening
- E. Vehicle Tracking
- F. Temporary Stabilization
- G. Concrete Washout- Concrete washout water or waste from field laboratories and paving equipment shall be contained in accordance with subsection 208.05.
- H. Saw Cutting
- I. New Inlet/Culvert Protection
- J. Street Cleaning

Inspections

A. Inspections shall be in accordance with subsection 208.03 (c).

BMP Maintenance

A. Maintenance shall be in accordance with subsection 208.04 (e).

Record Keeping

A. Records shall be in accordance with subsection 208.03 (c).

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9. Interim And Final Stabilization

A. Seeding Plan

Soil preparation, soil conditioning or topsoil, seeding (native), mulching (weed free), and mulch tackifier will be required for the area of disturbed area within the right-of-way limits which are not surfaced. The following types and rates shall be used:

COMMON NAME	BOTANICAL NAME	LBS, PLS PER ACRE
Blue grama	Bouteloua gracilis 'Hachita'	0.5
Arizona fescue	Festuca arizonica 'Redondo'	1.0
Sheep fescue	Festuca ovina	0.6
Canada wildrye	Elymus canadensis	6.2
Sandberg bluegrass	Poa sandbergii	0.2
Western wheatgrass	Pascopyrum smithii 'Rosanna'	6.5
Mountain brome	Bromus marginatus 'Bromar'	4.0
Prairie junegrass	Koeleria macrantha	0.1
Slender wheatgrass	Elymus trachycaulus ssp. trachycaulus 'Pryor'	1.0
Oats	Avena sativa	3.0
TOTAL		23.1

- A. Seeding Application: Drill seed 0.25 inch to 0.5 inch into the soil. In small areas not accessible to a drill, hand broadcast at double the rate and rake 0.25 inch to 0.5 inch into the soil. In areas as directed by Engineer, hydro-seed shall be applied at double the rate, in a single slurry which contains seed, mulch tackifier, humate and fertilizer. Slurry shall be applied from top of slope downward, in 50' vertical lifts unless otherwise approved by the Engineer.
- B. Mulching Application: Apply a minimum of 1 % tons of certified weed free native hay per acre and in accordance with Section 212, and mechanically crimp it into the soil in combination with an organic mulch tackifier.
- C. Soil Conditioning and Fertilizer Requirements: [Minimum requirements for all disturbances to receive seeding (native).

Soil conditioner pa	id for as Item 212- Soil	Conditioning (Acre)
Biological nutrient organi based fertilizer (lbs/acre)*	c Humate (lbs/acre)	
699	200	

*Biological nutrient shall not exceed 8-8-8 (N-P-K). Humate based material shall be in accordance to Section 212.

- F. <u>Blanket Application</u>: On slopes and ditches requiring a blanket, the blanket shall be placed in lieu of mulch and mulch tackifier. See SWMP for blanket locations.
- G. Reseeding Operations/Corrective Stabilization:

Prior to Final Acceptance:

- Seeded areas shall be reviewed during the 14 day inspections by the Erosion Control Supervisor for bare soils caused by surface or wind erosion. Bare areas caused by surface or gully erosion, blown away mulch, etc. shall be regraded, seeded, mulched and have mulch tackifier (or blanket) applied as necessary.
- Areas where seed has not germinated after one season shall be evaluated by the Engineer and CDOT Landscape Architect. Areas that have not germinated shall have seed, mulch and mulch tackifier (or blanket) applied. Work shall be paid for by the appropriate bid item.
- The Contractor shall maintain seeding/mulch/tackifier, mow to control weeds or apply herbicide to control weeds in the seeded areas until final acceptance.

10. Prior To Final Acceptance

A. Final acceptance shall be in accordance with subsection 208.061.

Print Date: 3/18/2013			Sheet Revisions		Colorado Department	of Transportation	As Constructed	US 24 WALDO CANYON STORMWATER MANAGEMENT PLAN		Project No.,	./Code		
File Name: 19358DES_SWMP03.dgn Horiz. Scale: 1:1 Vert. Scale: As	loted —	Date:	Comments	Init.	· ·	·	No Revisions:			NH 0242-0	056		
Unit Information Unit Leader					C DOT 1480 Quail Lal Colorado Spri	ngs, CD 80806	Revised:	Designer:	CDT	Structure		19358	
FELSBURG 6300 South Syracuse Way Suite 600 HOLT & Centennial, CO 80111					DEPARTMENT OF TRANSPORTATION Phone: 719-22	7-3201 FAX: 719-227-3298		Detailer:		Numbers			
HOLT & Centennial, CO 80111 ULLEVIG (303) 721-1440		1			Region 2	LM	Void:	Sheet Subset:	EROSION	Subset Sh	heets: SW-3 of 3	Sheet Number	12

TO ESTABLISH GEOMETRIC CONTROL FOR PROJECT, THE DEPARTMENT HAS PROVIDE						Pavements — ■ HMA - Hot Mix Asphalt (Section 403)	Grid S (Y/N) In	pecial Special terval Offset	_	Pavement Marking (Section Striping (Temp)	n 627)	
Horizontal Control Vertical Control Roadway Alignment Original Terrain Data Other:		_				— Concrete (Section 412) — Heating & Scarifying Treatment — Prime Coat, Tack Coat & Rejuvenating (Section 407) — Seal Coat or Chip Seal (Section 409) — Other:	Agent		_	🗀 Light pole locat	itions and elevations (Temp)	es (Section 630)
 Specify the information format, ie., plan she The information marked is either contained of 						■ Roadway Elements	ကြည်း Interval In	Curve Special terval Offset		— □ Sign Locations □ □ Other: □ □ Easements (Temp Staking	<u>'</u>	
TYPE OF PROJECT Landscaping	Major Recor	actruction			_	Curb and Gutter (Section 609) Drop inlets -	Cur		_	— ■ Right of Way (Temp Sta	, ,	
Signalization Safety Improvement Asphalt Overlay Concrete Overlay	New Roadwa Bridge Repla Bridge Wider New Bridge	ay Constructio acement ning				alignment and grades (Section 60 Retaining Walls Guard Rail (Section 606) Sidewalk (Section 608) Overlay Stationing Other: Cutoff Walls	p Left (Center Right terval Interval		PERFORMED BY THE CON Monumentation (Section 6 Control Right of Way		NDER SECTION 629:
•		Š	Š			Riprap (Perm) (Section 506)				□ Land corners, , □ Easements	'	
SURVEY WORK TO BE PERFORMED BY OTHERS:						■ Slope and Ditch Paving (Section 507) ■ Minor Structures				□ Replace the sp	specified existing monuments:** - ecified existing monuments: ** - nts. It is estimated hours o	
WORK PERFORMED BY THE CONTRACTOR'S — Establish and Maintain Project Centerline	or Engineer	Approved Of			_	Structure Excavation limits (Section 206 Culverts (Section 603) Culverts w/ Headwalls and Wingwalls (Se				NOTE: All 629 items shall i of evidence for m	nclude adequate research, calculat onuments to be set.	ions, and evaluations
 Verification and Maintenance of Horizont Verify or Determine existing grades and Verify or Determine existing topography 	alignments	cal Control				Concrete Box Culverts w/ Headwalls an			GENERAI	** A Tabulation of Surve L NOTES:	ey Monuments may be provided (on the plans.
— Clearing and Grubbing Limits (Section 20 — Removal Limits (Section 202))1)					Sanitary Sewer Storm Sewer Water			1. Unless	indicated otherwise on this Survey ne in accordance with the latest edit		d staking intervals shall
— Reset Items (Section 210) — Excavation and Embankment (Section 20 — Excavation)3) Slop	oe Staking (Y/N) (Grade Special Stakes Interval		☐ ☐ Irrigation ☐ ☐ Miscellaneous ☐ ☐ Manholes (Section 604)			on the	ate information for establishing lines, plans. Any additional information req intractor's surveyor.	grades, and locations for all work it uired to stake the item or elemen	ems have been specified t shallbe generated by
— Unclassified	Excavation	- - - -	- - -			☐ ☐ Inlets (Section 604) ☐ ☐ Other: ☐ ☐ Other: ☐ ☐ ☐ ☐ ☐ ☐ ☐ ☐ ☐ ☐ ☐ ☐ ☐ ☐ ☐ ☐ ☐ ☐ ☐			3. The Col items i blank li	ntractor's surveyor shall provide an indicated on this sheet. A copy of the to the left of the specified itemer7 days prior to the Presurv	nis sheet, with the estimated man-h s, shall be submitted with the Surve	ours written on the y Schedule to the
— □ Other: — Potholing		-	-			and all other structures assig Structure Excavation limits (Section 200 Concrete Box Culverts (Section 603) w	6)			and Monuments which are damaged ed by the Contractor at no addition		construction shall be
	Embankment	- - -	- - -			 Piling locations and cut off elevations (Sectic Caisson locations and elevations (Sectic Footing locations, alignment, and elevati Abutment/Pier locations, alignment, and Wingwall skew angles/offsets 	Section 502) on 503) ons	ins (Section 66)	twenty copy o	ntractor shall furnish an As Staked e percent (20%) of the planned earth of the As Staked earthwork data an Engineer. The Contractor shall field ils.	work in any phase as per the CDOT d a computer disk in the specified	Survey Manual. A printed format shall be submitted
(See General Notes)						 Structural concrete form locations Substructure As-constructed survey required for Bridges (Subsection 	601 .12) and Overhead	sians (S-614-50)	6. Prior to Contra	o beginning work on any subsequent ctor shall certify in writing to the Er	operation, such as placing base congineer that the final grade is within	urse or paving, the specified tolerance.
Landscaping — Top Soil (Section 207) — Seeding (Section 212)						□ Bridge expansion joint(s) alignment and □ Deck grades at Girder 10th or "n" th □ Slope and Ditch Paving (Section 507)	grade (longitudinal and	transverse)	into fie	ntractor's surveyor shall perform al eld grades.	, ,	, , ,
Mulching (Section 213) Planting (Section 214) Herbicide (Section 217) Other: Section 208) Seeding (Temp) Silt Fence Frosion Bales					_	 Other: Ground Nailed Wall, Geogrid Rei Fencing (Section 607) Temporary Permanent Sound Barrier Other: 	nforcement, Wire Mesh		9. Fieldbo shall co informo copy f linear s measur	ntractor shall coordinate construction obes shall contain daily records of prontain: date, crew members' names, pation is collected electronically, inforformat that is intuitive, clear and relative, such as slope stakes and the red information. Non-linear surveys station, such as point numbers, to the	oints set and or measurements obsection too., description, staking information recorded shall be provided the steed to the supplemental information libe tops, shall have the station and such as structures staking shall have	erved. The information recorded tion, and sketches. If the survey o the Project Engineer in a hard recorded in the field books. All offset information related to the
■ Erosion Logs □ Riprop (Temp)						☐ Delineators (Section 612) ☐ ☐ Temporary ☐ ☐ Permanent				intractor's surveyor shall submit the	,	:
Other: Rock Check Dam, Tem Roadway Bases Untreated Subgrade Treated Subgrade	porary Divers		Grade (Y/N)	Special Special Interval Offset	_	☐ Lighting (Section 613) and Traffic Control Devices ☐ ☐ Signal pole locations and elevations ☐ ☐ Light pole locations and elevations	(Permanent) (Section	614)	■ V ■ P ■ H	lorizontal Control (Primary & Secon /ertical Control (i.e. Benchmarks) Property Pin Ties lorizontal Alignment	aary)	
—	녉		- - -			Sign locations Field verify sign post locations, elevation Other:	ons, and lengths before	fabrication.	S M M	Grading Blope Staking Minor Structures Major Structures		
	_	<u>'</u>	'							One fieldbook for each work catego Other Fieldbook(s):	ry shown on this sheet	
Print Date: 4/22/2013	I		She	et Revisions		Colorado Department of Trans	portation	As Constr	ucted		DO CANYON	Project No./Code
File Name: 19358SURV_TabC.dgn Horiz. Scale: 1:1 Vert. Scale: As Note	ed (R=3)	Date: 04-22-13	REVIS	Comments SED SHEET NUMBER	Init. CDT	-l '	por tation	No Revisions:			ABULATION EET	NH 0242-056
Unit Information Unit Leader Initial						1480 QuailLake Loop Colorado Springs, CD 808 Phone: 719-227-3201 FAX	306 (: 719-227-3298	Revised:		Designer:	Structure Numbers	19358
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SUMMARY OF CONSTRUCTION TRAFFIC CONTROL ITEMS

	CONSTRUCTION TRAFFIC SIGNS (FOR INFORMATION	ONLY)			
SIGN CODE	LEGEND	DIMENSIONS	OVERALL PROJECT		
			OVERALL PROJECT EACH PANEL SIZE 10 A 8 A 5 A 5 B 5 B 3 A 4 B 4 B 3 B 5 B 3 B 5 B 3 B 4 B 4 B 4 B 4 B 3 B 5 B 3 B 2 B 3 B 4 B 4 B 4 B 4 B 5 B 5 B 6 B 6 B 6 B 76		
G20-5P	WORK ZONE	36" X 24"	10	Α	
R2-1(45)	SPEED LIMIT	36" X 48"			
R2-1(50)	SPEED LIMIT	36" X 48"			
R2-6P	FINES DOUBLE	36" X 24"			
R4-1	DO NOT PASS	36" X 48"			
R4-2	PASS WITH CARE	36" X 48"			
F52-6A	BEGIN FINES DOUBLE	36" x 48"			
R52-6B	END FINES DOUBLE	36" x 48"			
W4-2(R)	RIGHT LANE CLOSED SYMBOL	48" X 48"	3		
W21-5(R)	RIGHT SHOULDER CLOSED	48" X 48"	5		
W4-2(L)	LEFT LANE CLOSED SYMBOL	48" X 48"	3	В	
W20-1	ROAD WORK/ (DISTANCE/AHEAD)	48" X 48"	2	В	
W20-5(R)	RIGHT LANE CLOSED	48" X 48"	3	В	
W20-5(L)	LEFT LANE CLOSED	48" X 48"	3	В	
W20-7a	FLAGGER AHEAD (SYMBOL)	48" X 48"	4	В	
W21-1	WORKER (SYMBOL)	48" X 48"	4	В	
W16-2A	1500 FEET	24" X 36"	1	A	
SPECIAL	PARKING LOT CLOSED	48" X 48"	2	В	
SPECIAL	TRAIL CLOSED	48" X 48"	2	В	
	S	SIGN TOTALS	76		

GENERAL CONSTRUCTION TRAFFIC CONTROL NOTES

- 1. THE CONTRACTOR SHALL BE RESPONSIBLE FOR ALL TRAFFIC CONTROL REQUIRED ON THE PROJECT. ALL TRAFFIC CONTROL DEVICES, TEMPORARY CONSTRUCTION SIGNS, PAVEMENT MARKINGS AND CHANNELIZING DEVICES SHALL CONFORM WITH THE LATEST MUTCD AND THE CDOT M & S STANDARDS. THE PROJECT TRAFFIC CONTROL SUPERVISOR SHALL COORDINATE CONSTRUCTION ZONE TRAFFIC CONTROL ACTIVITIES WITH ALL APPROPRIATE AGENCIES AND ANY OTHER NEARBY CONSTRUCTION PROJECTS.
- 2. THE CONTRACTOR SHALL MAINTAIN MINIMUM 11 FOOT LANES DURING CONSTRUCTION, UNLESS OTHERWISE DIRECTED BY THE ENGINEER.
- 3. FLASHING BEACON (PORTABLE) SHALL BE INSTALLED ON "ROADWORK 1 MILE", AND "LANE CLOSED $\frac{1}{2}$ MILE" ADVANCE WARNING SIGNS.
- 4. PORTABLE MESSAGE SIGN PANELS SHALL BE USED AS NECESSARY, AND ONLY AS APPROVED BY THE FNGINFFR
- 5. VEHICLE ACCESS SHALL BE MAINTAINED FOR ALL STREETS, BUSINESSES AND PROPERTIES WITHIN THE PROJECT LIMITS.
- 6. OPEN EXCAVATIONS SHALL NOT BE ALLOWED TO BE UNPROTECTED WHEN CONSTRUCTION WORK IS NOT IN PROGRESS (INCLUDING OVERNIGHT, WEEKENDS, AND HOLIDAYS). METHOD(S) OF PROTECTING PEDESTRIANS AND TRAFFIC FROM EXCAVATIONS, SUCH AS METAL PLATES OR CONCRETE BARRIER, SHALL BE APPROVED BY THE ENGINEER. THE COST FOR PROTECTING EXCAVATIONS WILL NOT BE MEASURED AND PAID FOR SEPARATELY BUT SHALL BE INCIDENTAL TO THE PROJECT.
- 7. NO VERTICAL FACES GREATER THAN 3 INCHES SHALL BE LEFT WITHIN 6 FEET OF ANY TRAVEL LANE DURING NON-WORKING HOURS. ANY WORK AND MATERIAL NECESSARY TO PLACE A TEMPORARY FILL SLOPE FOR DROP-OFFS GREATER THAN 3 INCHES SHALL BE CONSIDERED INCIDENTAL TO THE WORK. ANY TEMPORARY FILL SLOPES SHALL HAVE A SLOPE NO STEEPER THAN 3:1.
- 8. ANY EXISTING SIGNS THAT CONFLICT WITH TEMPORARY SIGNS SHALL BE MASKED OR REMOVED. THE COST FOR MAINTAINING, RELOCATING, OR MASKING EXISTING SIGNS DURING CONSTRUCTION IS INCLUDED IN THE PRICE OF WORK.
- 9. FLAGGER SYMBOL SIGNS SHALL BE INSTALLED AND FLAGGERS SHALL BE UTILIZED ONLY AS DEEMED NECESSARY, AND ONLY AS APPROVED BY THE ENGINEER.
- 10. CONSTRUCTION WORK ON THE PROJECT SHALL NOT BEGIN UNTIL ALL ADVANCE CONSTRUCTION SIGNS ARE IN PLACE AND APPROVED BY THE PROJECT ENGINEER.
- 11. THE CONTRACTOR SHALL MAINTAIN EXISTING TRAFFIC SIGNS AND PRIVATE BUSINESS SIGNS AS NECESSARY TO ACCOMMODATE NEW CONSTRUCTION AND TRAFFIC MOVEMENTS AS APPROVED BY THE PROJECT ENGINEER. THIS SHALL BE DONE FOR THE DURATION OF THE PROJECT.
- 12. THE CONTRACTOR SHALL BE RESPONSIBLE FOR MAINTAINING TRAFFIC DURING CONSTRUCTION. THE CONTRACTOR SHALL SUBMIT FOR APPROVAL, PRIOR TO COMMENCING WORK, A METHOD OF HANDLING TRAFFIC PLAN
- 13. ALL TRAFFIC SHALL BE AS PER THE TRAFFIC CONTROL PLANS DEVELOPED BY THE CONTRACTOR, OR AS APPROVED BY THE PROJECT ENGINEER.
- 14. SIGNS SHALL NOT BE MOUNTED, FASTENED, OR ATTACHED TO ANY CHANNELIZING DRUMS OR CONES.
- 15. THIS PROJECT IS CLASSIFIED AS NON-SIGNIFICANT. THE CONTRACTOR SHALL FOLLOW 630 SPECIFICATIONS. THE TRANSPORTATION MANAGEMENT PLAN (TMP) PREPARED BY THE CONTRACTOR SHALL CONSIST OF A TRAFFIC CONTROL PLAN (TCP).
- 16. CONSTRUCTION INFORMATION SIGNS SHALL BE PLACED AT BEGINNING AND END OF OVERALL PROJECT.
- 17. STANDARD PLAN S-630-1 SHALL BE USED FOR CONSTRUCTION TRAFFIC CONTROL AS FOLLOWS:
 - POUR POINTS A AND B, USE CONTRACTORS MHT.
 - POUR POINT C, USE TRAFFIC CONTROL PLANS AND CONTRACTORS MHT.
 - POUR POINT H, USE TRAFFIC CONTROL PLANS.
 - POUR POINT J, USE TRAFFIC CONTROL PLANS.
- 18. A VMS SIGN SHALL BE PLACED AT EACH END OF THE PROJECT GIVING PROJECT INFORMATION; MESSAGE SHALL BE AS DIRECTED BY THE ENGINEER.



THE CONTRACTOR SHALL MAINTAIN TWO LANES OF TRAFFIC DURING THE WEEKDAY FROM 7AM TO 9AM AND 4PM TO 6PM. NO LANE CLOSURES SHALL BE PERMITTED DURING MEMORIAL DAY WEEKEND, LABOR DAY WEEKEND, 4TH OF JULY OR ANY OTHER HOLIDAY TRAVEL.

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Unit Information	Unit Leader Initials	æ				
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1480 QuailLake Loop
Colorado Springs, CD
Phone: 719-227-3201

Region 2

1480 QuailLake Loop
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Colorado Department of Transportation

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TABULATION OF POTHOLES

PLAN SHEET	POTHOLE NUMBER	UTILITY USE	DIAMETER (INCHES)	DEPTH TO TOP (FT)	DEPTH TO BOTTOM (FT)	NORTHING (APPROXIMATE)	EASTING (APPROXIMATE)	GROUND ELEVATION	COMMENTS
A-3	PH1	TELEPHONE	0.5	2.8	2.9	397684.75	146000.36	7642.15	FOUND 1/2" DIRECT BURY TELE
B-2	PH3	TELEPHONE	2	2.8	3.0	396123.35	148056.41	7568.41	FOUND 2" GAS LINE
B-2	PH4	GAS	108	13.0	22.0	396132.79	148086.93	7566.33	TOP OF 108" CMP PLUNGING STEEPLY
B-2	TH1	- D		4.0	6.0	396178.47	148115.98	7466.80	FIRST 4' SANDY GRAVEL, CRUMBLY ERODED ROCK TO 6', SOLID ROCK AT 6'
C-2	PH5	STORM			9.0	393945.78	150109.30	7526.00	NOTHING FOUND
C-2	PH6	GAS			9.0	393934.62	150098.67	7527.94	NOTHING FOUND
C-2	PH6A	WATER			9.0	393924.29	150087.22	7529.79	NOTHING FOUND
C-2	PH7	WATER		5.9	8.0	393658.44	150345.43	7505.74	NOTHING FOUND, PROBED TO 8'
C-2	PH7A	WATER			10.0	393655.40	150338.61	7508.83	NOTHING FOUND, PROBED TO 10'
C-3	PH8	WATER	0.5	5.0	5.1	393606.92	150426.73	7509.13	FOUND 1/2" TELE CONDUIT
C-3	PH9	TELEPHONE	2	5.0	5.3	393600.41	150417.65	7507.61	2" HDPE LINE
C-3	PH10	GAS			10.0	393585.66	150405.32	7504.67	NOTHING FOUND
C-3	PH11	WATER			11.0	393024.52	150963.04	7474.97	NOTHING FOUND
C-4	PH12	WATER		7.5	11.0	393427.65	150568.64	7485.36	NOTHING FOUND, PROBED TO 11'
C-4	PH13	WATER		8.0	10.0	392779.87	151201.75	7476.77	NOTHING FOUND, PROBED TO 10'
C-5	PH14	WATER			10.0	392551.13	151429.38	7482.42	NOTHING FOUND
C-5	PH15	WATER	4	5.3	5.6	392324.49	151649.41	7484.96	4" CONDUT - PROBED TO 10'
C-6	PH16	WATER	8	7.5	8.2	391908.87	151929.95	7484.06	FOUND 8" WATER LINE

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FELSBURG	6300 South Syracuse Way Suite 600			
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Colorado D	epartment of Tr	ansportation
DOT	1480 QuailLake Loop Colorado Springs, CO Phone: 719-227-3201	80806 FAX: 719-227-329

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POUR POINT A TABULATION

CONTRACT ITEM NO.	CONTRACTITEM	UNIT	QUANTITY
201-00001	CLEARING AND GRUBBING	LS	1
202-00010	REMOVAL OF TREE	EA	13
202-01000	REMOVAL OF FENCE	LF	99
202-04002	CLEAN CULVERT	EA	1.
203-00010	UNCLASSIFIED EXCAVATION (COMPLETE IN PLACE)	CY	893
203-01622	SWEEPING (WITH PICKUP BROOM)	HR	40
207-00205	TOPSOIL	CY	100
208-00002	EROSION LOG (12 INCH)	LF	208
208-00034	GRAVEL BAG	LF	40
208-00045	CONCRETE WASHOUT STRUCTURE	EA	2
208-00070	VEHICLE TRACKING PAD	EA	2
208-00103	REMOVAL AND DISPOSAL OF SEDIMENT (LABOR)	HR	80
208-00105	REMOVAL AND DISPOSAL OF SEDIMENT (EQUIPMENT)	HR	40
208-00205	EROSION CONTROL SUPERVISOR	DAY	30
210-01050	RESET CHAIN LINK FENCE	LF	12
212-00006	SEEDING (NATIVE)	AC	0.3
212-00032	SOIL CONDITIONING	AC	0.3
213-00002	MULCHING (WEED FREE)	AC	0.3
214-00450	EVERGREEN TREE (5 GALLON CONTAINER)	EA	13
216-00041	SOIL RETENTION BLANKET (STRAW/COCONUT)	SY	512
304-06000	AGGREGATE BASE COURSE (CLASS 6)	CY	11
420-00102	GEOTEXTILE (EROSION CONTROL) (CLASS 1)	SY	192
506-00030	GROUTED RIPRAP	CY	51
506-00412	SOIL RIPRAP (12 INCH)	CY	94
507-00725	SLOPE AND DITCH PAVING (SPECIAL)	CY	22
601-01000	CONCRETE CLASS B	CY	43
607-01000	FENCE BARBED WIRE WITH METAL POSTS	LF	120
608-00100	REINFORCED GRASS/CONCRETE POROUS PAVEMENT	SY	354
615-00620	LOG DEFLECTOR	EA	1

NOTE: TREES SHALL BE PLACED AS DIRECTED BY THE ENGINEER.

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воок	PAGE	SHEET	ITEM	PROJECT TOTALS
			EMBANKMENT MATERIAL (CIP) (FOR INFO. ONLY)	CU. YDS.
			SAND GULCH	143
			SUBTOTAL	143
			TOTAL	143
			UNCLASSIFIED EXCAVATION	CU. YDS.
			SAND GULCH	893
			OTHER EXCAVATION	0
			SUBTOTAL	893
			TOTAL FOR PAY QUANTITY	893

COMPACTION (FOR INFORMATION ONLY) (MOISTURE & DENSITY CONTROL) EMBANKMENT (NET)	143
TOTAL	143
WETTING QUANTITIES (FOR INFORMATION ONLY) COMPACTION	M. GAL.
(143 x 0.040 M. GAL./yd) TOTAL	6
ACCESS ROAD QUANTITIES BALANCE (FOR INFORMATION ONLY)	CU. YDS.
EMBANKMENT (NET)	143
EMBANKMENT X FACTOR (1.15)	164
BALANCE TOTAL	164
UNCLASSIFIED EXCAVATION TO BE EXPORTED BY THE CONTRACTOR BALANCE TOTAL	893 -729 164


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	Sheet Revisions	
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Colorado Department of Transportation 1480 Quail Lake Loop Colorado Springs, CO 80 Phone: 719-227-3201 FA

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	As Constructed	US 24 WALDO CANYON				US 24 WALDO CANYON Project No./Co		/Code
	No Revisions:	POUR POINT A - SAND GULCH			NH 0242-0)56		
ſ	Revised:	Designer:		Structure			19358	
ŀ		Detailer:	KLT	Numbers				
_	Void:	Sheet Subset:	TAB	Subset She	ets:	A-1 OF 14	Sheet Number	16



Void:


Sheet Subset: DRAINAGE

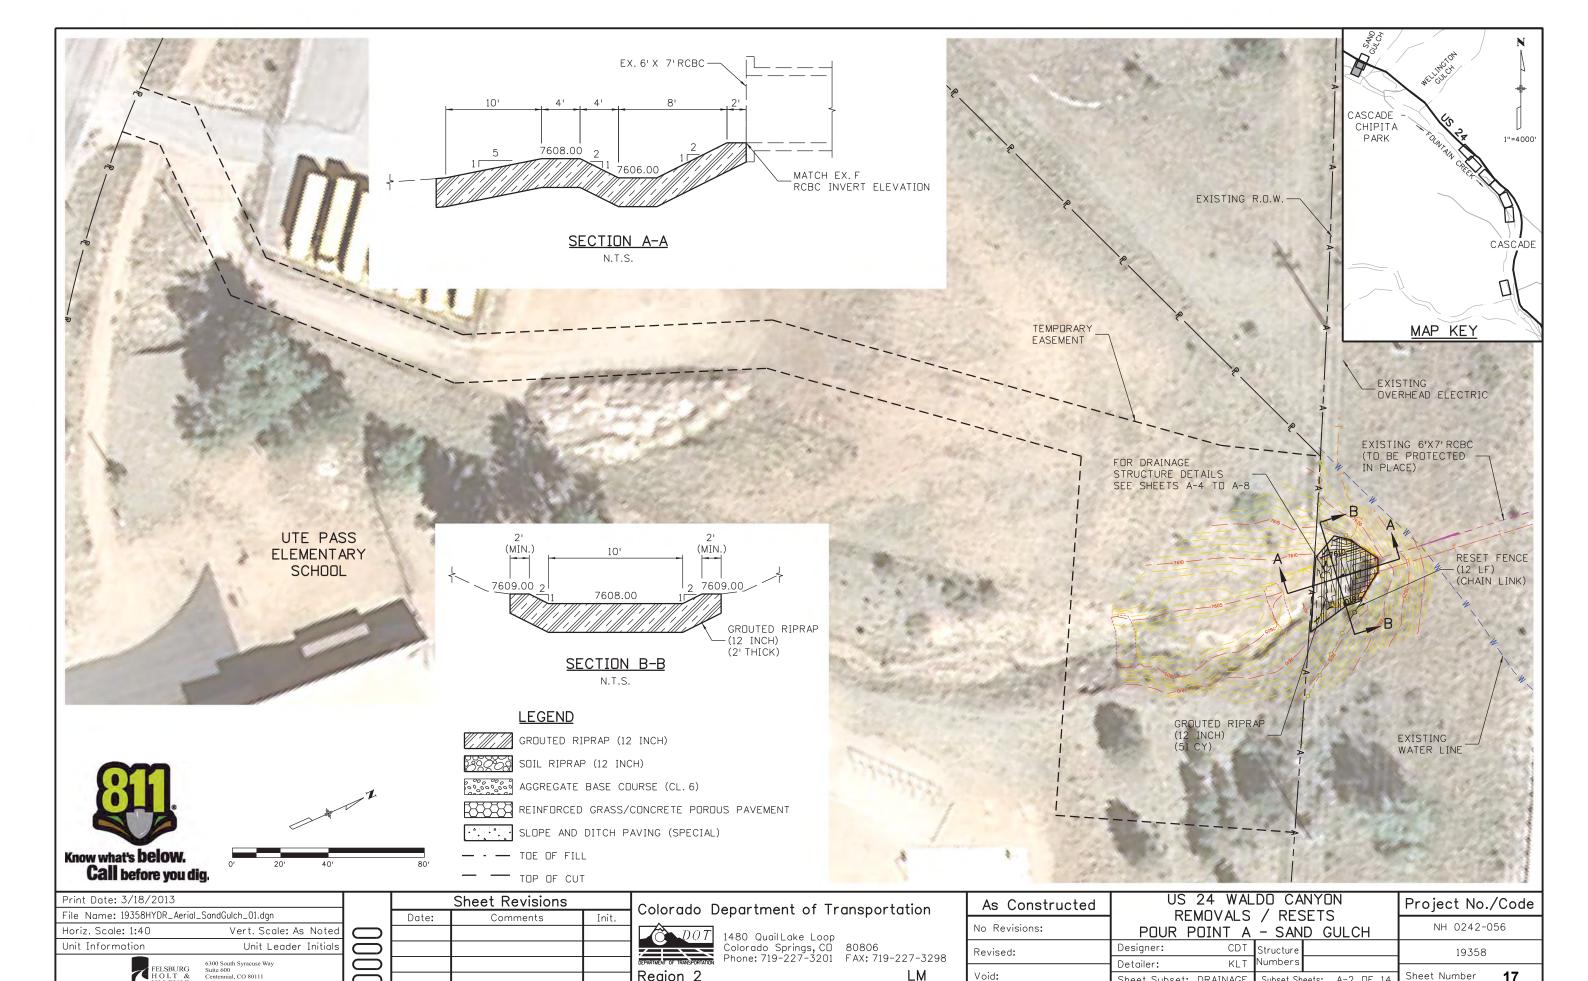
Sheet Number

Subset Sheets: A-2 OF 14


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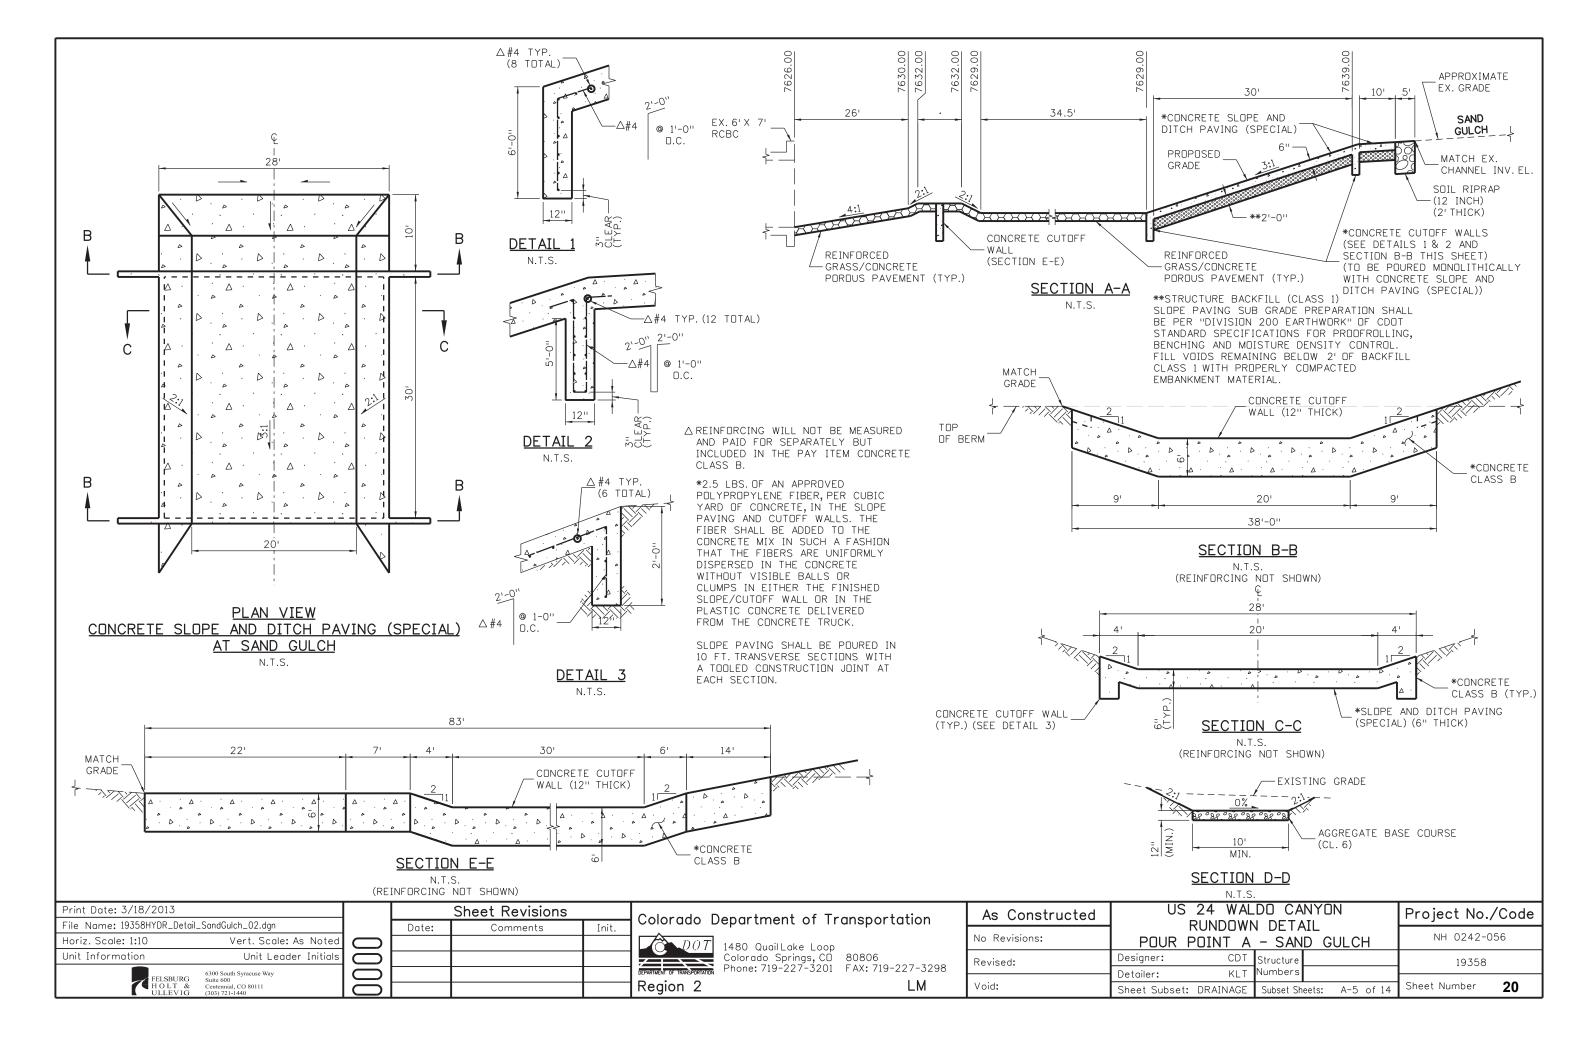


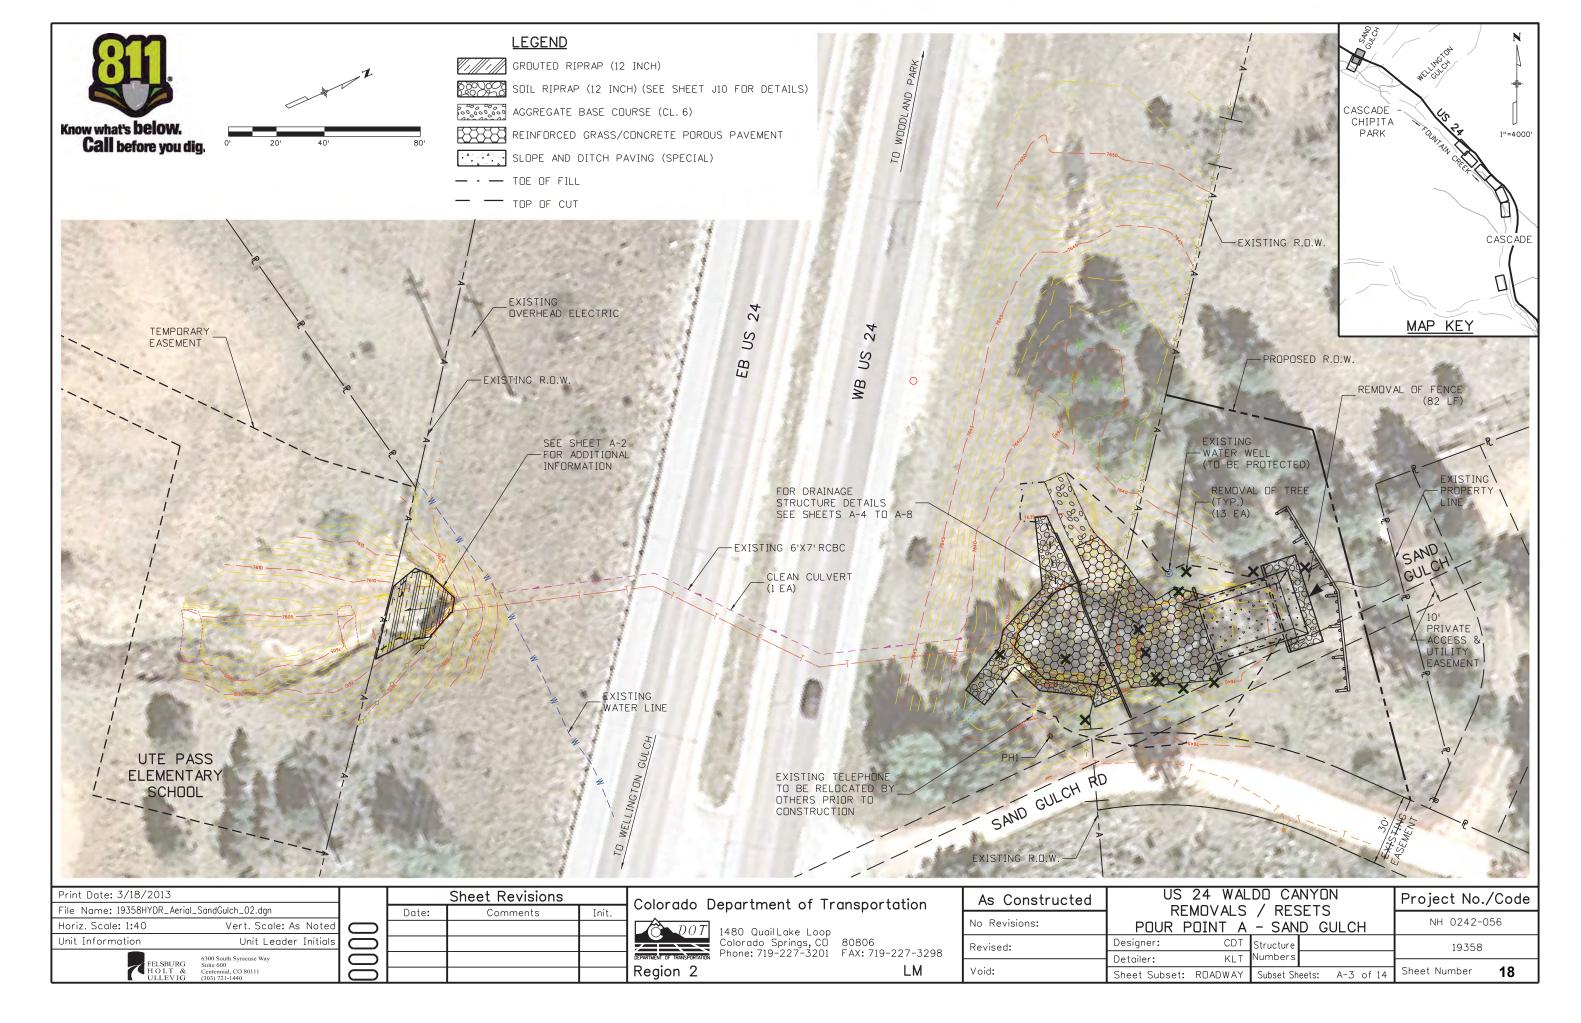

Colorado	Department of Tr	anspor	tatio	on
DOT	1480 QuailLake Loop Colorado Springs, CD	80806		
	Discrete 710, 007, 7001	E 4 V - 710	227	70

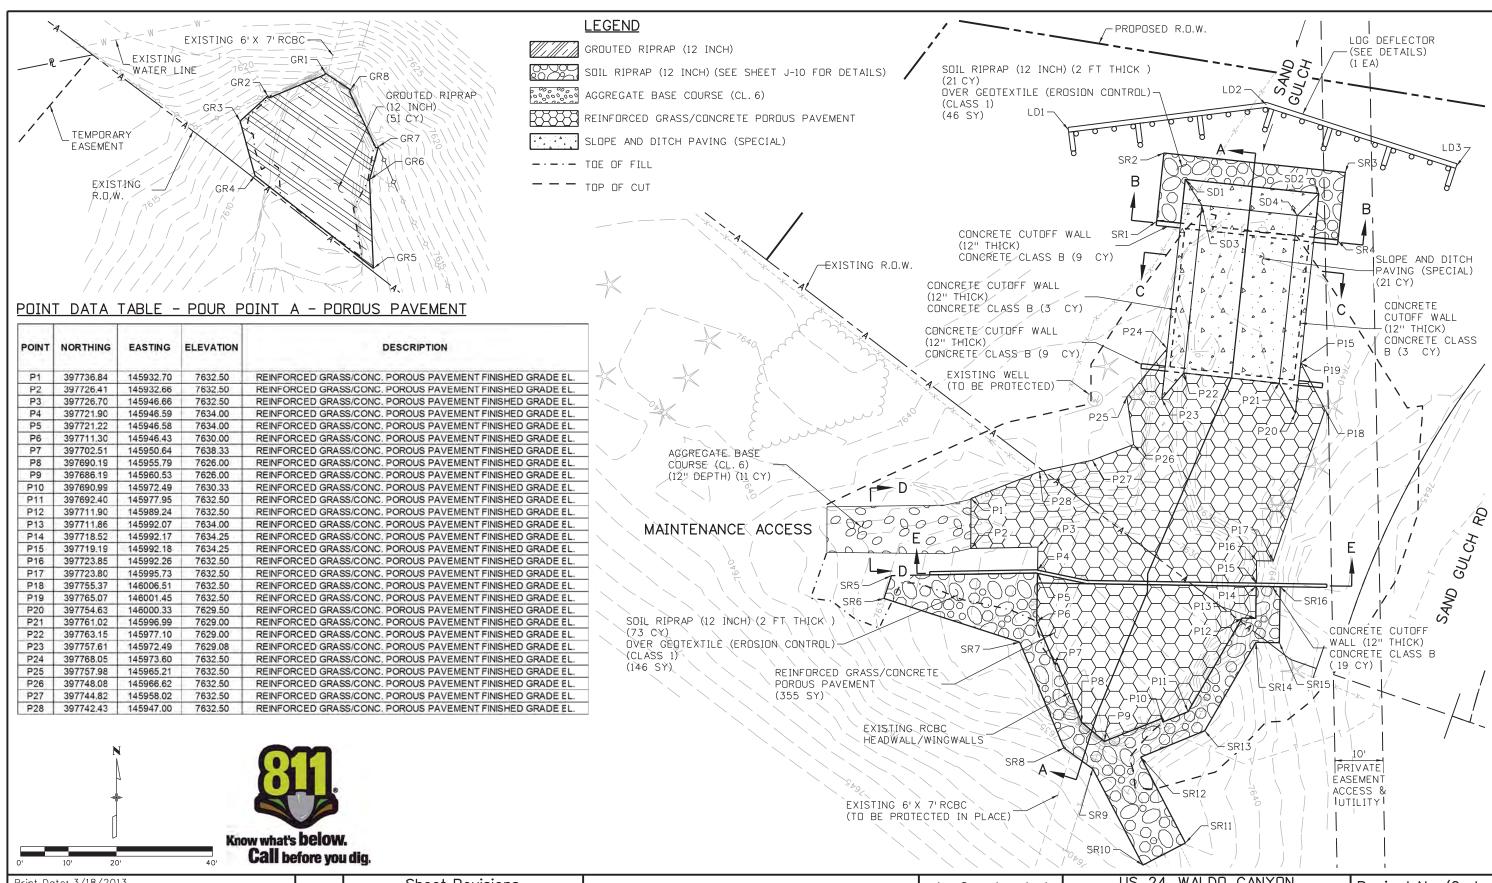		LM
	Colorado Springs, CD Phone: 719-227-3201	
ı	1480 QuailLake Loop	

As Constructed	US 24 WALDO CANYON		US 24 WALDO CANYON Project No./Co		Project No./Code
No Revisions:	POUR POINT A	NH 0242-056			
Revised:		Structure	19358		
Void:	Detailer: KLT Sheet Subset: DRAINAGE		Sheet Number 19		

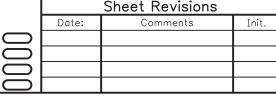

POINT DATA TABLE - POUR POINT A - GRADING

POINT	NORTHING	EASTING	ELEVATION	DESCRIPTION
G1	397714.99	145904.51	7637.00	FINISHED GRADE
G2	397709.91	145913.38	7635.00	FINISHED GRADE
G3	397719.19	145921.74	7634.00	FINISHED GRADE
G4	397713.59	145941.38	7631.00	FINISHED GRADE
G5	397735.21	145912.69	7636.00	FINISHED GRADE
G6	397757.01	145972.42	7629.00	FINISHED GRADE
G7	397754.83	145954.55	7638.00	FINISHED GRADE
G8	397758.80	145953.99	7638.00	FINISHED GRADE
G9	397795.96	145980.61	7640.00	FINISHED GRADE
G10	397790.85	146000.18	7639.00	FINISHED GRADE
G11	397781.44	146006.98	7640.00	FINISHED GRADE
G12	397763.11	145977.50	7629.00	FINISHED GRADE
G13	397761.06	145996.59	7629.00	FINISHED GRADE
G14	397743.52	145974.34	7629.00	FINISHED GRADE
G15	397741.01	145967.72	7629.00	FINISHED GRADE
G16	397731.24	145967.68	7629.00	FINISHED GRADE
G17	397730.88	145990.75	7629.00	FINISHED GRADE
G18	397755.89	145999.29	7629.00	FINISHED GRADE
G19	397767.84	146015.96	7641.00	FINISHED GRADE
G20	397755.81	146026.74	7642.00	FINISHED GRADE
G21	397734.14	146025.68	7645.00	FINISHED GRADE
G22	397720.54	146021.03	7645.00	FINISHED GRADE
G23	397705.09	146011.88	7644.00	FINISHED GRADE
G24	397690.23	145996,34	7641.00	FINISHED GRADE
G25	397681,29	145984.23	7638.00	FINISHED GRADE
G26	397676.81	145967.36	7636.00	FINISHED GRADE
G27	397687.04	145969.53	7632.00	FINISHED GRADE
G28	397723.21	145922.64	7634.00	FINISHED GRADE
G29	397735.33	145922.69	7634.00	FINISHED GRADE
G30	397739.51	145947.71	7631.00	FINISHED GRADE
G31	397729.51	145947.67	7631.00	FINISHED GRADE
G32	397727.41	145956,80	7631.00	FINISHED GRADE
G33	397725.40	145957.00	7632.00	FINISHED GRADE
G34	397723.69	145946.23	7634.00	FINISHED GRADE
G35	397719.68	145945.81	7634.00	FINISHED GRADE
G36	397722.14	145952.95	7634.00	FINISHED GRADE
G37	397718.05	145952.89	7634.00	FINISHED GRADE
G38	397713.40	145956.82	7632.00	FINISHED GRADE
G39	397709.44	145954.62	7630.00	FINISHED GRADE
G40	397693.36	145959.28	7626.00	FINISHED GRADE
G41	397697.23	145968.03	7627.00	FINISHED GRADE
G42	397690.44	145973.35	7631.00	FINISHED GRADE
G43	397710.96	145985.23	7631.00	FINISHED GRADE
G44	397712.95	145986.09	7632.00	FINISHED GRADE
G45	397716.89	145990.15	7634.00	FINISHED GRADE
G46	397720.77	145997.87	7634.00	FINISHED GRADE
G47	397720.89	145990.21	7634.00	FINISHED GRADE
G48	397724.95	145986.27	7632.00	FINISHED GRADE
G49	397726.96	145985.22	7631.00	FINISHED GRADE

POINT	NORTHING	EASTING	ELEVATION	DESCRIPTION
G75	397472.54	145831.20	7614.00	FINISHED GRADE
G76	397476.72	145835.51	7614.00	FINISHED GRADE
G77	397465.55	145832.28	7611.00	FINISHED GRADE
G78	397462.85	145835.63	7609.00	FINISHED GRADE
G79	397461.96	145838.47	7609.00	FINISHED GRADE
G80	397466.66	145836.84	7609.00	FINISHED GRADE
G81	397465.77	145839.67	7609.00	FINISHED GRADE
G82	397461.36	145840.38	7608.00	FINISHED GRADE
G83	397458.09	145837.43	7607.00	FINISHED GRADE
G84	397458.06	145840.87	7607.00	FINISHED GRADE
G85	397457.08	145840.64	7607.00	FINISHED GRADE
G86	397455.54	145838.13	7606.00	FINISHED GRADE
G87	397443.23	145854.23	7606.00	FINISHED GRADE
G88	397455.15	145846.82	7607.00	FINISHED GRADE
G89	397456.11	145847.12	7607.00	FINISHED GRADE
G90	397453.36	145852.54	7607.00	FINISHED GRADE
G91	397456.96	145854.43	7609.00	FINISHED GRADE
G92	397458.75	145855.42	7610.00	FINISHED GRADE
G93	397458.37	145849.92	7608.00	FINISHED GRADE
G94	397464.10	145851.72	7608.00	FINISHED GRADE
G95	397466.80	145856.75	7610.00	FINISHED GRADE
G96	397469.11	145849.09	7606.00	FINISHED GRADE
G97	397470.89	145843.41	7606.00	FINISHED GRADE
G98	397477.59	145851.75	7606.00	FINISHED GRADE
G99	397481.23	145846.64	7606.00	FINISHED GRADE
G100	397479.12	145841.79	7608.00	FINISHED GRADE

POINT DATA TABLE - POUR POINT A - SOIL RIPRAP (12 INCH)

POINT	NORTHING	EASTING	ELEVATION	DESCRIPTION
SR1	397794.60	145971.42		LIMITS OF SOIL RIPRAP (12 INCH) - MATCH EX. GRADE EL.
SR2	397808.85	145972.94		LIMITS OF SOIL RIPRAP (12 INCH) - MATCH EX. GRADE EL.
SR3	397804.81	146010.72	-	LIMITS OF SOIL RIPRAP (12 INCH) - MATCH EX. GRADE EL.
SR4	397790.56	146009.20		LIMITS OF SOIL RIPRAP (12 INCH) - MATCH EX. GRADE EL.
SR5	397720.76	145916.12	7634.92	LIMITS OF SOIL RIPRAP (12 INCH) - FINISHED GRADE EL.
SR6	397716.00	145914.58	7634.92	LIMITS OF SOIL RIPRAP (12 INCH) - FINISHED GRADE EL.
SR7	397706.88	145942.86	7631.08	LIMITS OF SOIL RIPRAP (12 INCH) - MATCH EX. GRADE EL.
SR8	397684.85	145952.07	7635.50	LIMITS OF SOIL RIPRAP (12 INCH) - MATCH EX. GRADE EL.
SR9	397680.48	145958.10	7636.08	LIMITS OF SOIL RIPRAP (12 INCH) - MATCH EX. GRADE EL.
SR10	397660.40	145968.53	7638.04	LIMITS OF SOIL RIPRAP (12 INCH) - MATCH EX. GRADE EL.
SR11	397665.01	145977.40	7637.92	LIMITS OF SOIL RIPRAP (12 INCH) - MATCH EX. GRADE EL.
SR12	397682.93	145968.09	7633.50	LIMITS OF SOIL RIPRAP (12 INCH) - FINISHED GRADE EL.
SR13	397688.42	145981.42	7635.00	LIMITS OF SOIL RIPRAP (12 INCH) - FINISHED GRADE EL.
SR14	397706.86	145992.10	7635.00	LIMITS OF SOIL RIPRAP (12 INCH) - FINISHED GRADE EL.
SR15	397706.78	145996.99	7637.04	LIMITS OF SOIL RIPRAP (12 INCH) - FINISHED GRADE EL.
SR16	397718.44	145997.17	7634.75	LIMITS OF SOIL RIPRAP (12 INCH) - FINISHED GRADE EL.

POINT DATA TABLE - POUR POINT A - SLOPE AND DITCH PAVING

POINT	NORTHING	EASTING	ELEVATION	DESCRIPTION
SD1	397803.35	145977.38		SLOPE AND DITCH PAVING MATCH EX. GRADE ELEVATION
SD2	397800.37	146005.22		SLOPE AND DITCH PAVING MATCH EX. GRADE ELEVATION
SD3	397797.95	145980.82	7640.50	SLOPE AND DITCH PAVING FINISHED GRADE ELEVATION
SD4	397795.82	146000.71	7640.50	SLOPE AND DITCH PAVING FINISHED GRADE ELEVATION

POINT DATA TABLE - POUR POINT A - AGGREGATE BASE COURSE (CL. 6)

POINT	NORTHING	EASTING	ELEVATION	DESCRIPTION
BC1	397725.60	145902.65	7638,33	ABC (CL. 6) FINISHED GRADE EL.
BC2	397735.08	145902.69	7639.04	ABC (CL. 6) FINISHED GRADE EL.
BC3	397725.31	145927.65	7633.00	ABC (CL. 6) FINISHED GRADE EL.
BC4	397735.46	145927.23	7633.25	ABC (CL. 6) FINISHED GRADE EL.
BC5	397726.41	145932.66	7632.50	ABC (CL. 6) FINISHED GRADE EL.
BC6	397736,66	145932.70	7632,50	ABC (CL. 6) FINISHED GRADE EL.

POINT DATA TABLE - POUR POINT A - LOG DEFLECTOR

POINT	NORTHING	EASTING	ELEVATION	DESCRIPTION
LD1	397813.70	145953.01		LIMITS OF LOG DEFLECTOR (SEE DETAILS FOR VERTICAL INFORMATION)
LD2	397818.88	145994.29		LIMITS OF LOG DEFLECTOR (SEE DETAILS FOR VERTICAL INFORMATION)
LD3	397806.14	146033.90		LIMITS OF LOG DEFLECTOR (SEE DETAILS FOR VERTICAL INFORMATION)

POINT DATA TABLE - POUR POINT A - CUTOFF WALL

POINT	NORTHING	EASTING	ELEVATION	DESCRIPTION
W1	397794.27	145971.38		CONCRETE CUTOFF WALL - FINISHED GRADE EL.
W2	397790.23	146009.16		CONCRETE CUTOFF WALL - FINISHED GRADE EL.
W3	397764.44	145968.19	7633.50	CONCRETE CUTOFF WALL - FINISHED GRADE EL.
W4	397760.40	146005.97	7633.50	CONCRETE CUTOFF WALL - FINISHED GRADE EL.
W5	397721.24	145924.11	7634.00	CONCRETE CUTOFF WALL - FINISHED GRADE EL.
W6	397721.63	145946.26	7634.00	CONCRETE CUTOFF WALL - FINISHED GRADE EL.
W7	397720.24	145952.92	7634.00	CONCRETE CUTOFF WALL - FINISHED GRADE EL.
W8	397719.40	145956.91	7632.00	CONCRETE CUTOFF WALL - FINISHED GRADE EL.
W9	397718.95	145986.18	7632.00	CONCRETE CUTOFF WALL - FINISHED GRADE EL.
W10	397718.89	145990.18	7634.00	CONCRETE CUTOFF WALL - FINISHED GRADE EL.
W11	397718.63	146006.89	7638.50	CONCRETE CUTOFF WALL - FINISHED GRADE EL.

Print Date: 3/18/2013		
File Name: 19358HYDR_Detail.	_SandGulch_03.dgn	
Horiz. Scale: 1:10	Vert. Scale: As Noted	
Unit Information	Unit Leader Initials	$ \equiv$
FELSBURG HOLT &	6300 South Syracuse Way Suite 600 Centennial, CO 80111	

Sheet Revisions				
Date:	Comments	Init.		

Colorado D	epartment of Tr	ansportation
DOT	1480 QuailLake Loop Colorado Springs, CD Phone: 719-227-3201	80806 FAX: 719-227-32

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As Constructed	US 24 WALDO CANYON				US 24 WALDO CANYON Projec		Project No.	/Code
No Revisions:	POUR POINT A - SAND GULCH			NH 0242-0	056			
Revised:	Designer:		Structure Numbers		19358			
Void:	Detailer: Sheet Subset:	1,721		A-6 of 14	Sheet Number	21		

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SAND GULCH

Project No./Code

NH 0242-056

19358

Sheet Number


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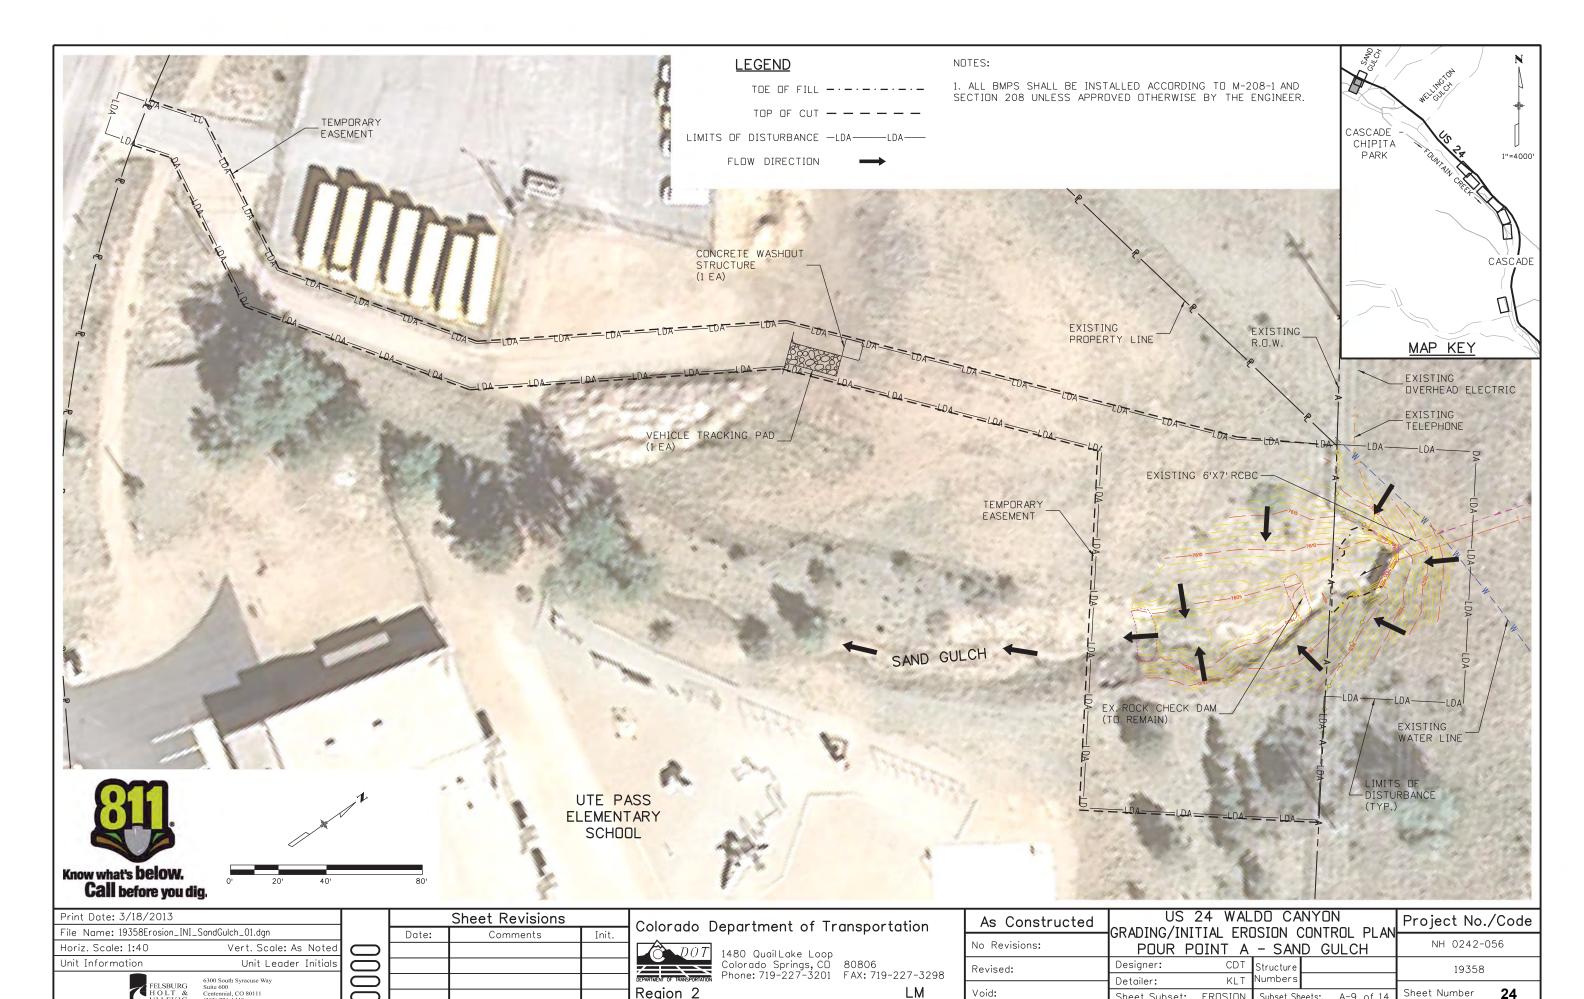
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Subset Sheets: A-9 of 14



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Subset Sheets: A-10 of 14




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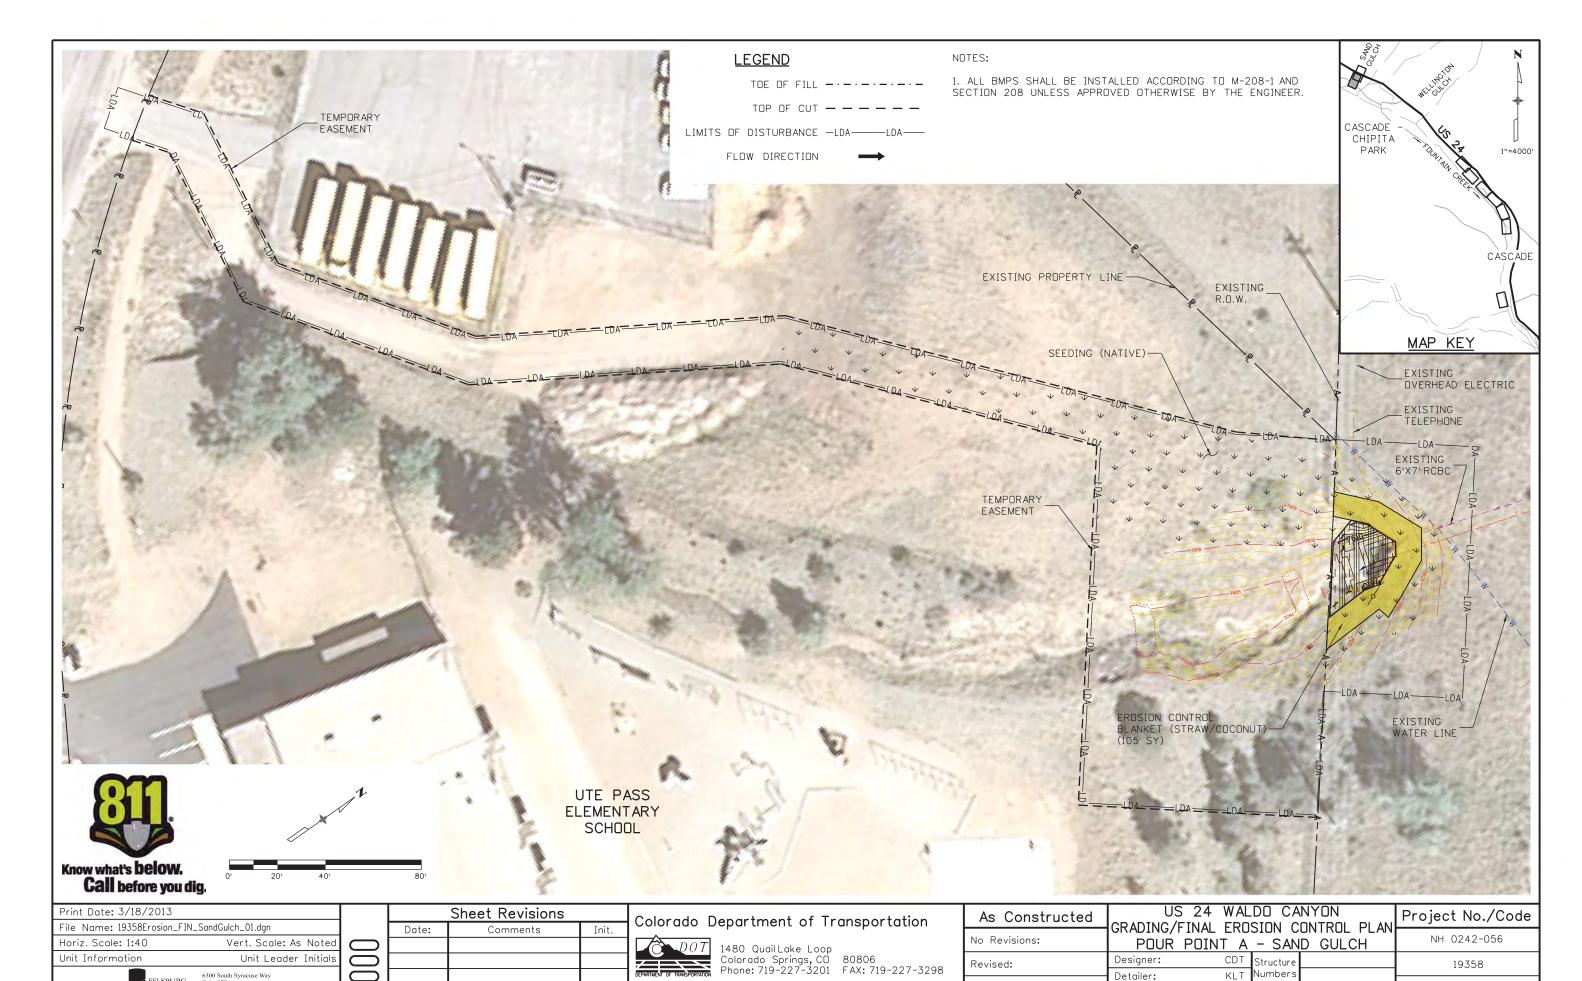
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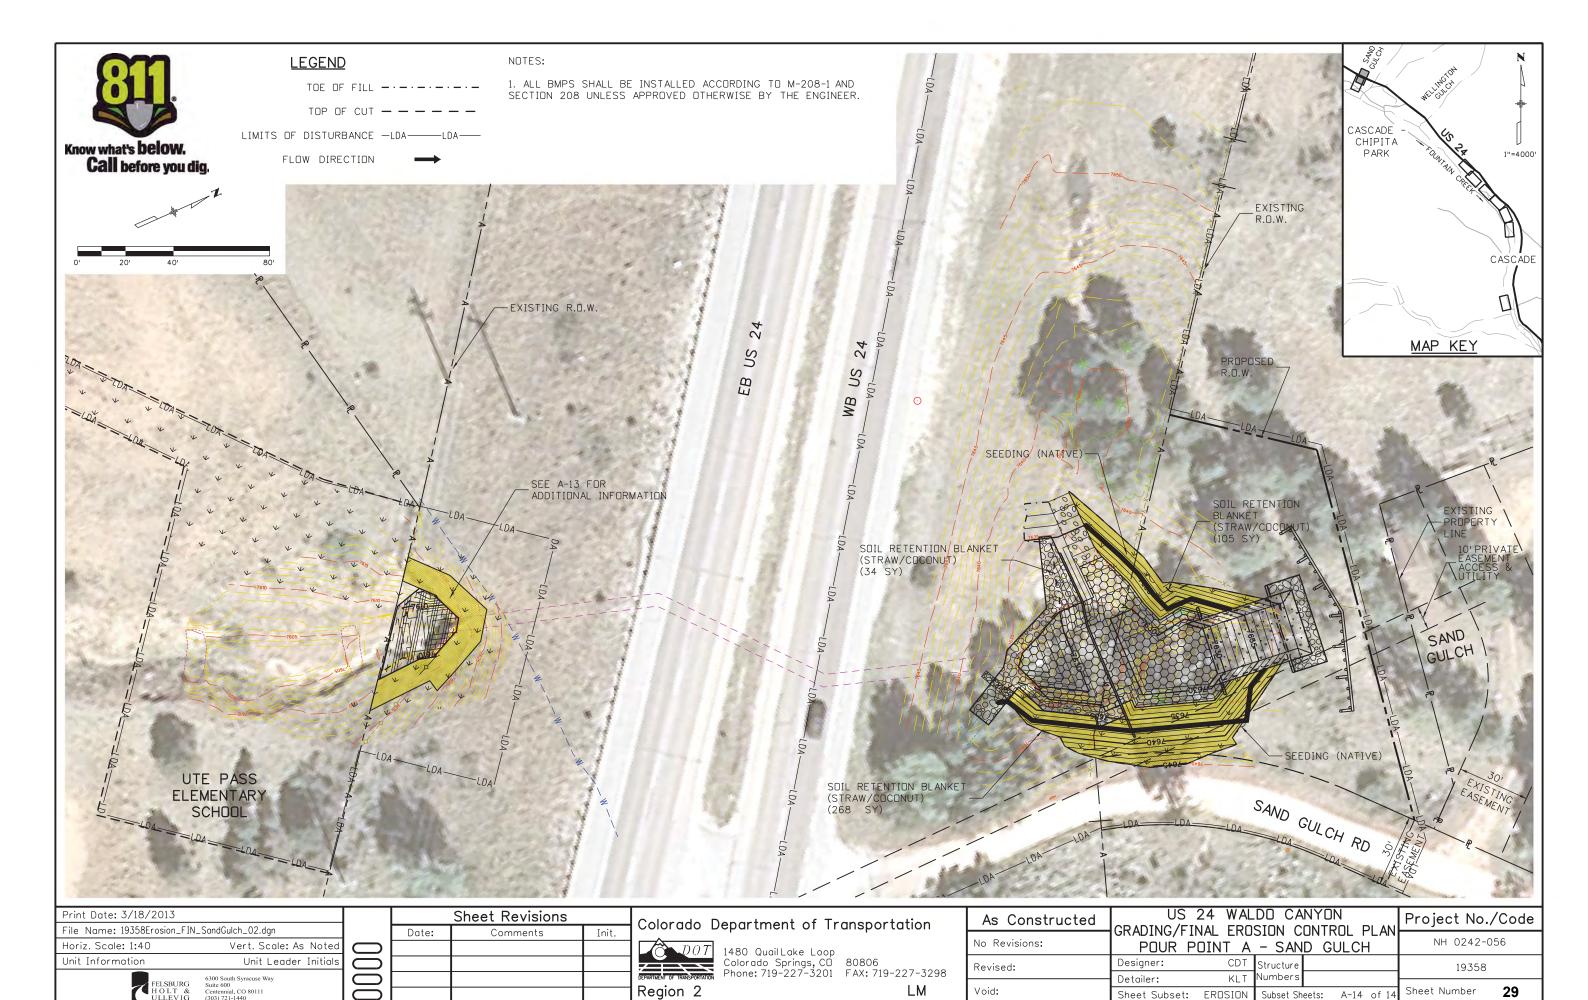

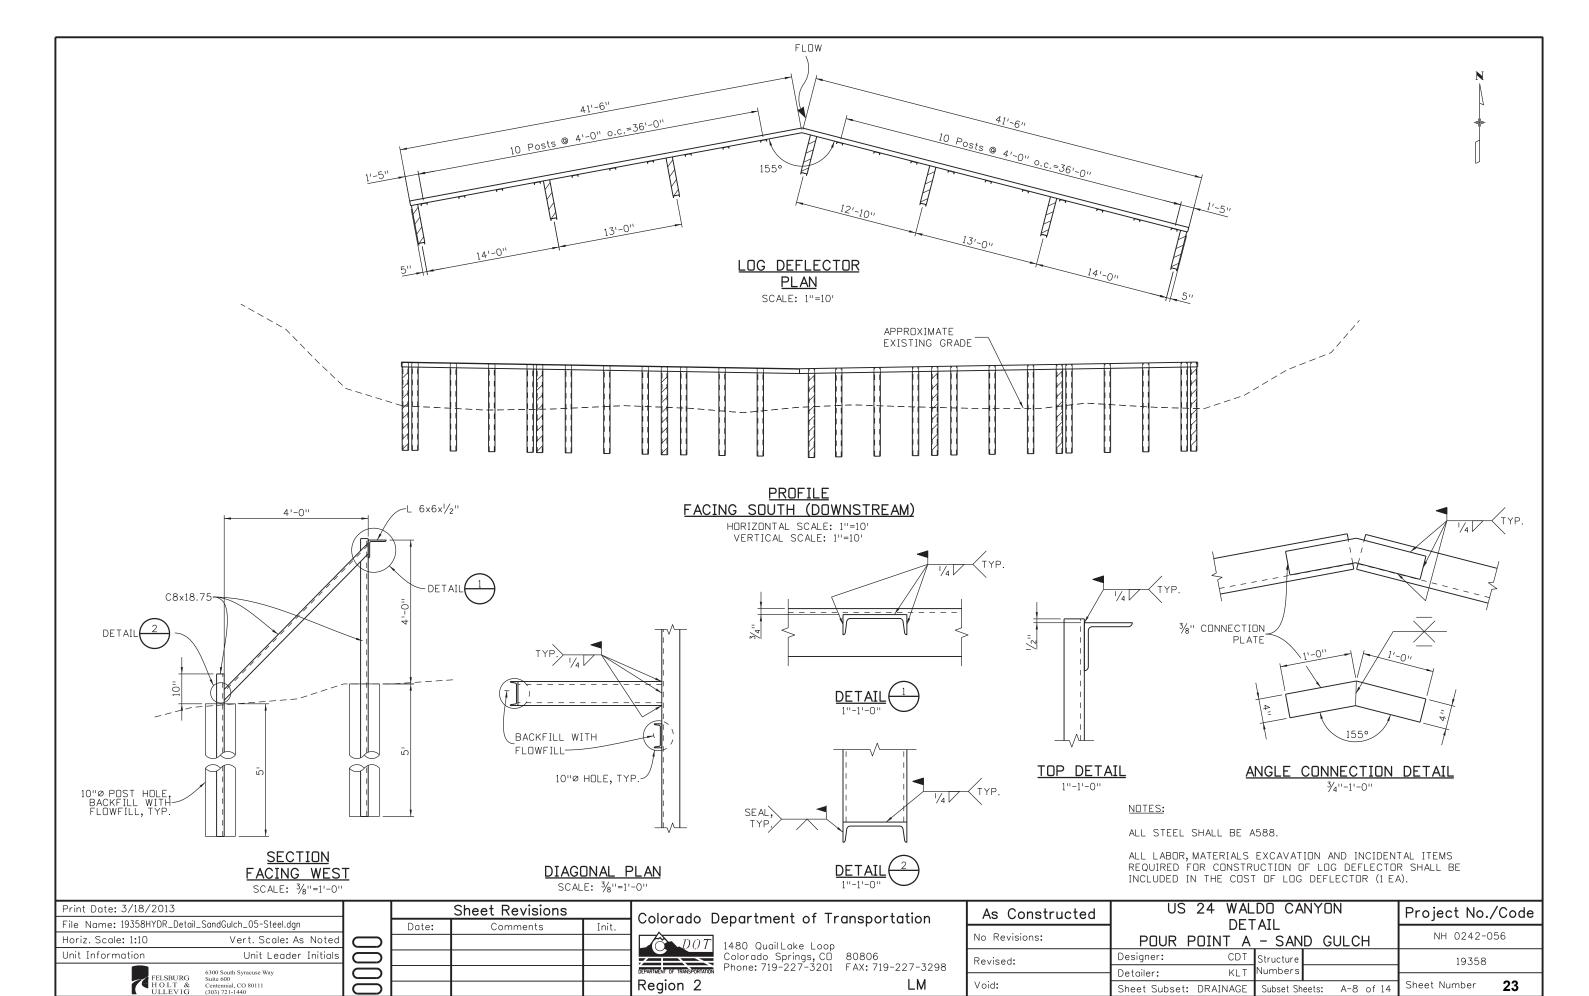
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Subset Sheets: A-13 of 14



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POUR POINT B TABULATION

CONTRACT ITEM NO.	CONTRACTITEM		QUANTITY
201-00001	CLEARING AND GRUBBING	LS	1
202-00010	REMOVAL OF TREE	EA	45
202-00035	REMOVAL OF PIPE	LF	3
202-01000	REMOVAL OF FENCE	LF	207
202-04002	CLEAN CULVERT	EA	1
203-00010	UNCLASSIFIED EXCAVATION (COMPLETE IN PLACE)	CY	2973
203-01622	SWEEPING (WITH PICKUP BROOM)	HR	40
207-00205	TOPSOIL	CY	217
208-00002	EROSION LOG (12 INCH)	LF	293
208-00034	GRAVEL BAG	LF	60
208-00045	CONCRETE WASHOUT STRUCTURE	EA	1
208-00070	VEHICLE TRACKING PAD	EA	1
208-00103	REMOVAL AND DISPOSAL OF SEDIMENT (LABOR)	HR	80
208-00105	REMOVAL AND DISPOSAL OF SEDIMENT (EQUIPMENT)	HR	40
208-00205	EROSION CONTROL SUPERVISOR	DAY	30
212-00006	SEEDING (NATIVE)	AC	0.7
212-00032	SOIL CONDITIONING	AC	0.7
213-00002	MULCHING (WEED FREE)	AC	0.7
214-00215	DECIDUOUS TREE (1.5 INCH CALIPER)	EA	45
216-00041	SOIL RETENTION BLANKET (STRAW/COCONUT)	SY	1165
304-06000	AGGREGATE BASE COURSE (CLASS 6)	CY	63
420-00102	GEOTEXTILE (EROSION CONTROL) (CLASS 1)	SY	314
506-00236	RIPRAP (36 INCH)	CY	90
506-00412	SOIL RIPRAP (12 INCH)	CY	118
601-01000	CONCRETE CLASS B	CY	22
607-53173	FENCE CHAIN LINK (SPECIAL) (72 INCH)	LF	260
607-60212	12 FOOT GATE SINGLE (CHAIN LINK)	EA	2
608-00100	REINFORCED GRASS/CONCRETE POROUS PAVEMENT	SY	1598
615-00620	LOG DEFLECTOR	EA	1

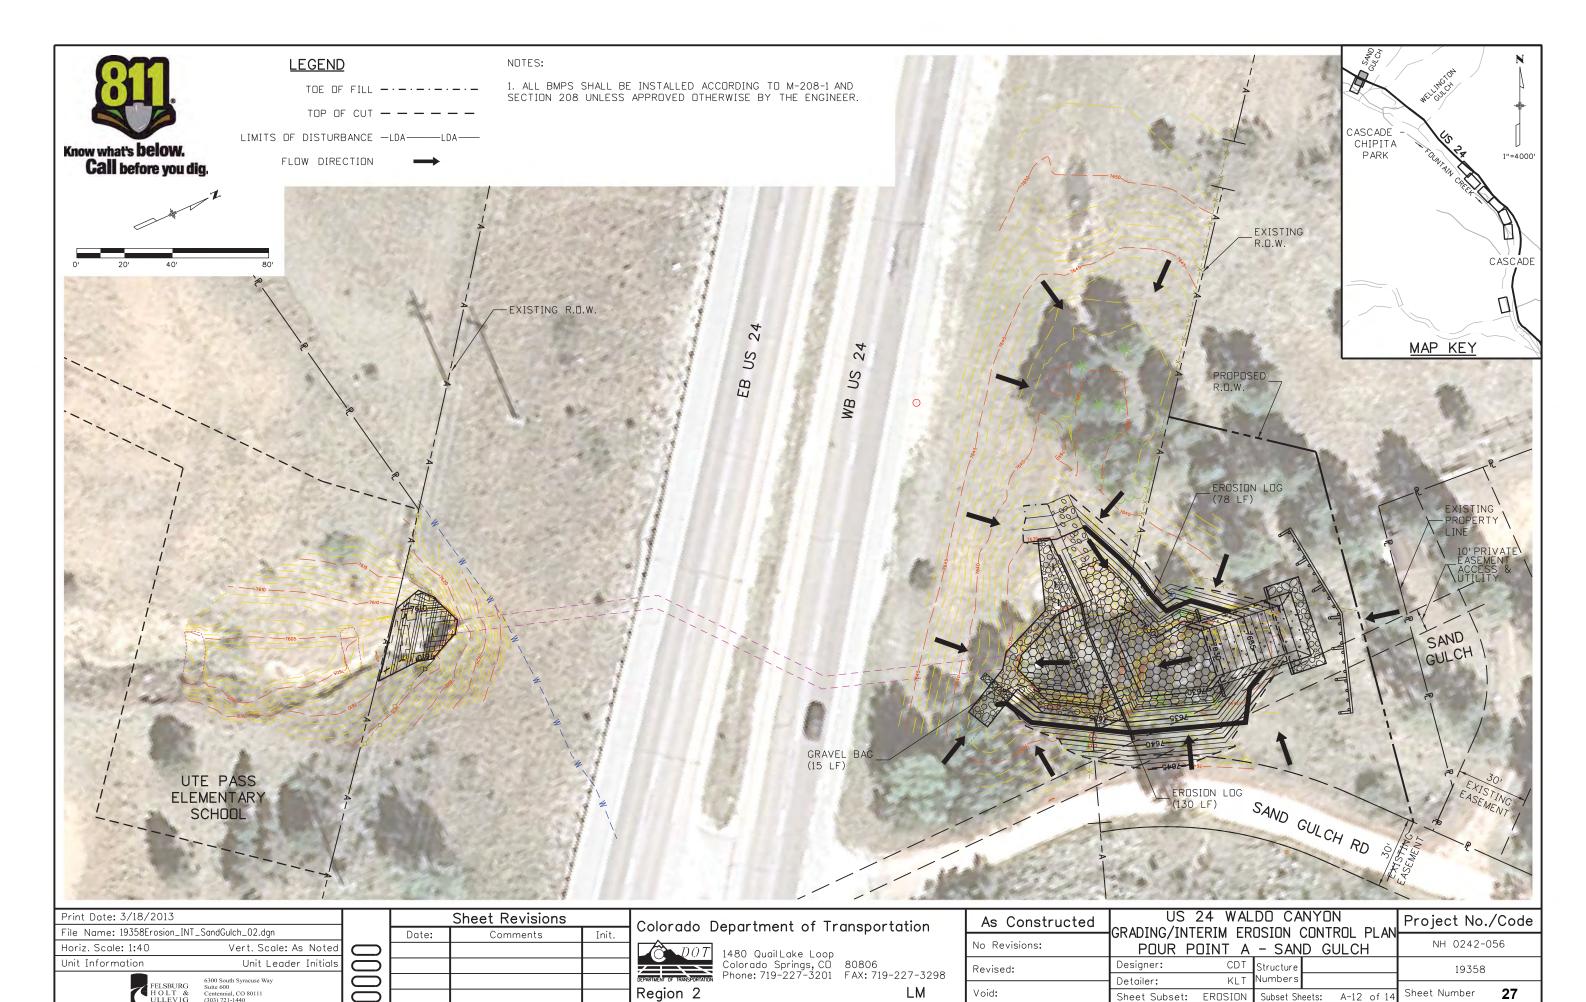NOTE: TREES SHALL BE PLACED AS DIRECTED BY THE ENGINEER.

INDEX		^-	ITEM	PROJECT TOTALS	
BOOK PAGE SHEET		SHEET	ITEM	PROJECTIONALS	
			EMBANKMENT MATERIAL (CIP) (FOR INFO. ONLY)	CU. YDS,	
			WELLINGTON GULCH	34	
			SUBTOTAL	34	
			TOTAL	34	
			UNCLASSIFIED EXCAVATION	CU. YDS.	
			WELLINGTON GULCH	2,973	
			OTHER EXCAVATION	0	
			SUBTOTAL	2,973	
			TOTAL FOR PAY QUANTITY	2,973	

	COMPACTION (FOR INFORMATION ONLY) (MOISTURE & DENSITY CONTROL) EMBANKMENT (NET)	34
	TOTAL	34
	WETTING QUANTITIES (FOR INFORMATION ONLY) COMPACTION	M. GAL.
4	(34 x 0.040 M. GAL./yd) TOTAL	1
	ACCESS ROAD QUANTITIES BALANCE (FOR INFORMATION ONLY)	CU. YDS.
	EMBANKMENT (NET)	34
	EMBANKMENT X FACTOR (1.15)	39
	BALANCE TOTAL	39
	UNCLASSIFIED EXCAVATION TO BE EXPORTED BY THE CONTRACTOR BALANCE TOTAL	2,973 -2,934 39

Print Date: 3/18/2013		Г
File Name: 19358HYDR_Tabs_	Earthwork_Wellington.dgn	
Horiz. Scale: 1:1	Vert. Scale: As Noted	(
Unit Information	Unit Leader Initials	(
FELSBURG	6300 South Syracuse Way Suite 600	(
HOLT & ULLEVIG	Centennial, CO 80111 (303) 721-1440	

Sheet Revisions					
Date:	Comments	Init.			


Colorado Department of Transportation


1480 QuailLake Loop
Colorado Springs, CD 80806
Phone: 719-227-3201 FAX: 719-227-3298


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As Constructed	US 24 WALDO CANYON TABULATION			Project No./	Code		
No Revisions:	POUR POINT B			STON	GULCH	NH 0242-05	6
Revised:	Designer:	_	Structure Numbers			19358	
Void:	Detailer: Sheet Subset:	TAB	Subset She	ets:	B-1 of 10	Sheet Number	30





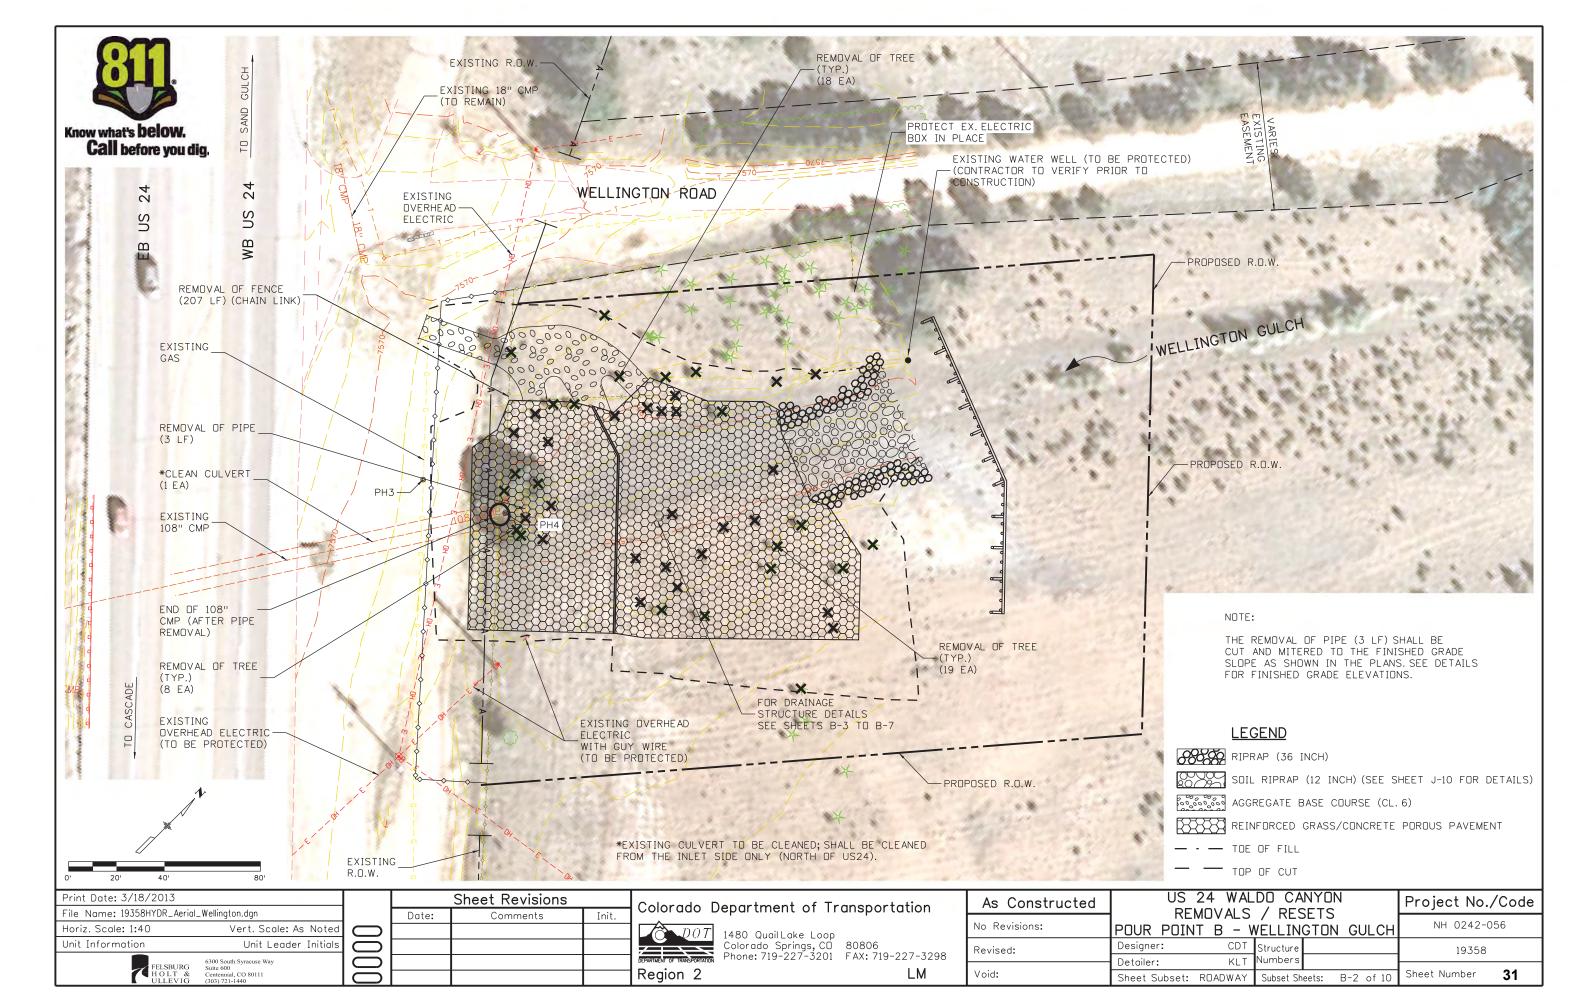
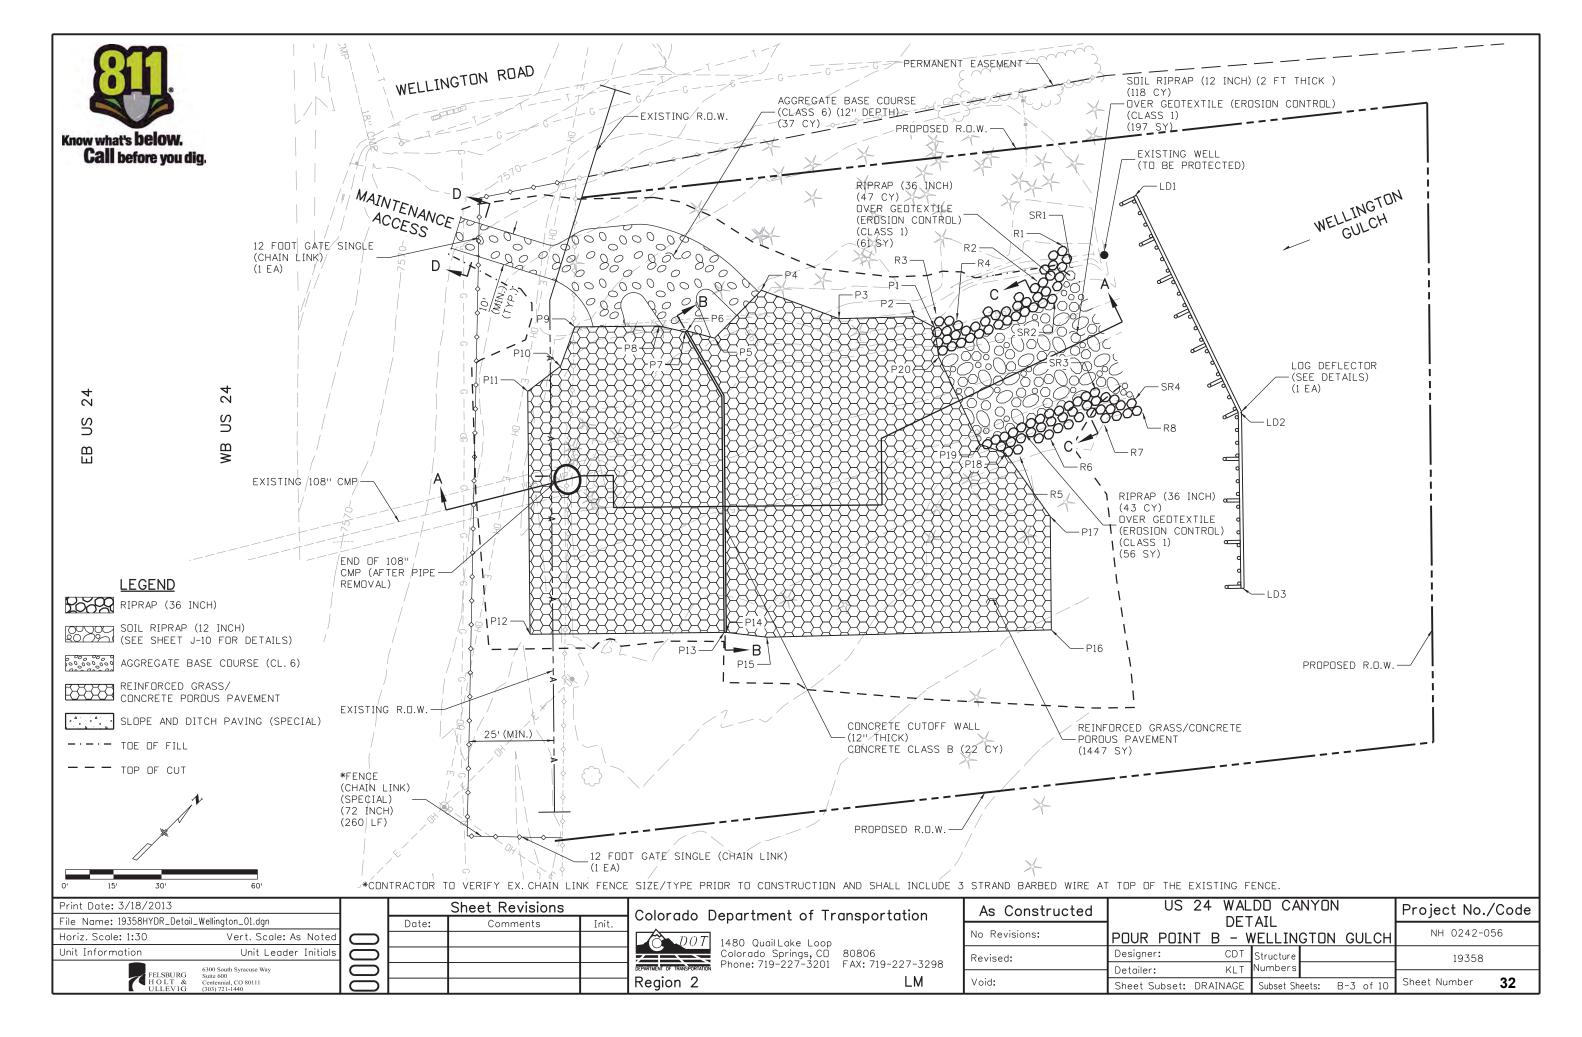
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Sheet Subset: DRAINAGE
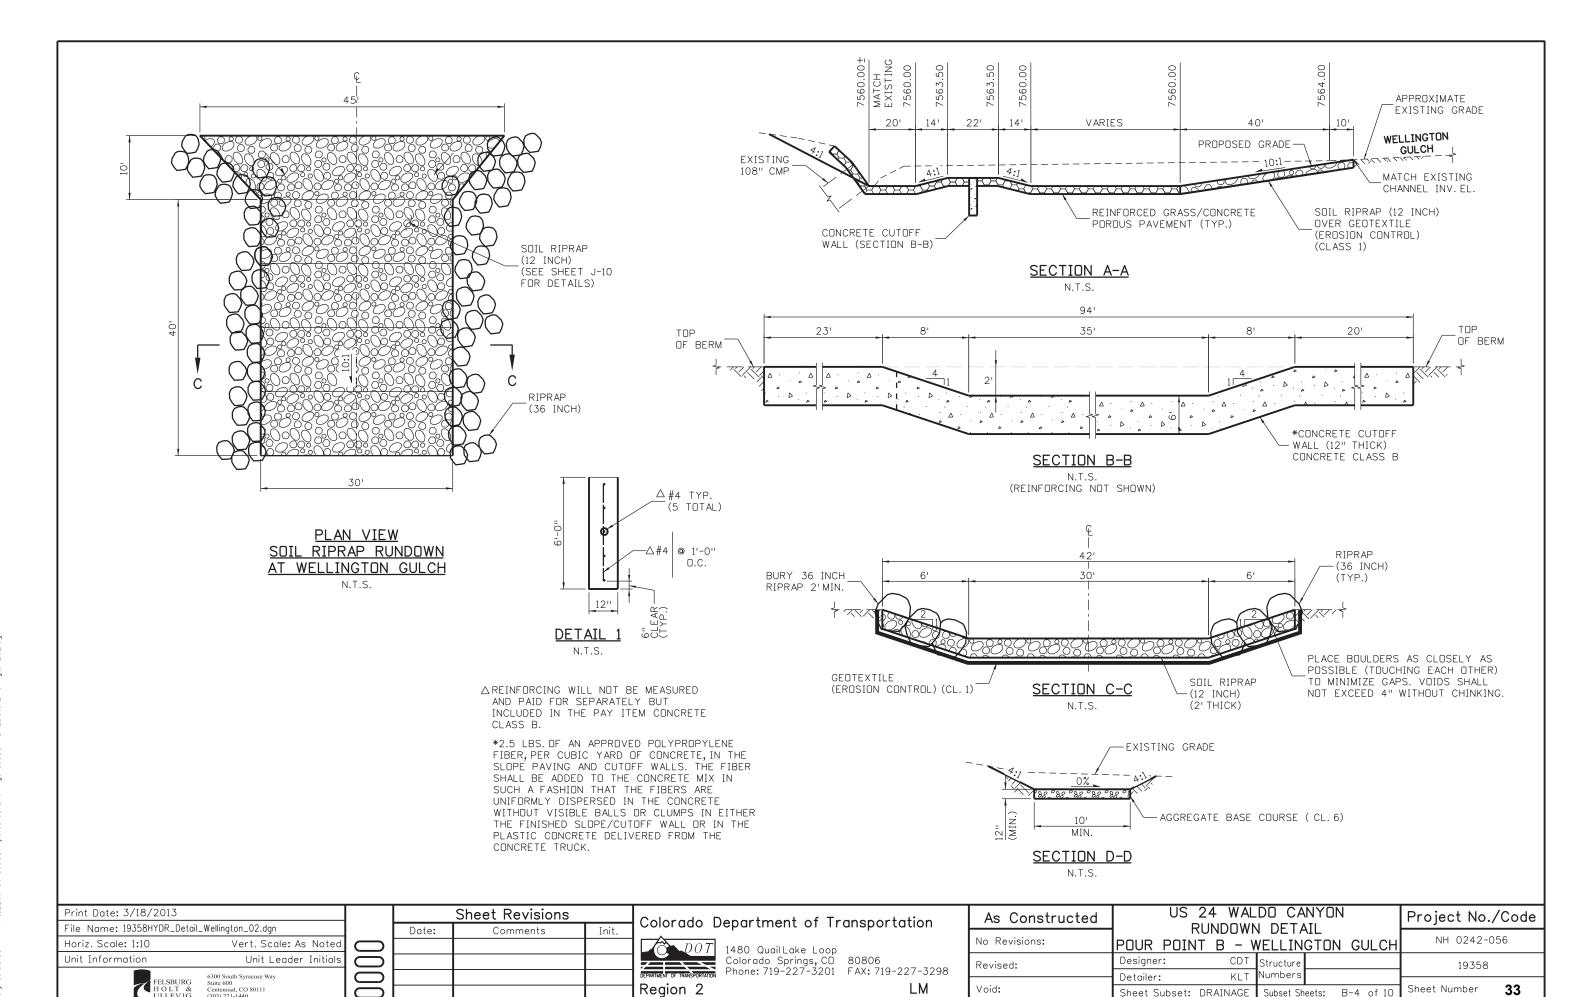
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Subset Sheets: B-4 of 10

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POINT DATA TABLE - POUR POINT B - GRADING

OINI DAIA IA		IADLL	1 0011 1	OTIAL D		
POINT	NORTHING	EASTING	ELEVATION	DESCRIPTION		
G1	396162.89	148013.92	7569.00	FINISHED GRADE		
G2	396174.65	148008.24	7569.00	FINISHED GRADE		
G3	396195.33	148023,80	7569.00	FINISHED GRADE		
G4	396216.23	148047.68	7568.00	FINISHED GRADE		
G5	396142.14	148044.32	7558.00	FINISHED GRADE		
G6	396158.61	148051.16	7567.00	FINISHED GRADE		
G7	396169.04	148046.71	7567.00	FINISHED GRADE		
G8	396178.48	148048.10	7565.00	FINISHED GRADE		
G9	396190.34	148046,23	7565.00	FINISHED GRADE		
G10	396175.40	148061.90	7563.00	FINISHED GRADE		
G11	396183.73	148070.66	7563.00	FINISHED GRADE		
G12	396226.13	148065,51	7565.00	FINISHED GRADE		
G13	396208.56	148073.40	7565.00	FINISHED GRADE		
G14	396219.73	148070.94	7565.00	FINISHED GRADE		
G15	396236.17	148099.91	7565.00	FINISHED GRADE		
G16	396237.15	148112.62	7565.00	FINISHED GRADE		
G17	396207.38	148123.03	7560.00	FINISHED GRADE		
G18	396219.61	148123.30	7580.00	FINISHED GRADE		
G19	396237.10	148142.10	7560.00	FINISHED GRADE		
G20	396242.77	148148.19	7560.00	FINISHED GRADE		
G21	396263.09	148130.69	7567.00	FINISHED GRADE		
G22	396264.85	148146.16	7567.00	FINISHED GRADE		
G23	396281.75	148157.13	7567.00	FINISHED GRADE		
G24	396289.08	148155.48	7567.00	FINISHED GRADE		
G25	396289.09	148157.53	7556.00	FINISHED GRADE		
G26	396281.01	148161.33	7565.00	FINISHED GRADE		
G27	396279.94	148162.97	7564.00	FINISHED GRADE		
G28	396268.86	148190.85	7564.00	FINISHED GRADE		
G29	396272.25	148193.46	7565.00	FINISHED GRADE		
G30	396264.44	148194.03	7566.00	FINISHED GRADE		
G31	396248.79	148196.27	7567.00	FINISHED GRADE		
G32	396231.69	148176.07	7560.00	FINISHED GRADE		
G33	396227.61	148180.91	7550.00	FINISHED GRADE		
G34	396219.58	148201.12	7560.00	FINISHED GRADE		
G35	396244.82	148215.75	7567.00	FINISHED GRADE		

POINT	NORTHING	EASTING	ELEVATION	DESCRIPTION
G36	396204.75	148215.21	7560.00	FINISHED GRADE
G37	396203.88	148265.71	7569.00	FINISHED GRADE
G38	396159.20	148168,83	7560.00	FINISHED GRADE
G39	396124.99	148168.24	7566.00	FINISHED GRADE
G40	396130.86	148154.38	7565.00	FINISHED GRADE
G41	396162.18	148146.68	7563.50	FINISHED GRADE
G42	396153.70	148146.47	7565.00	FINISHED GRADE
G43	396146.81	148139.22	7565.00	FINISHED GRADE
G44	396147.02	148130.74	7563.50	FINISHED GRADE
G45	396187.55	148122.57	7563.50	FINISHED GRADE
G46	396172.39	148106.62	7563.50	FINISHED GRADE
G47	396187.76	148114.09	7565.00	FINISHED GRADE
G48	396190.56	148111.42	7565.00	FINISHED GRADE
G49	396184.38	148103,50	7565.00	FINISHED GRADE
G50	396180.87	148106.84	7565.00	FINISHED GRADE
G51	396124.33	148132.99	7560.00	FINISHED GRADE
G52	396164.92	148094.41	7560.00	FINISHED GRADE
G53	396169,41	148084.62	7561.00	FINISHED GRADE
G54	396161.14	148075,92	7561.00	FINISHED GRADE
G55	396151.14	148079.91	7560.00	FINISHED GRADE
G56	396110.55	148118.50	7560.00	FINISHED GRADE
G57	396081.11	148107.85	7567.00	FINISHED GRADE

POINT DATA TABLE - POUR POINT B - LOG DEFLECTOR

POINT NORTHING		EASTING	ELEVATION	DESCRIPTION		
LD1	396321.53	148158.63	~	LIMITS OF LOG DEFLECTOR (SEE DETAILS FOR VERTICAL INFORMATION)		
LD2	396294.47	148228.70		LIMITS OF LOG DEFLECTOR (SEE DETAILS FOR VERTICAL INFORMATION)		
LD3	396254.75	148266.90		LIMITS OF LOG DEFLECTOR (SEE DETAILS FOR VERTICAL INFORMATION)		

POINT DATA TABLE - POUR POINT B - RIPRAP (36 INCH)

POINT	NORTHING	EASTING	ELEVATION	DESCRIPTION		
R1	396317.07	148164.00		LIMITS OF RIPRAP (36 INCH) - MATCH EX. GRADE EL.		
R2	396299.17	148161,45	7568.00	568.00 LIMITS OF SOIL RIPRAP (36 INCH) - FINISHED GRADE EL.		
R3	396252.08	148139,48	7564.04			
R4	396258.02	148147.47	7565.50	7565.50 LIMITS OF SOIL RIPRAP (36 INCH) - FINISHED GRADE EL.		
R5	396237.53	148187.46	7563.83	7563.83 LIMITS OF SOIL RIPRAP (36 INCH) - FINISHED GRADE EL.		
R6	396271.87	148199.41		- LIMITS OF RIPRAP (36 INCH) - MATCH EX. GRADE EL.		
R7	396286.58	148211.09	- 8	- LIMITS OF RIPRAP (36 INCH) - MATCH EX. GRADE EL.		
R8	396296.98	148217,21	400	LIMITS OF RIPRAP (36 INCH) - MATCH EX. GRADE EL.		

POINT DATA TABLE - POUR POINT B - SOIL RIPRAP (12 INCH)

POINT NORTHING EASTING ELEVATION DESCRI		DESCRIPTION			
SR1	R1 396320.62 148168.92 - LIMITS OF SOIL RIPRAP (12 INCH) - MATCH EX. GRADE		LIMITS OF SOIL RIPRAP (12 INCH) - MATCH EX. GRADE EL.		
SR2	396307.82	148174.05	7566.83	7566.83 LIMITS OF SOIL RIPRAP (12 INCH) - FINISHED GRADE EL.	
SR3	396296.74	148201.93		- LIMITS OF SOIL RIPRAP (12 INCH) - MATCH EX. GRADE EL.	
SR4	396303.05	148213.12		LIMITS OF SOIL RIPRAP (12 INCH) - MATCH EX. GRADE EL.	

POINT DATA TABLE - POUR POINT B - CUTOFF WALL

POINT	NORTHING	EASTING	ELEVATION	DESCRIPTION
W1	396194.84	148084.90	7565.00	CONCRETE CUTOFF WALL - FINISHED GRADE EL.
W2	396187.94	148107.02	7565.00	CONCRETE CUTOFF WALL - FINISHED GRADE EL.
W3	396184.32	148110.46	7565.00	CONCRETE CUTOFF WALL - FINISHED GRADE EL.
W4	396179.97	148114.60	7563.50	CONCRETE CUTOFF WALL - FINISHED GRADE EL.
W5	396154.60	148138.71	7563.50	CONCRETE CUTOFF WALL - FINISHED GRADE EL.
VV6	396150.25	148142.84	7565.00	CONCRETE CUTOFF WALL - FINISHED GRADE EL.
W7	396134.31	148158.00	7565.00	CONCRETE CUTOFF WALL - FINISHED GRADE EL.

POINT DATA TABLE - POUR POINT B - POROUS PAVERS

POINT	NORTHING	EASTING	ELEVATION	DESCRIPTION
P1	396248.74	148140.82	7563.00	REINFORCED GRASS/CONC. POROUS PAVEMENT FINISHED GRADE EL.
P2	396246,89	148133.96	7563.00	REINFORCED GRASS/CONC. POROUS PAVEMENT FINISHED GRADE EL.
P3	396230.37	148117.14	7563.00	REINFORCED GRASS/CONC. POROUS PAVEMENT FINISHED GRADE EL.
P4	396220.28	148093.31	7563.00	REINFORCED GRASS/CONC. POROUS PAVEMENT FINISHED GRADE EL.
P5	396199.36	148092.84	7565.00	REINFORCED GRASS/CONC. POROUS PAVEMENT FINISHED GRADE EL.
P6	396195.16	148084.99	7565.00	REINFORCED GRASS/CONC. POROUS PAVEMENT FINISHED GRADE EL.
P7	396194.52	148084.80	7565.00	REINFORCED GRASS/CONC. POROUS PAVEMENT FINISHED GRADE EL.
P8	396190.31	148077.58	7565.00	REINFORCED GRASS/CONC. POROUS PAVEMENT FINISHED GRADE EL.
P9	396172.12	148058.44	7564.00	REINFORCED GRASS/CONC. POROUS PAVEMENT FINISHED GRADE EL.
P10	396160.08	148063.57	7564.00	REINFORCED GRASS/CONC. POROUS PAVEMENT FINISHED GRADE EL.
P11	396147.36	148061.43	7564.00	REINFORCED GRASS/CONC. POROUS PAVEMENT FINISHED GRADE EL.
P12	396092.28	148113.79	7565.00	REINFORCED GRASS/CONC. POROUS PAVEMENT FINISHED GRADE EL.
P13	396134.08	148157.76	7565.00	REINFORCED GRASS/CONC. POROUS PAVEMENT FINISHED GRADE EL.
P14	396134.54	148158.24	7565.00	REINFORCED GRASS/CONC. POROUS PAVEMENT FINISHED GRADE EL.
P15	396142.09	148168.54	7563.00	REINFORCED GRASS/CONC. POROUS PAVEMENT FINISHED GRADE EL.
P16	396204.46	148232.04	7563.00	REINFORCED GRASS/CONC. POROUS PAVEMENT FINISHED GRADE EL.
P17	396230.14	148207.63	7563.00	REINFORCED GRASS/CONC. POROUS PAVEMENT FINISHED GRADE EL.
P18	396235.05	148183.86	7563.00	REINFORCED GRASS/CONC. POROUS PAVEMENT FINISHED GRADE EL.
P19	396231.69	148176.07	7560.00	REINFORCED GRASS/CONC. POROUS PAVEMENT FINISHED GRADE EL.
P20	396242.77	148148.19	7560.00	REINFORCED GRASS/CONC. POROUS PAVEMENT FINISHED GRADE EL.

POINT DATA TABLE - POUR POINT B - AGGREGATE BASE COURSE (CL. 6)

POINT	NORTHING	EASTING	ELEVATION	DESCRIPTION
BC1	396163.79	148013.48	7569.00	ABC (CL. 6) FINISHED GRADE EL.
BC2	396172.79	148009.13	7569.00	ABC (CL. 6) FINISHED GRADE EL.
BC3	396185.06	148034.56	7566.25	ABC (CL. 6) FINISHED GRADE EL.
BC4	396177.73	148042.37	7565.67	ABC (CL. 6) FINISHED GRADE EL.
BC5	396176.06	148062.59	7563.00	ABC (CL. 6) FINISHED GRADE EL.
BC6	396183.04	148069.93	7563.00	ABC (CL. 6) FINISHED GRADE EL.
BC7	396190.99	148063.58	7564.50	ABC (CL. 6) FINISHED GRADE EL.
BC8	396193.48	148068.21	7565.00	ABC (CL. 6) FINISHED GRADE EL.
BC9	396198.77	148091.75	7565.00	ABC (CL. 6) FINISHED GRADE EL.
BC10	396212.07	148054.95	7565.75	ABC (CL. 6) FINISHED GRADE EL.
BC11	396217.77	148068.86	7565.25	ABC (CL. 6) FINISHED GRADE EL.
BC12	396207.16	148079.49	7564.75	ABC (CL. 6) FINISHED GRADE EL.
BC13	396209.28	148093.06	7563.00	ABC (CL. 6) FINISHED GRADE EL.
BC14	396219.28	148093.29	7563.00	ABC (CL. 6) FINISHED GRADE EL.

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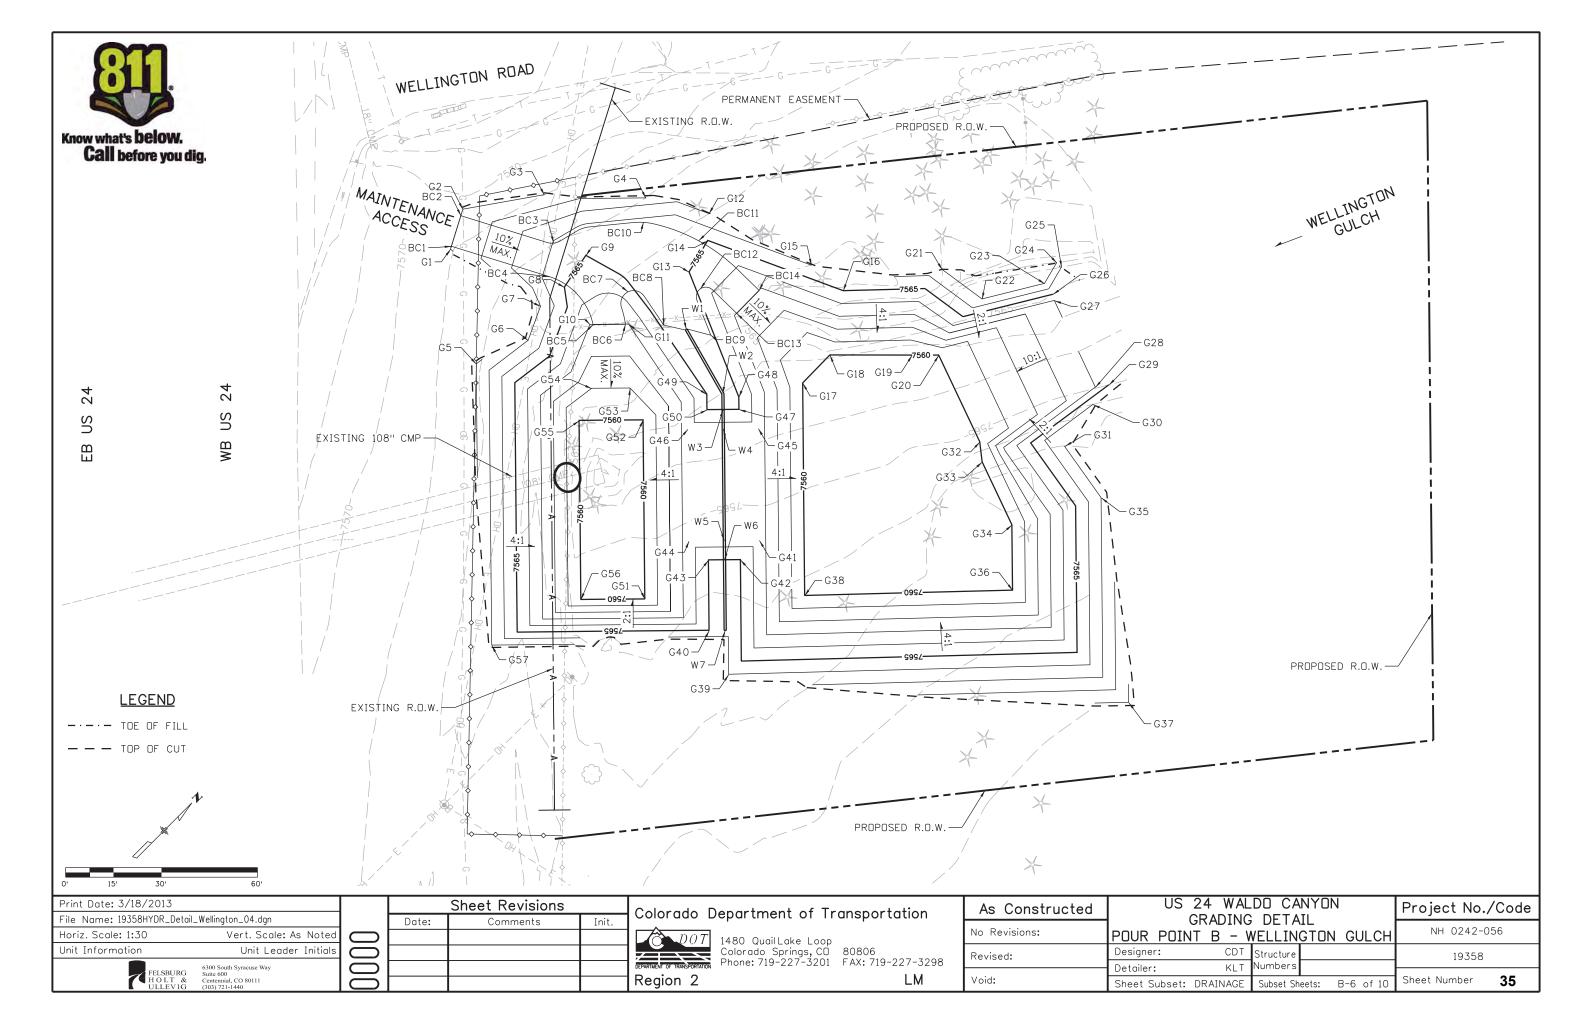
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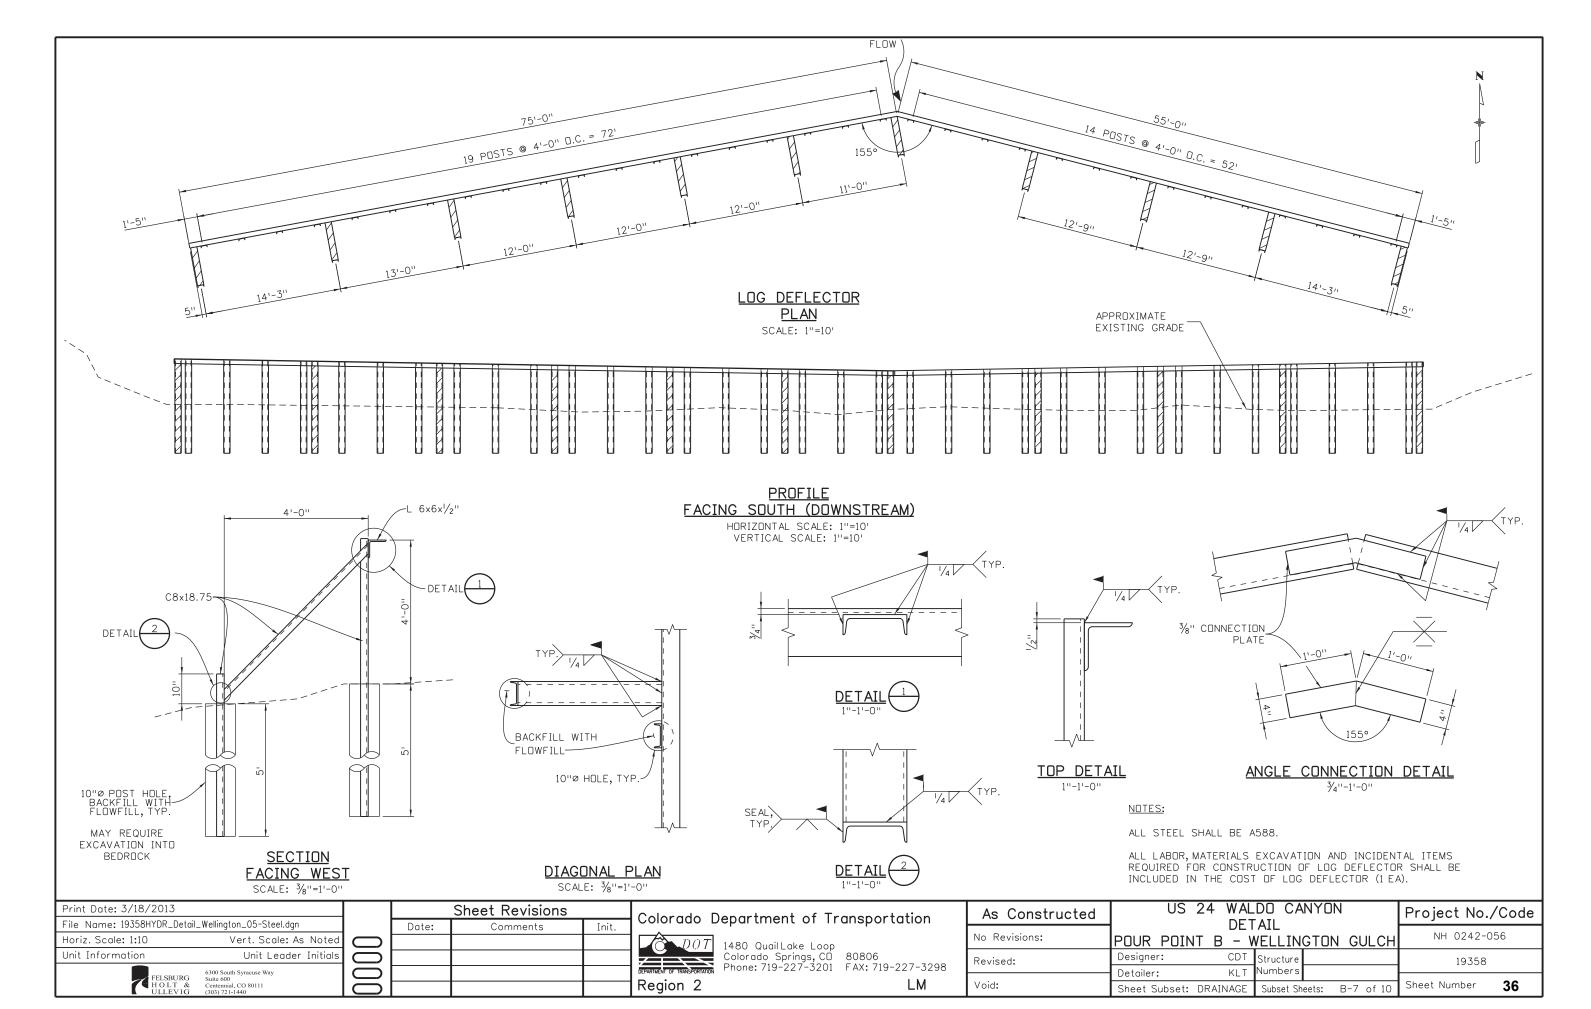
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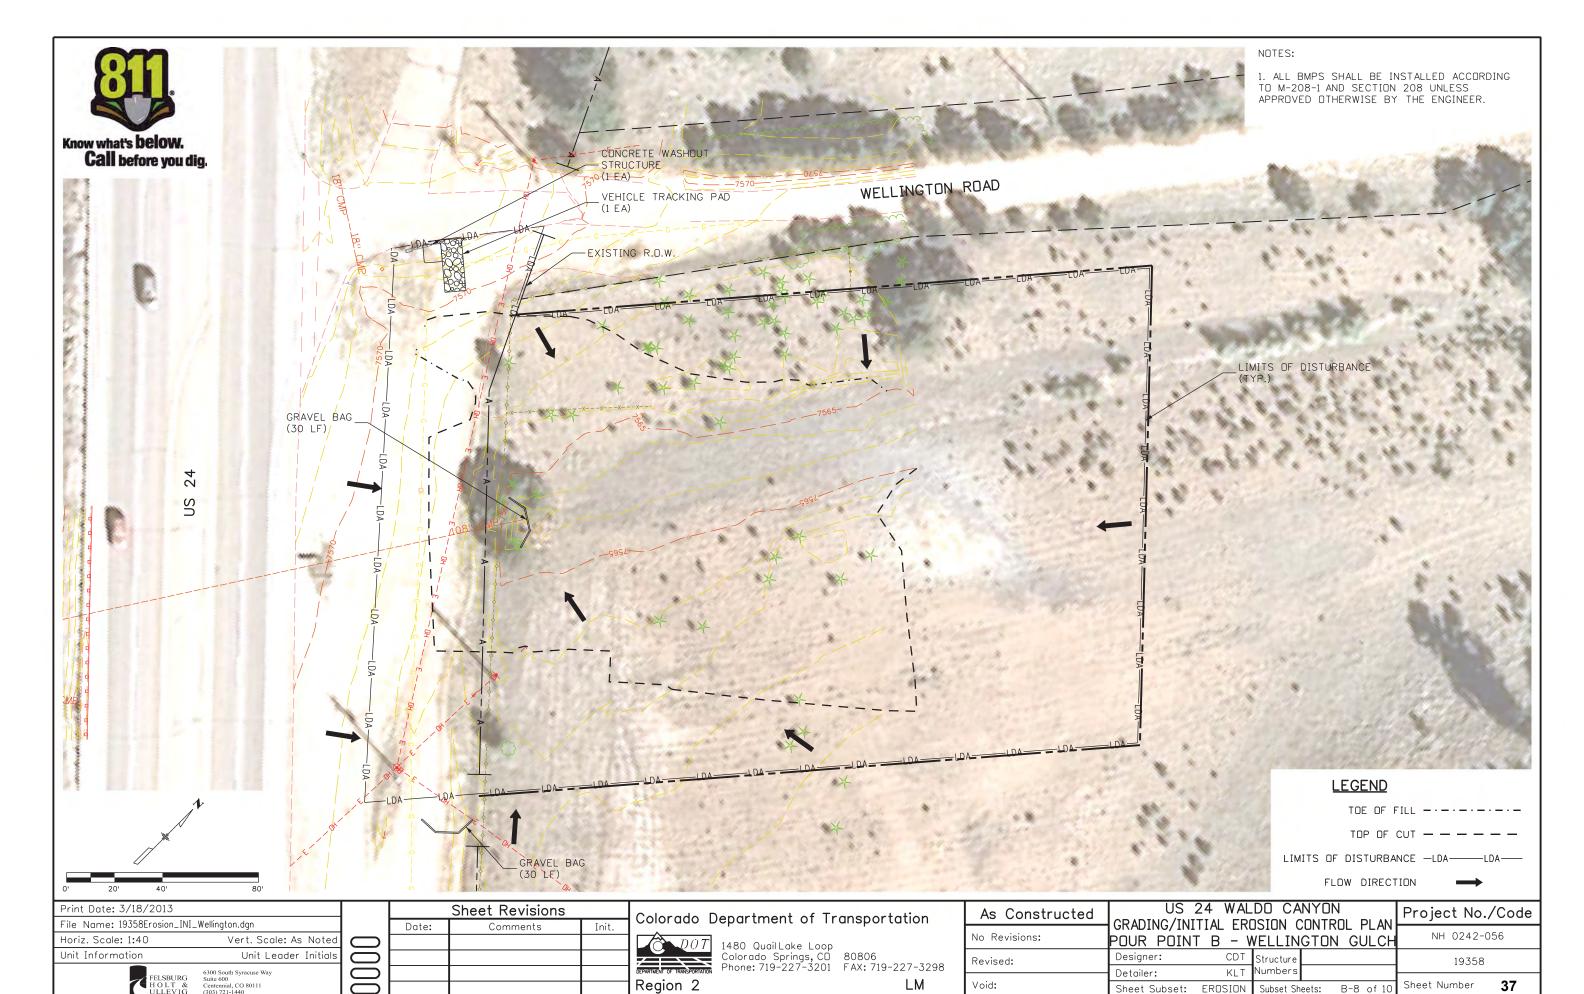
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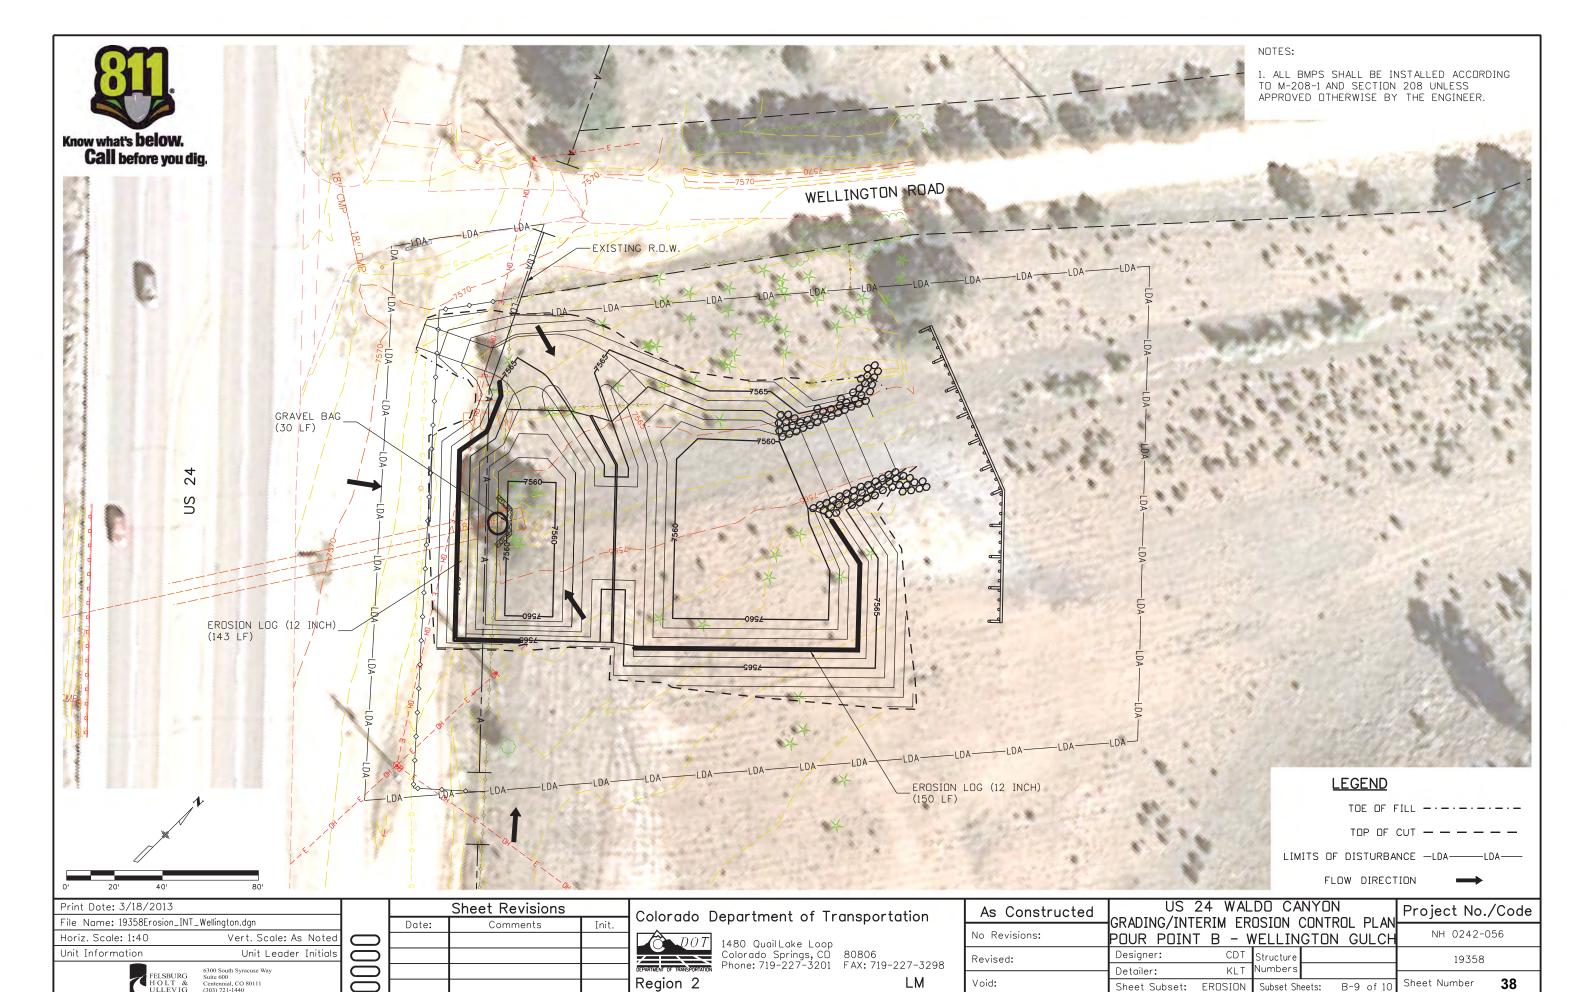
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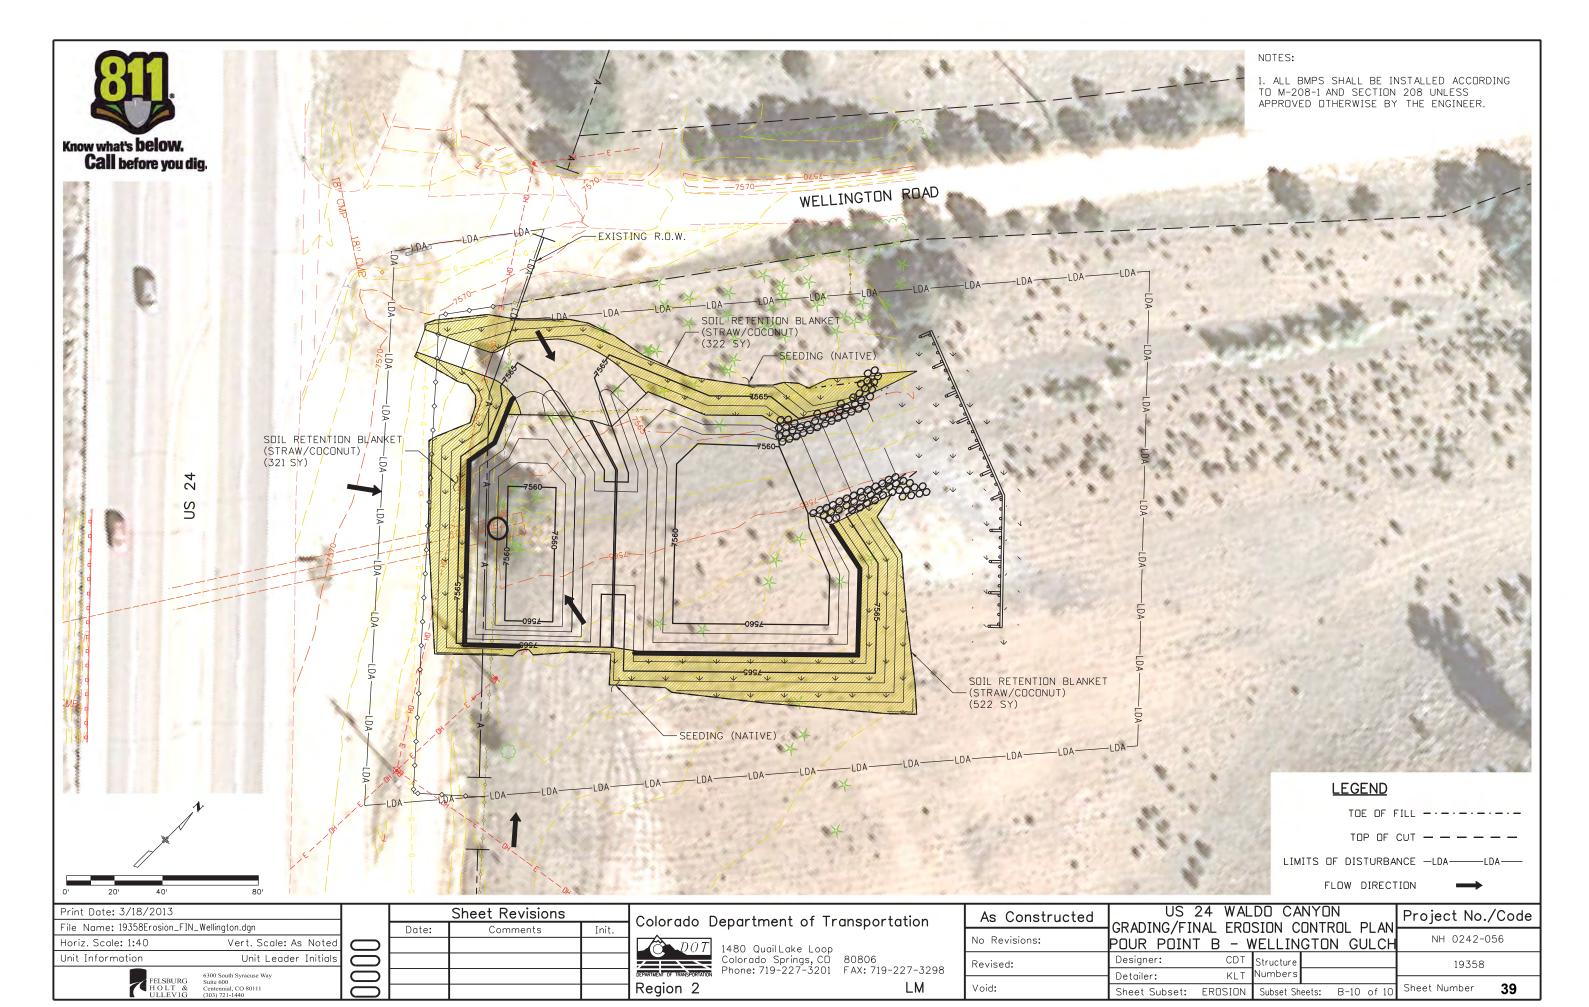
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Revised:	Designer: CDT Structure Detailer: KLT Numbers		19358	
Void:	881811	5 of 10	Sheet Number 34	











POUR POINT C TABULATION

CONTRACT ITEM NO.	CONTRACTITÉM	UNIT	QUANTITY
201-00001	CLEARING AND GRUBBING	LS	1
202-00010	REMOVAL OF TREE	EA	17
202-00220	REMOVAL OF ASPHALT MAT	SY	792
202-01000	REMOVAL OF FENCE	LF	137
202-04002	CLEAN CULVERT	EA	7
203-00010	UNCLASSIFIED EXCAVATION (COMPLETE IN PLACE)	CY	3000
203-01622	SWEEPING (WITH PICKUP BROOM)	HR	40
207-00205	TOPSOIL	CY	320
208-00002	EROSION LOG (12 INCH)	LF	1300
208-00020	SILT FENCE	LF	241
208-00034	GRAVEL BAG	LF	486
208-00045	CONCRETE WASHOUT STRUCTURE	EA	1
208-00070	VEHICLE TRACKING PAD	EA	1
208-00103	REMOVAL AND DISPOSAL OF SEDIMENT (LABOR)	HR	80
208-00105	REMOVAL AND DISPOSAL OF SEDIMENT (EQUIPMENT)	HR	40
208-00205	EROSION CONTROL SUPERVISOR	DAY	30
210-01130	RESET GUARDRAIL TYPE 3	LF	43
212-00006	SEEDING (NATIVE)	AC	0.4
212-00032	SOIL CONDITIONING	AC	0.4
213-00002	MULCHING (WEED FREE)	AC	0.4
214-00450	EVERGREEN TREE (5 GALLON CONTAINER)	EA	17
216-00041	SOIL RETENTION BLANKET (STRAW/COCONUT)	SY	2105
304-06000	AGGREGATE BASE COURSE (CLASS 6)	CY	23
420-00102	GEOTEXTILE (EROSION CONTROL) (CLASS 1)	SY	1171
506-00030	GROUTED RIPRAP	CY	120
506-00412	SOIL RIPRAP (12 INCH)	CY	423
507-00725	SLOPE AND DITCH PAVING (SPECIAL)	CY	120
601-01000	CONCRETE CLASS B	CY	103
603-01240	24 INCH REINFORCED CONCRETE PIPE (CIP)	LF	154
603-01420	42 INCH REINFORCED CONCRETE PIPE (CIP)	LF	108
603-05024	24 INCH REINFORCED CONCRETE END SECTION	EA	4
603-05042	42 INCH REINFORCED CONCRETE END SECTION	EA	2
604-50050	INLET GRATING AND FRAME SPECIAL	EA	1
608-00100	REINFORCED GRASS/CONCRETE POROUS PAVEMENT	SY	491

NOTE: TREES SHALL BE PLACED AS DIRECTED BY THE ENGINEER.

	INDEX		ITEM	PROJECT TOTALS	
воок	PAGE	SHEET	ITEM	PROJECT TOTALS	
			EMBANKMENT MATERIAL (CIP) (FOR INFO. ONLY)	CU. YDS.	
			CASCADE SLIDE AREA	881	
			SUBTOTAL	881	
			TOTAL	881	
			UNCLASSIFIED EXCAVATION	CU. YDS.	
			CASCADE SLIDE AREA	2,921	
			OTHER EXCAVATION	79	
			SUBTOTAL	3,000	
			TOTAL FOR PAY QUANTITY	3,000	

	COMPACTION (FOR INFORMATION ONLY) (MOISTURE & DENSITY CONTROL) EMBANKMENT (NET)	881
	TOTAL	881
1	WETTING QUANTITIES (FOR INFORMATION ONLY) COMPACTION	M. GAL.
	(881 x 0.040 M. GAL./yd) TOTAL	35 35
1	ACCESS ROAD QUANTITIES BALANCE (FOR INFORMATION ONLY	CU. YDS.
	EMBANKMENT (NET)	881
	EMBANKMENT X FACTOR (1.15)	1,013
	BALANCE TOTAL	1,013
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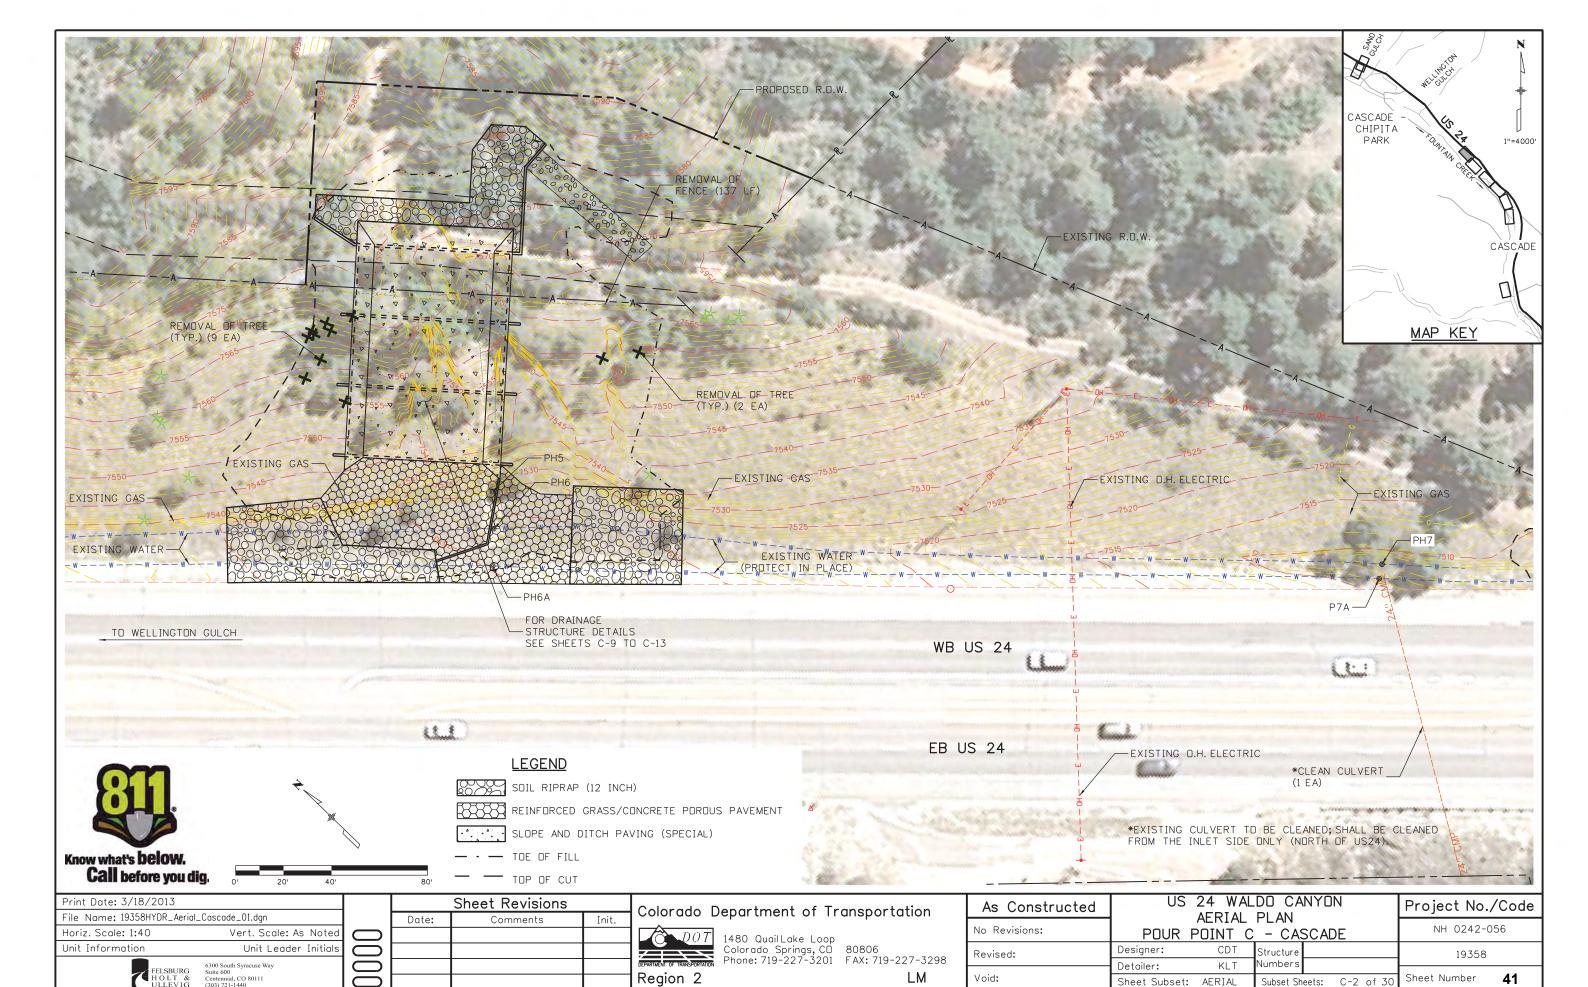
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HOLT & ULLEVIG	Centennial, CO 80111 (303) 721-1440		


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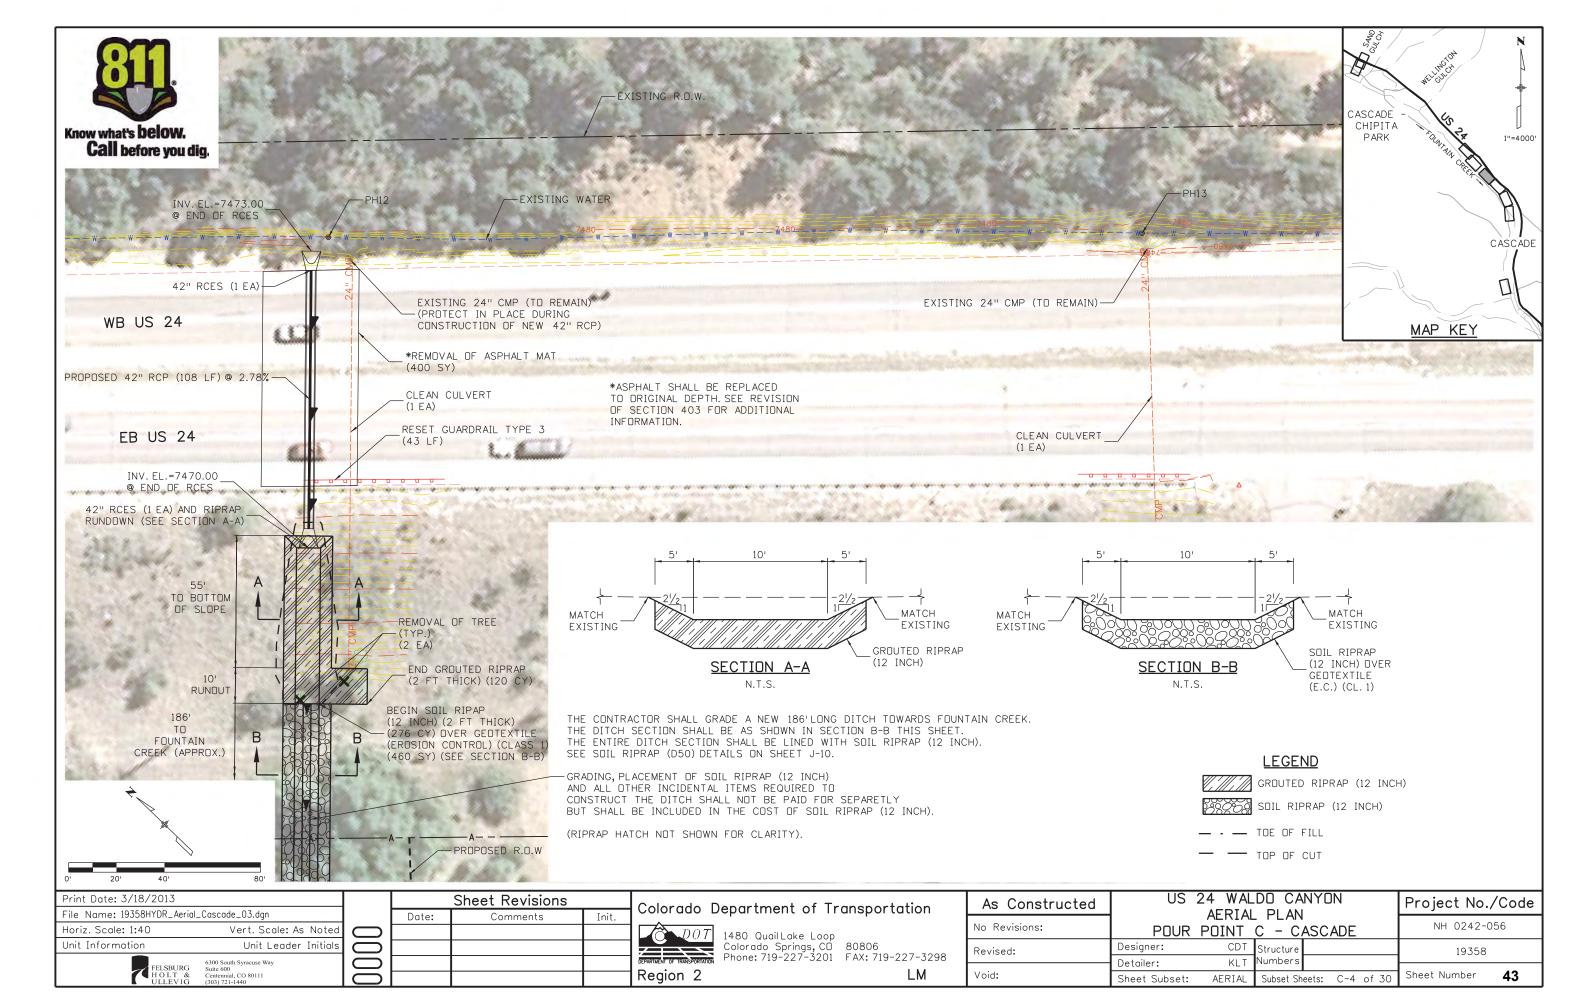
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Colorado Springs, CD 80806 Phone: 719-227-3201 FAX: 719-227-3298	


As Constructed	US	DO CANYON ATION			Project No./Code		
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Revised:	Designer:	CDT	Structure			19358	
	Detailer:	KLT	Numbers				
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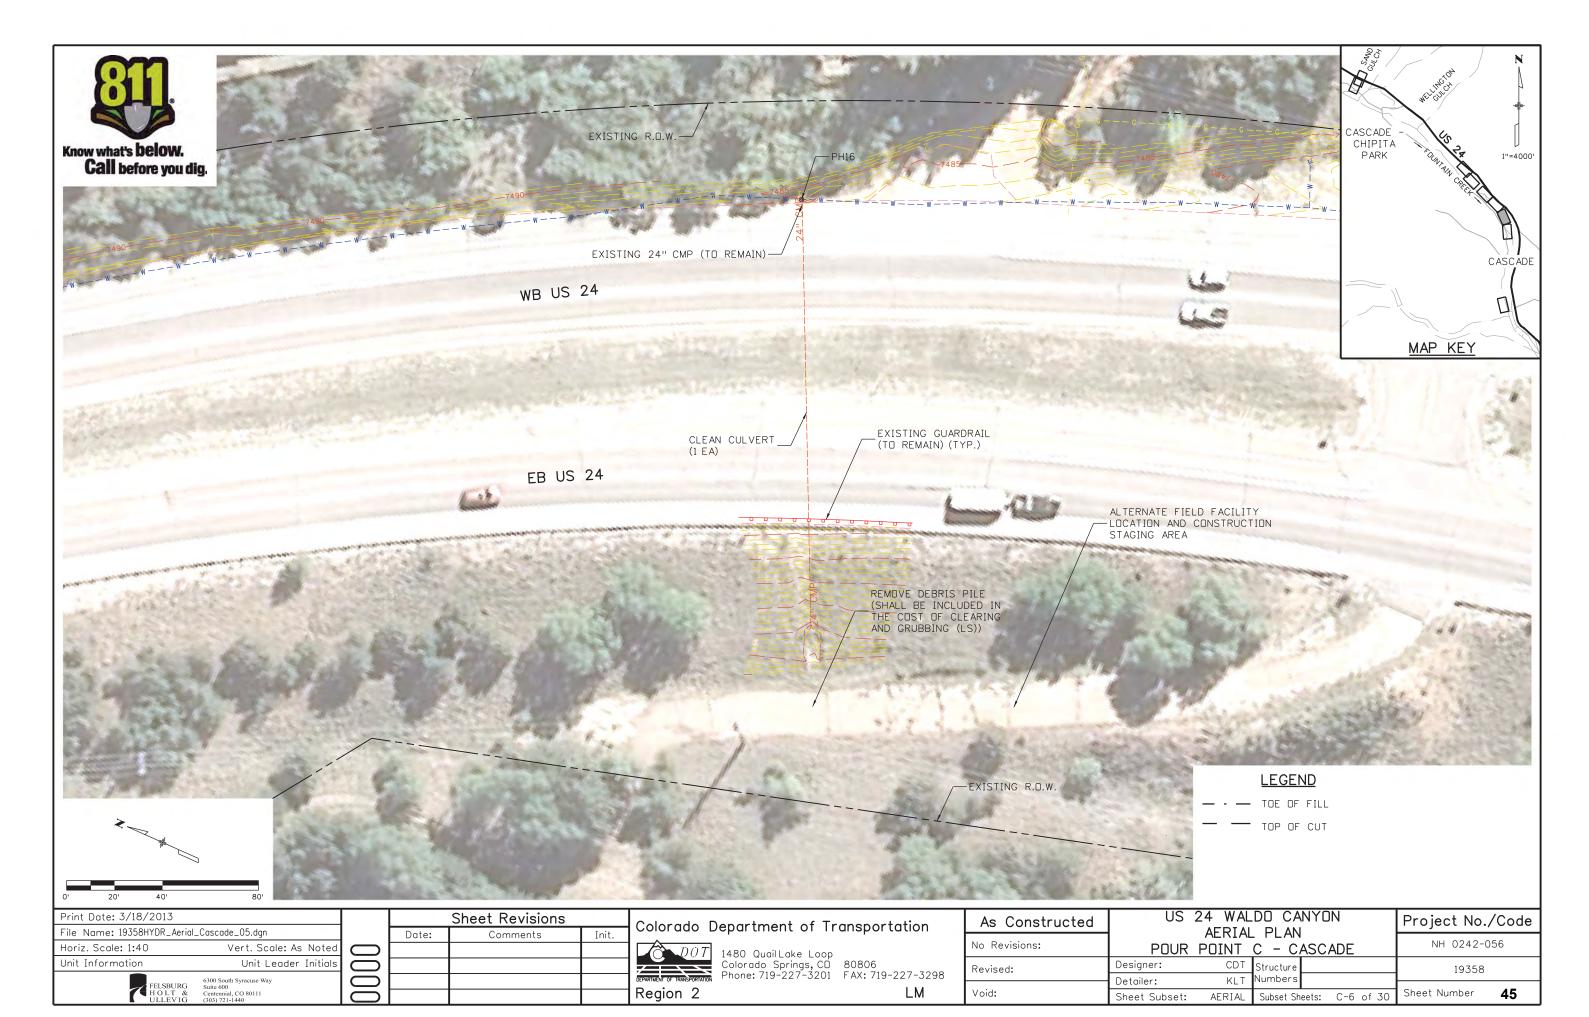
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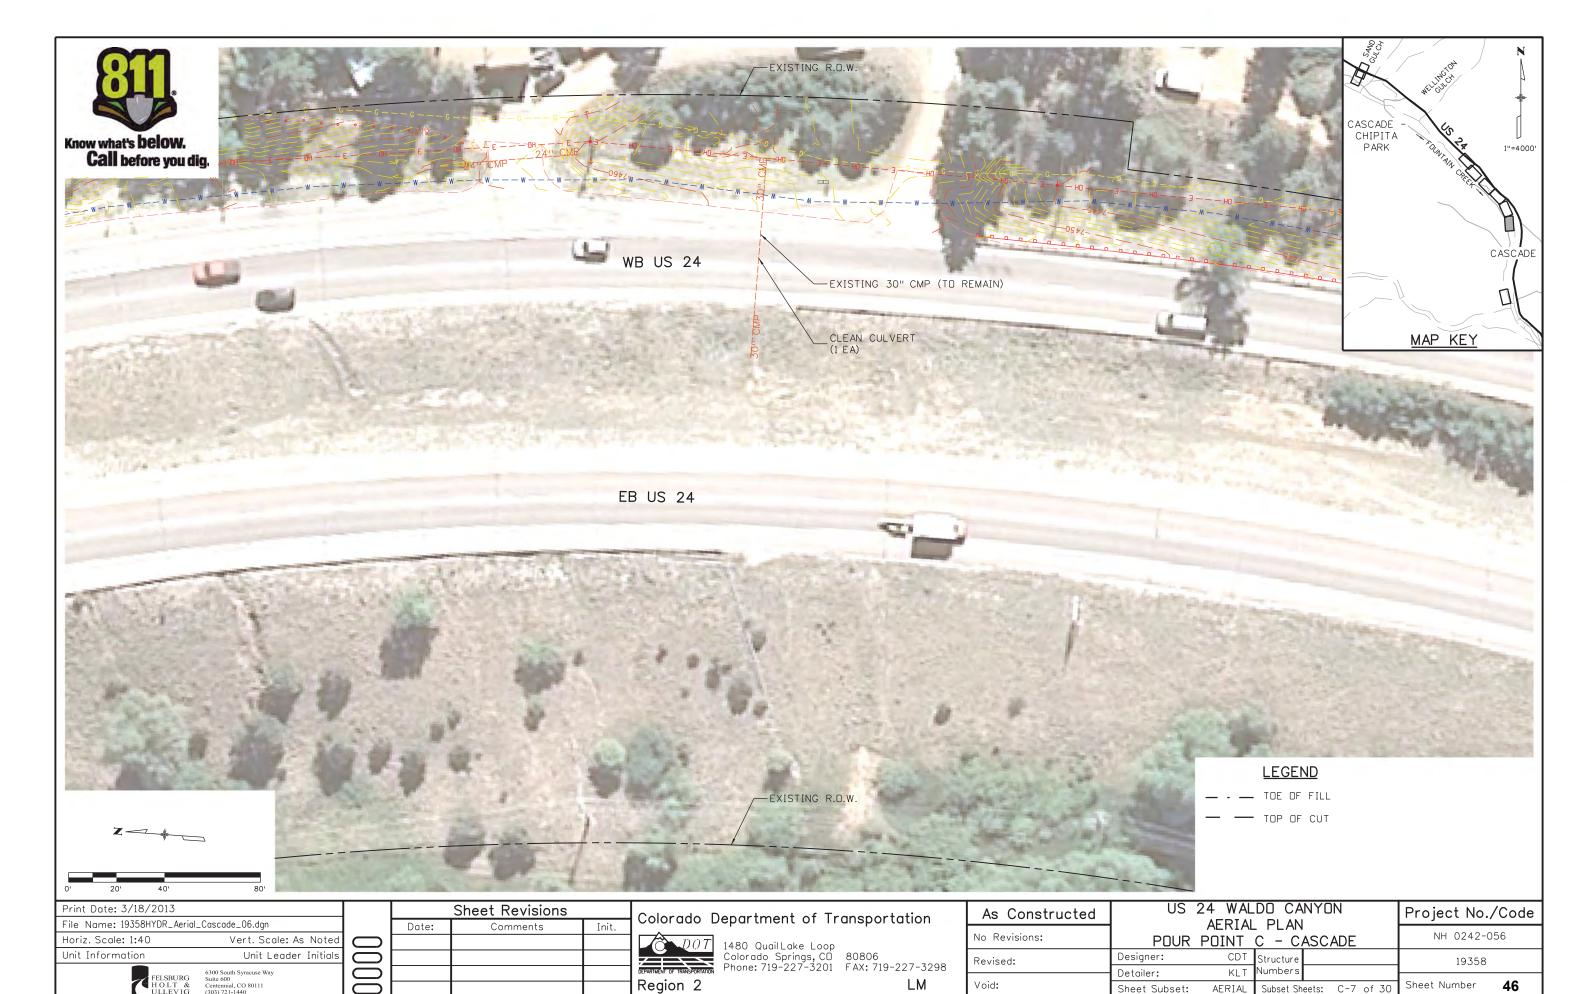








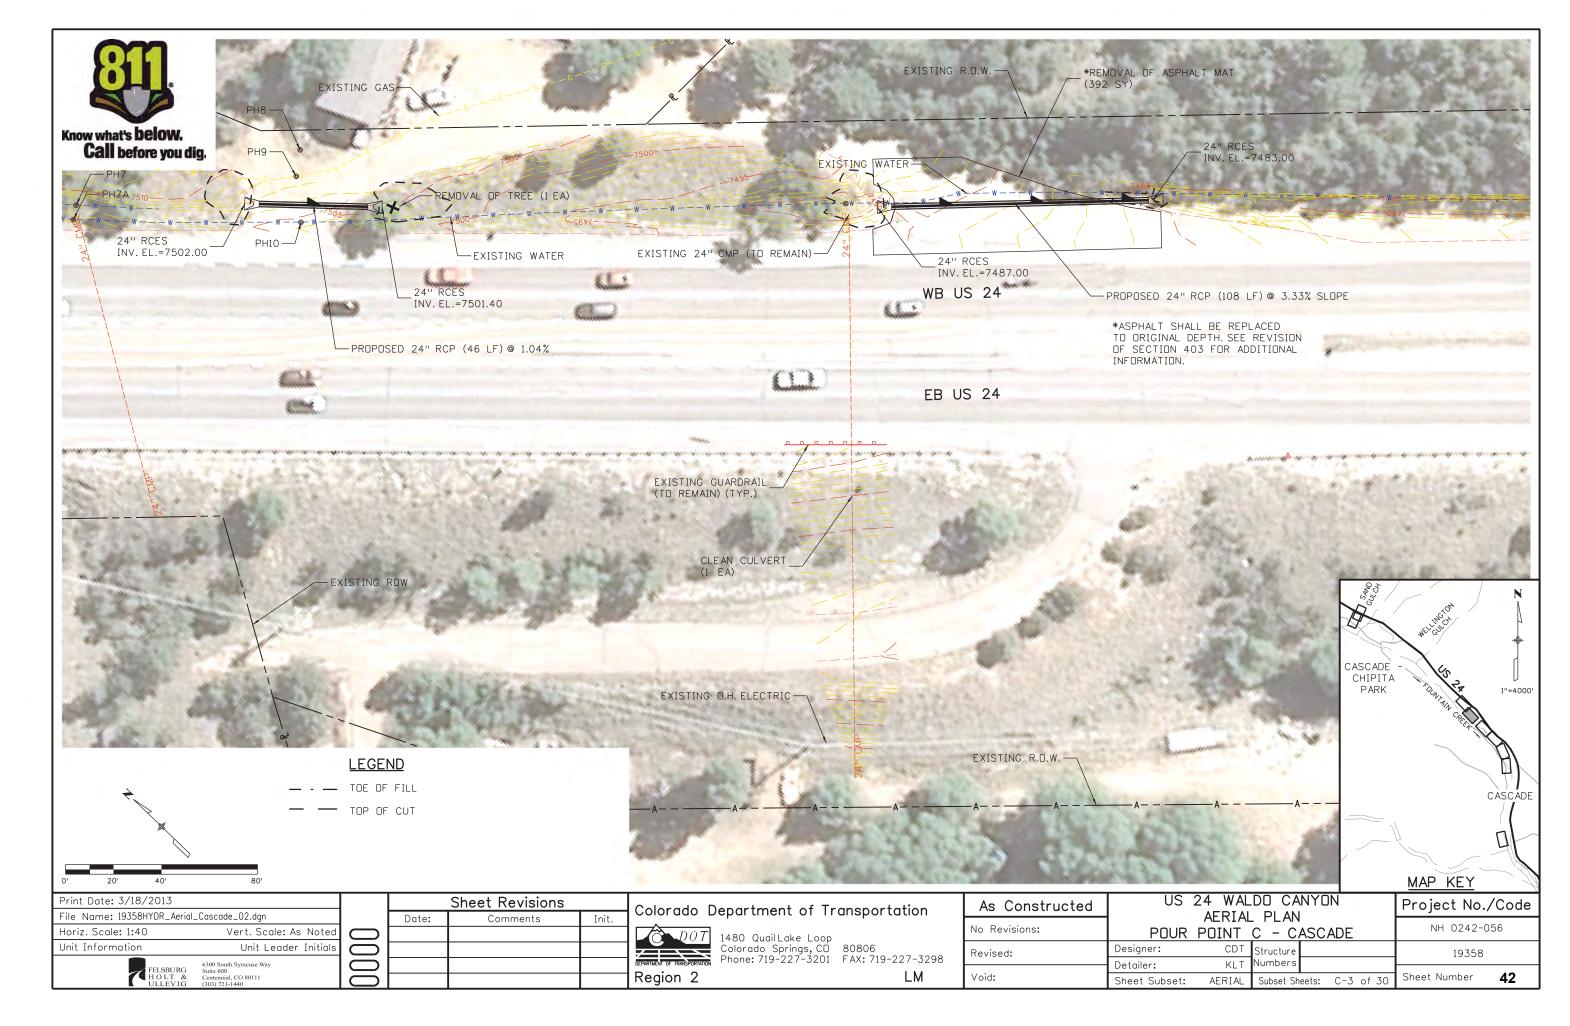

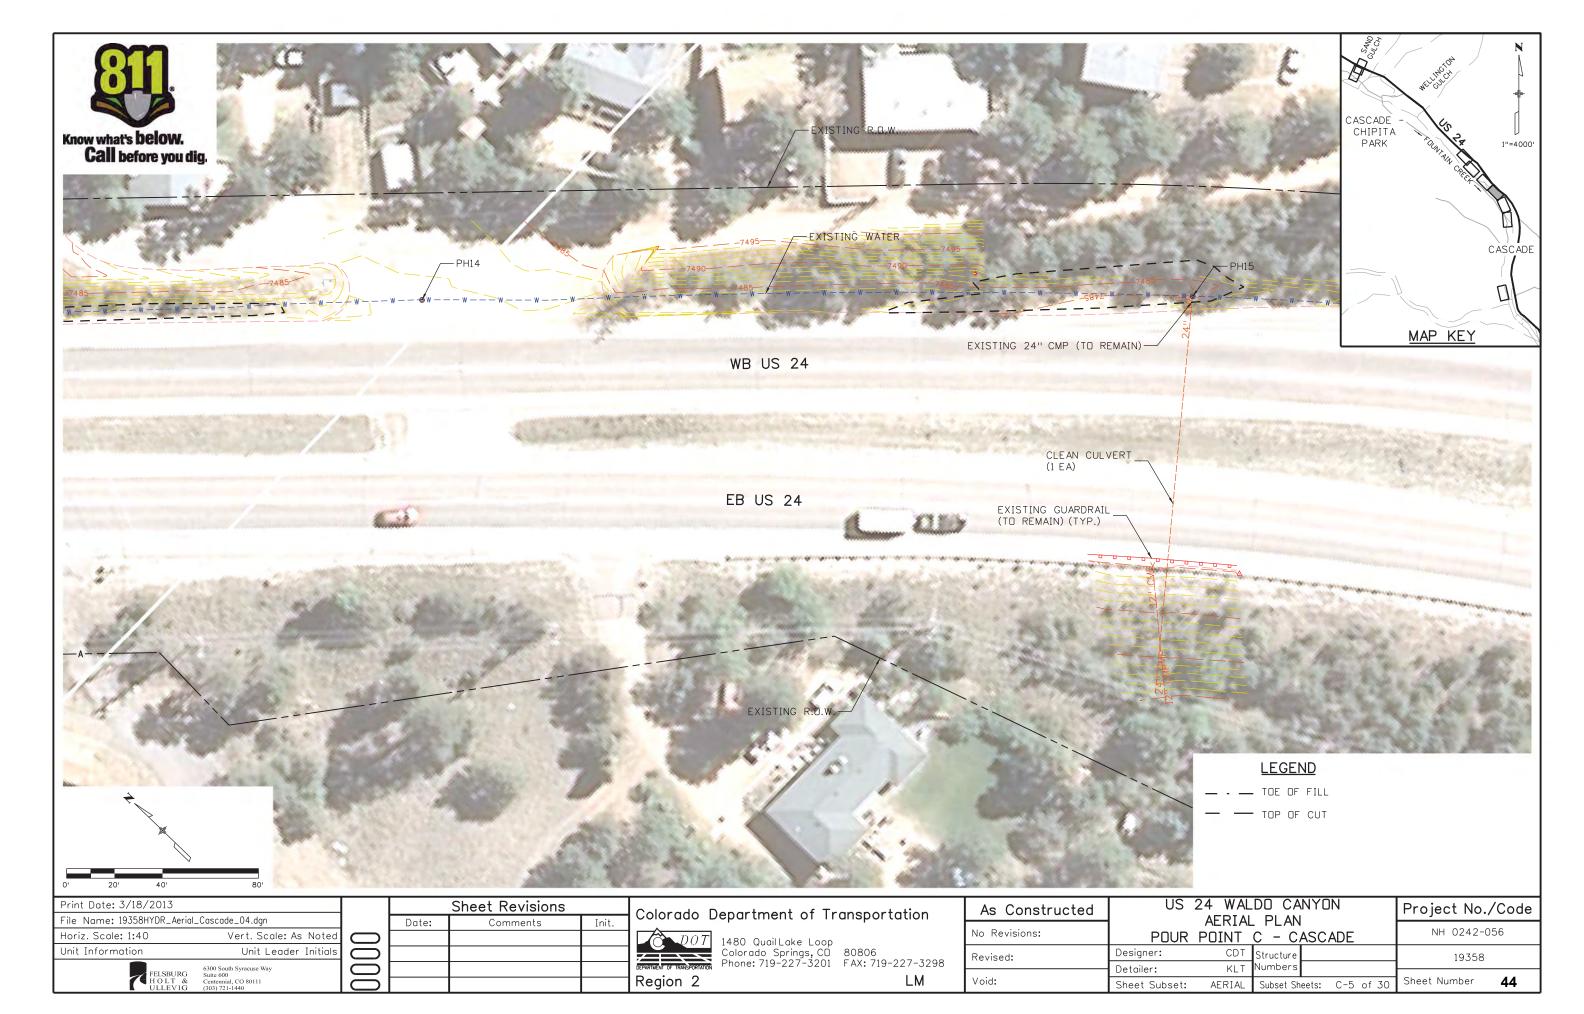



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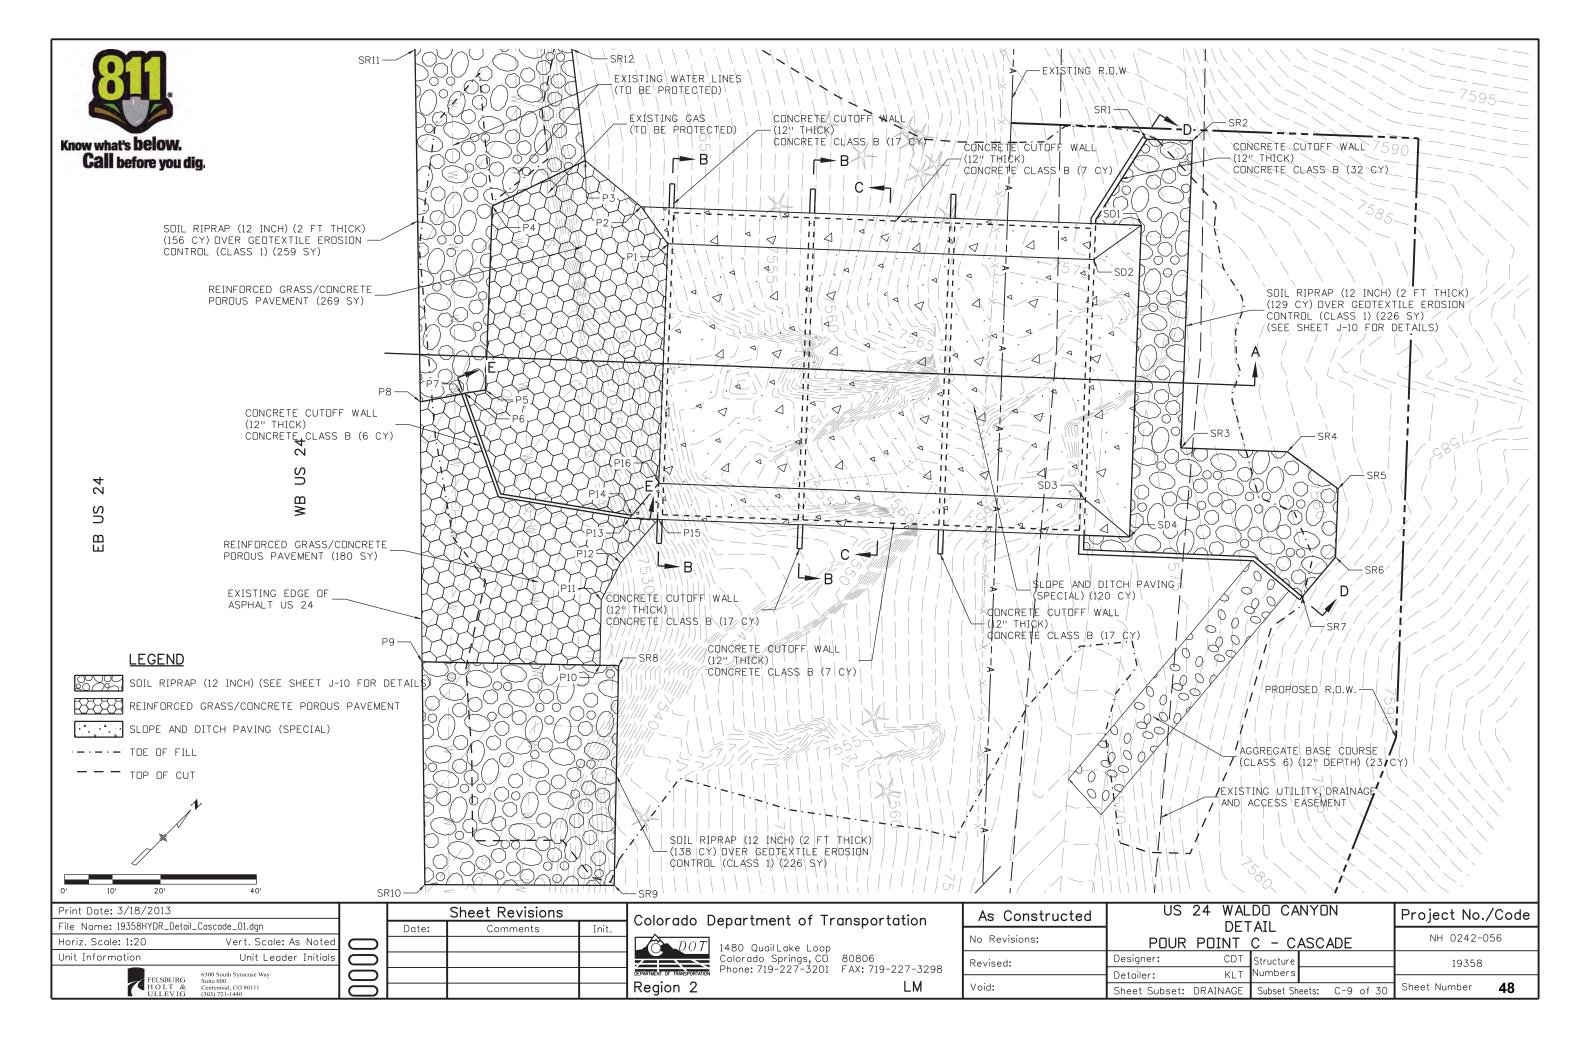
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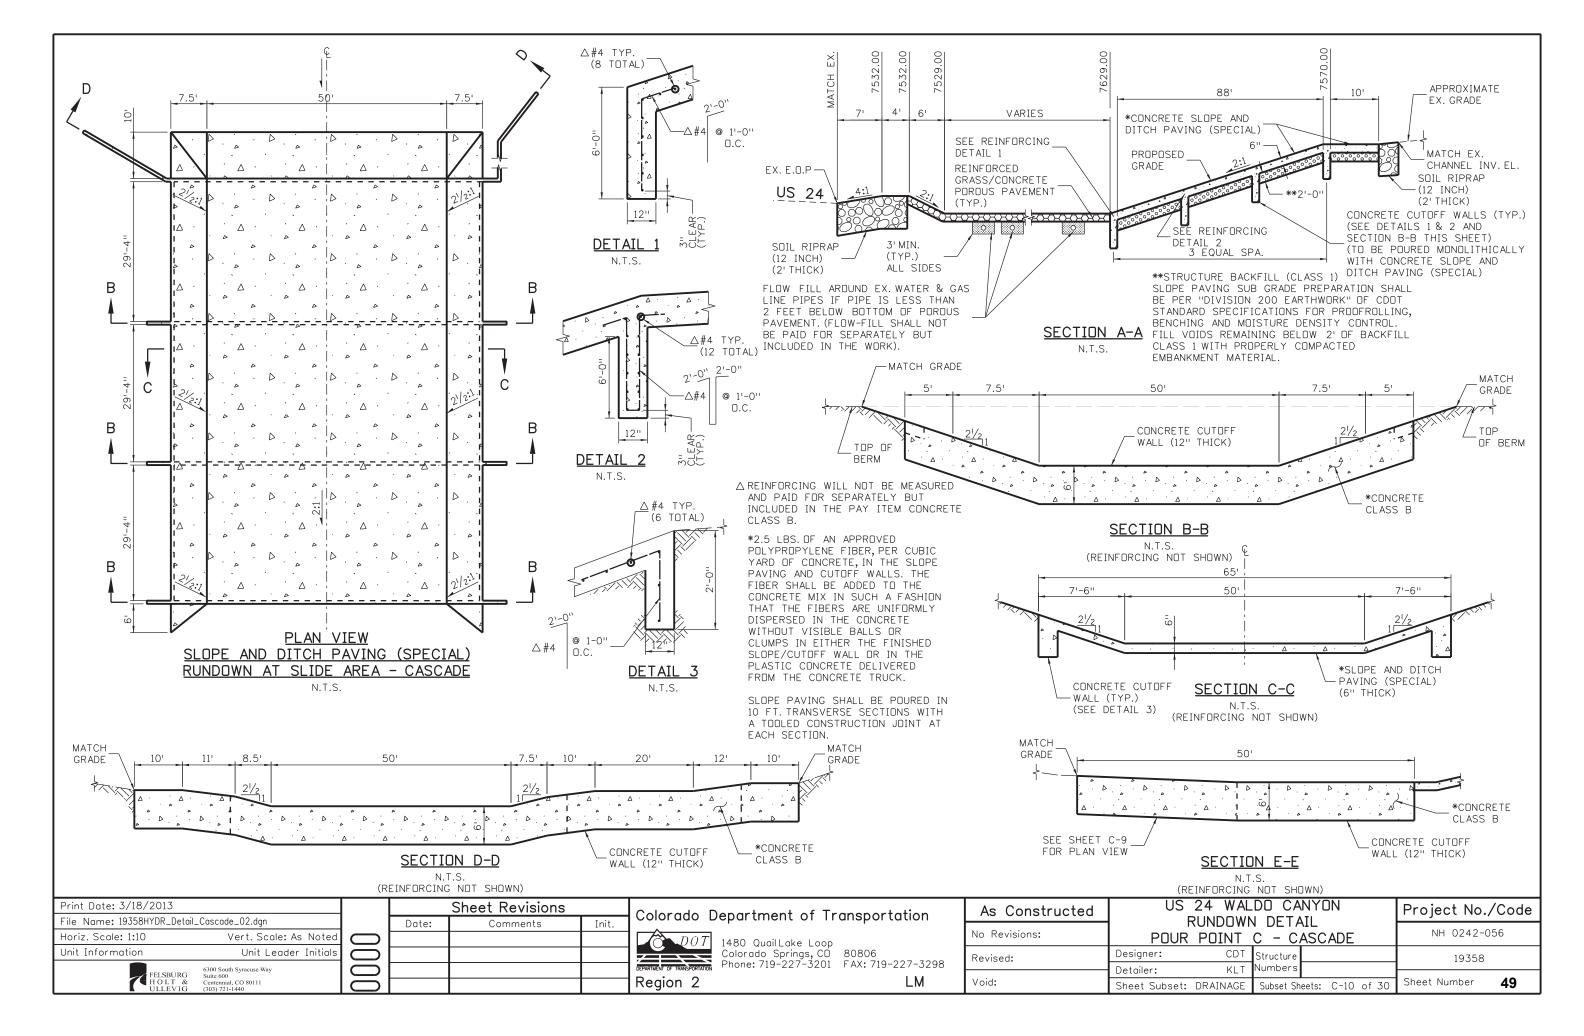
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Subset Sheets: C-8 of 30

Sheet Number

Region 2





POINT DATA TABLE - POUR POINT C - GRADING

POINT	NORTHING	EASTING	ELEVATION	DESCRIPTION
G1	393979.89	150030.24	7534.00	FINISHED GRADE
G2	393993.50	150029.05	7534.00	FINISHED GRADE
G3	393965.98	150042.28	7534.00	FINISHED GRADE
G4	393959.49	150044.49	7533.00	FINISHED GRADE
G5	393956.04	150056.19	7534.00	FINISHED GRADE
G6	393959.66	150058.32	7534.00	FINISHED GRADE
G7	393944.43	150058.82	7532.00	FINISHED GRADE
G8	393943.96	150069.61	7533.00	FINISHED GRADE
G9	393947.32	150071.64	7533.00	FINISHED GRADE
G10	393933.74	150072.82	7531.00	FINISHED GRADE
G11	393929.41	150092.20	7532.00	FINISHED GRADE
G12	393930.49	150093.83	7532.00	FINISHED GRADE
G13	393935.24	150090.66	7532.00	FINISHED GRADE
G14	393920.30	150092.96	7530.00	FINISHED GRADE
G15	393917.28	150102.85	7528.00	FINISHED GRADE
G16	393914.86	150113.64	7526.00	FINISHED GRADE
G17	393902.23	150111.91	7528.00	FINISHED GRADE
G18	393876.57	150136.72	7526.00	FINISHED GRADE
G19	393920.77	150122.49	7526.00	FINISHED GRADE
G20	393935.00	150114.99	7530.00	FINISHED GRADE
G21	393941.24	150117.13	7531.00	FINISHED GRADE
G22	393944.37	7 150088.20 7529.00		FINISHED GRADE
G23	393958.87	150109.92 7529.00		FINISHED GRADE
G24	393950.61	150079.37 7529.00 FINISHED GRAD		
G25	325 393971.41 150061.38		7529.00	FINISHED GRADE
G26	393984.12	150066.24	7529.00	FINISHED GRADE
G27	393993.61	150077.22	7529.00	FINISHED GRADE
G28	393993.03	150080.36	7529.00	FINISHED GRADE
G29	393975.35	150050.04	7532.00	FINISHED GRADE
G30	393989.46	150059.72	7531.00	FINISHED GRADE
G31	393997.24	150054.13	7533.00	FINISHED GRADE
G32	393997.44	150044.05	7534.00	FINISHED GRADE
G33	394013.08	150034.09	7541.00	FINISHED GRADE
G34	394034.63	150055.11	7552.00	FINISHED GRADE
G35	394046.16	150104.36	7565.00	FINISHED GRADE

POINT	NORTHING	EASTING	ELEVATION	DESCRIPTION
G36	394064.09	150125.26	7575.00	FINISHED GRADE
G37	394070.02	150127.21	7576.00	FINISHED GRADE
G38	394078.49	150137.84	7580.00	FINISHED GRADE
G39	394079.74	150141.67	7580.00	FINISHED GRADE
G40	394057.97	150126.40	7575.00	FINISHED GRADE
G41	394064.79	150140.39	7580.00	FINISHED GRADE
G42	394067.82	150143.90	7580.00	FINISHED GRADE
G43	394077.89	150160.12	7579.00	FINISHED GRADE
G44	394061.27	150154.67	7576.00	FINISHED GRADE
G45	394018.92	150191.30	7576.00	FINISHED GRADE
G46	394023.80	150206.11	7578.00	FINISHED GRADE
G47	394034.95	150203.92	7578.00	FINISHED GRADE
G48	394041.92	150215.57	7579.00	FINISHED GRADE
G49	394034.53	150227.29	7581.00	FINISHED GRADE
G50	394033.93	150215.99	7581.00	FINISHED GRADE
G51	394025.94	150216.41	7581.00	FINISHED GRADE
G52	394026.62	150229.29	7581.00	FINISHED GRADE
G53	394022.47	150226.61	7580.00	FINISHED GRADE
G54	394021,10	150209.11	7578.00	FINISHED GRADE
G55	394005.55	150209.48	7574.00	FINISHED GRADE
G56	394009.27	150189.32	7578.00	FINISHED GRADE
G57	394006.29	150191.99	7578.00	FINISHED GRADE
G58	393967.00	150197.02	7567.00	FINISHED GRADE
G59	393975.10	150201.79	7568.00	FINISHED GRADE
G60	393982.00	150218.73	7570.00	FINISHED GRADE
G61	393982.53	150228.71	7570.00	FINISHED GRADE
G62	393980.16	150246.51	7578.00	FINISHED GRADE
G63	393948.04	150208.65	7565.00	FINISHED GRADE
G64	393989.44	150165.29	7563.00	FINISHED GRADE
G65	393926.94	150183.21	7552.00	FINISHED GRADE
G66	393916.07	150160.58	7542.00	FINISHED GRADE
G67	393934.58	150130.41	7538.00	FINISHED GRADE
G68	393933.75	150117.42	7531.00	FINISHED GRADE
G69	393928.44	150127.45	7535.00	FINISHED GRADE
G70	393898.54	150161.41	7538.00	FINISHED GRADE

Init.

Region 2

POINT DATA TABLE - POUR POINT C - CUTOFF WALL

POINT	NORTHING	EASTING	ELEVATION	DESCRIPTION
W1	394078.52	150139.87	7580.00	CONCRETE CUTOFF WALL - FINISHED GRADE EL.
W2	394066.30	150142.14	7580.00	CONCRETE CUTOFF WALL - FINISHED GRADE EL.
W3	394058.86	150143.53	7577.50	CONCRETE CUTOFF WALL - FINISHED GRADE EL.
VV4	394006.33	150188.98	7577.33	CONCRETE CUTOFF WALL - FINISHED GRADE EL.
W5	394007.78	150190.66	7578.00	CONCRETE CUTOFF WALL - FINISHED GRADE EL.
W6	394024.31	150209.77	7579.00	CONCRETE CUTOFF WALL - FINISHED GRADE EL.
W7	394029.94	150216.27	7581.00	CONCRETE CUTOFF WALL - FINISHED GRADE EL.
W8	394030.61	150229.08	7581.00	CONCRETE CUTOFF WALL - FINISHED GRADE EL.
W9	394034.32	150109.00	7578.04	CONCRETE CUTOFF WALL - FINISHED GRADE EL.
W10	393977.60	150158.06	7557.75	CONCRETE CUTOFF WALL - FINISHED GRADE EL.
W11	394004.34	150074.33	7535.25	CONCRETE CUTOFF WALL - FINISHED GRADE EL.
W12	393947.61	150123.40	753.5.25	CONCRETE CUTOFF WALL - FINISHED GRADE EL.
W13	393942.63	150072.31	7532.75	CONCRETE CUTOFF WALL - FINISHED GRADE EL.
W14	393932.28	150092.30	7532.00	CONCRETE CUTOFF WALL - FINISHED GRADE EL.
W15	393933.42	150094.01	7531.00	CONCRETE CUTOFF WALL - FINISHED GRADE EL.
W16	393947.64	150115.32	7531,00	CONCRETE CUTOFF WALL - FINISHED GRADE EL.

POINT DATA TABLE - POUR POINT C - SLOPE AND DITCH PAVING

POINT	NORTHING	EASTING	ELEVATION	DESCRIPTION
SD1	394064.67	150151.72	7577.50	SLOPE AND DITCH PAVING FINISHED GRADE ELEVATION
SD2	394052.68	150149.32	7574.50	SLOPE AND DITCH PAVING FINISHED GRADE ELEVATION
SD3	394014.86	150182.03	7574.50	SLOPE AND DITCH PAVING FINISHED GRADE ELEVATION
SD4	394015.52	150194.25	7577.50	SLOPE AND DITCH PAVING FINISHED GRADE ELEVATION

POINT DATA TABLE - POUR POINT C - POROUS PAVERS

POINT	NORTHING	EASTING	ELEVATION	DESCRIPTION
P1	393994.66	150082.26	7530.00	REINFORCED GRASS/CONC. POROUS PAVEMENT FINISHED GRADE EL.
P2	393996.41	150072.81	7531.00	REINFORCED GRASS/CONC. POROUS PAVEMENT FINISHED GRADE EL.
P3	393995.52	150057.76	7532.00	REINFORCED GRASS/CONC. POROUS PAVEMENT FINISHED GRADE EL.
P4	393975.35	150050.04	7532.00	REINFORCED GRASS/CONC. POROUS PAVEMENT FINISHED GRADE EL.
P5	393946.33	150075.15	7532.00	REINFORCED GRASS/CONC. POROUS PAVEMENT FINISHED GRADE EL.
P6	393942.92	150072.46	7532.75	REINFORCED GRASS/CONC. POROUS PAVEMENT FINISHED GRADE EL.
P7	393942.33	150072.15	7532.75	REINFORCED GRASS/CONC. POROUS PAVEMENT FINISHED GRADE EL.
P8	393935.29	150066.90	1	REINFORCED GRASS/CONC. POROUS PAVEMENT MATCH EX. GRADE EL.
P9	393895.89	150104.12	19.5	REINFORCED GRASS/CONC. POROUS PAVEMENT MATCH EX. GRADE EL.
P10	393920.64	150131.75	7533.00	REINFORCED GRASS/CONC. POROUS PAVEMENT FINISHED GRADE EL.
P11	393930.80	150122.65	7533.00	REINFORCED GRASS/CONC. POROUS PAVEMENT FINISHED GRADE EL.
P12	393939.24	150120.33	7533.00	REINFORCED GRASS/CONC. POROUS PAVEMENT FINISHED GRADE EL.
P13	393947.25	150115.34	7531.00	REINFORCED GRASS/CONC. POROUS PAVEMENT FINISHED GRADE EL.
P14	393948.04	150115.31	7531.00	REINFORCED GRASS/CONC. POROUS PAVEMENT FINISHED GRADE EL.
P15	393951.18	150119.87	7533.00	REINFORCED GRASS/CONC. POROUS PAVEMENT FINISHED GRADE EL.
P16	393956.85	150114.97	7530.00	REINFORCED GRASS/CONC. POROUS PAVEMENT FINISHED GRADE EL.

POINT DATA TABLE - POUR POINT C - AGGREGATE BASE COURSE (CL. 6)


POINT NORTHING EASTING			ELEVATION	DESCRIPTION			
BC1	393969.91	150219.36	7569.00	ABC (CL. 6) MATCH EX. GRADE EL.			
BC2	393969.11	150229.42	7569.00	ABC (CL. 6) MATCH EX. GRADE EL.			
BC3	394029.46	150216.23	7581.00	ABC (CL, 6) FINISHED GRADE EL.			
BC4	394030.13	150226.21	7581.00	ABC (CL. 6) FINISHED GRADE EL.			


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File Name: 19358HYDR_Detail_	_Cascade_03.dgn		Date:	Comments
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Unit Information	Unit Leader Initials			
FELSBURG HOLT & HULEVIG	6300 South Syracuse Way Suite 600 Centennial, CO 80111)()		


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DOT	1480 QuailLake Loop Colorado Springs, CO Phone: 719-227-3201	80806


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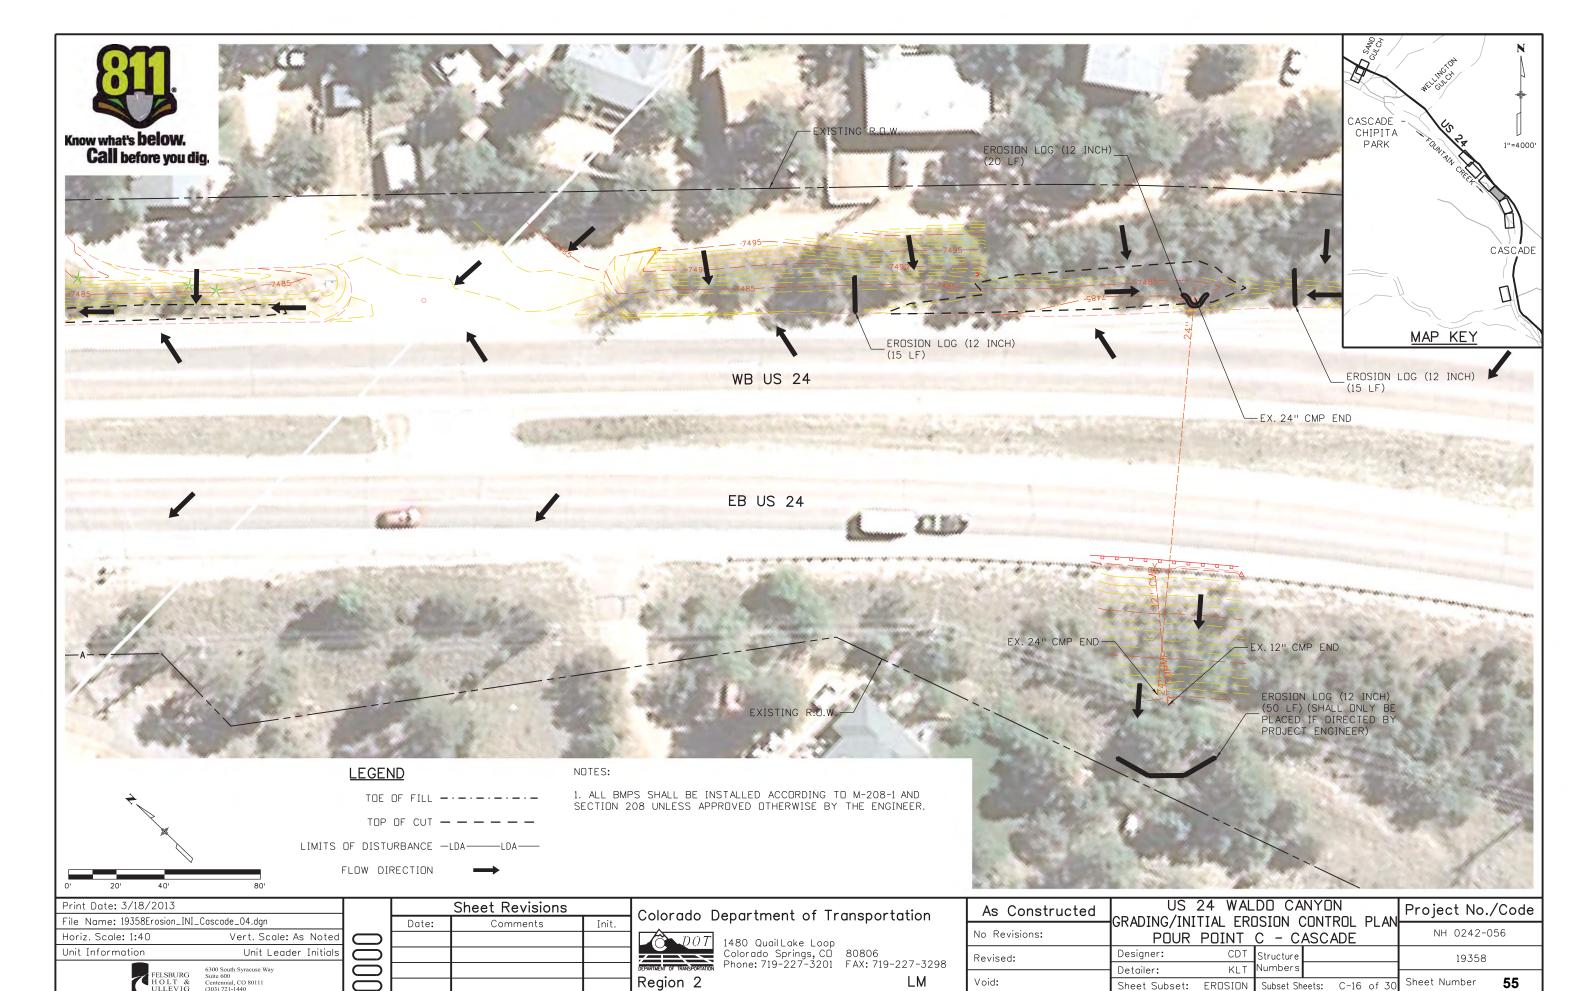
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	Revised:		Structure Numbers	19358
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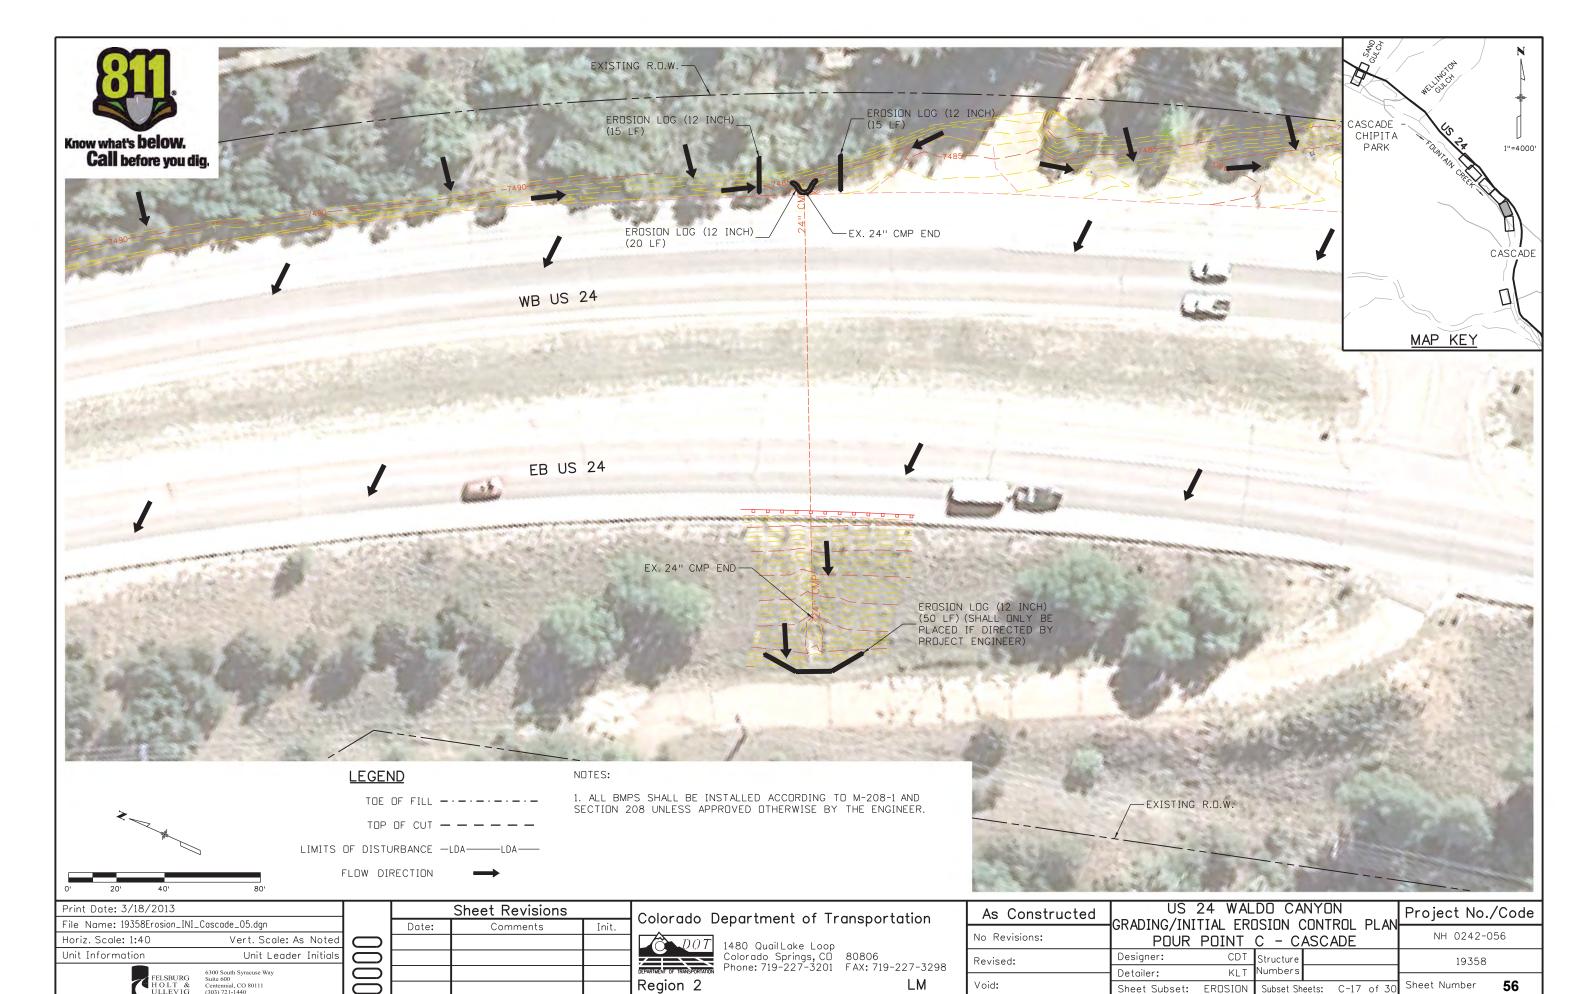





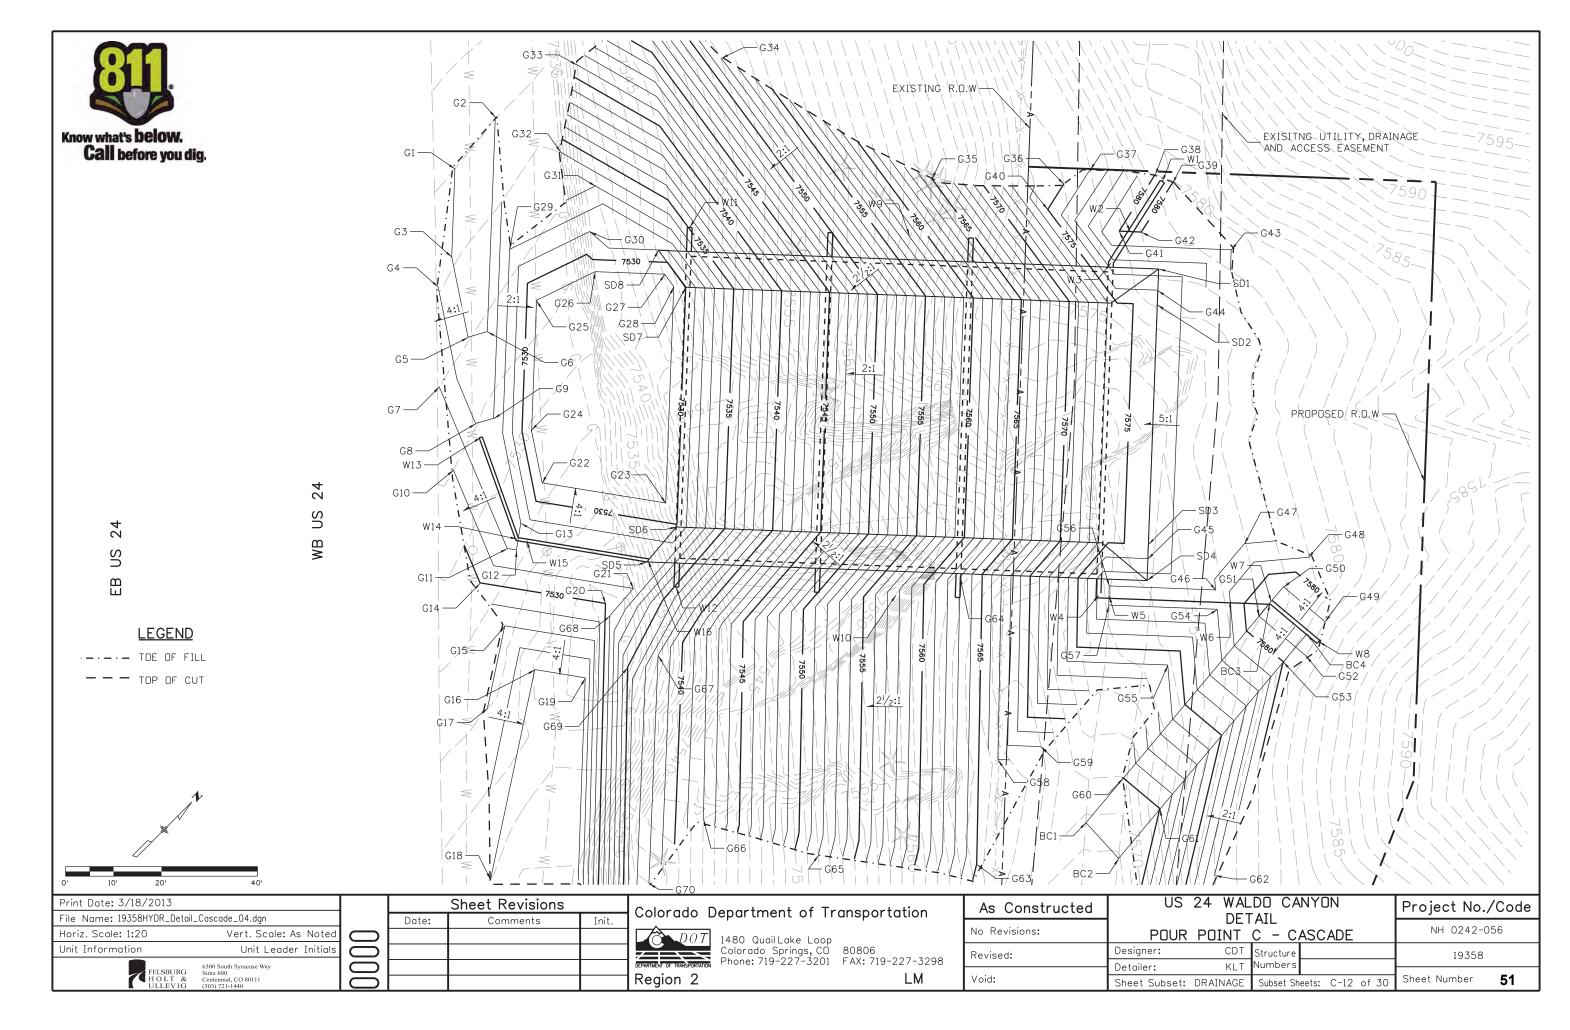


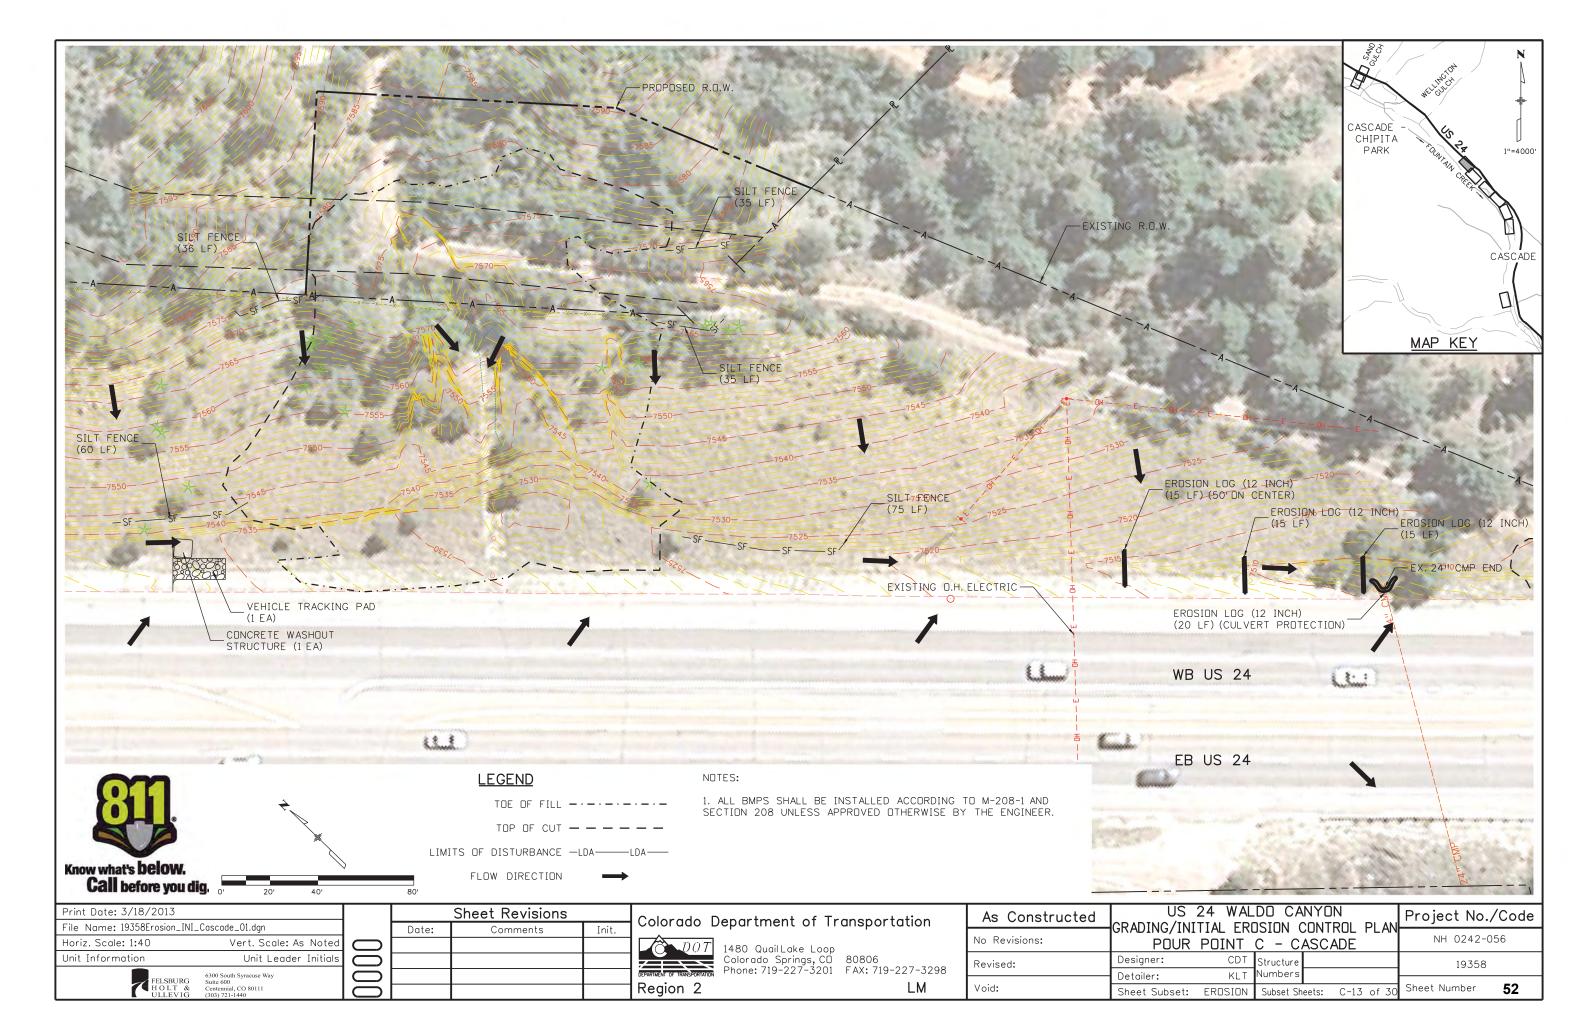


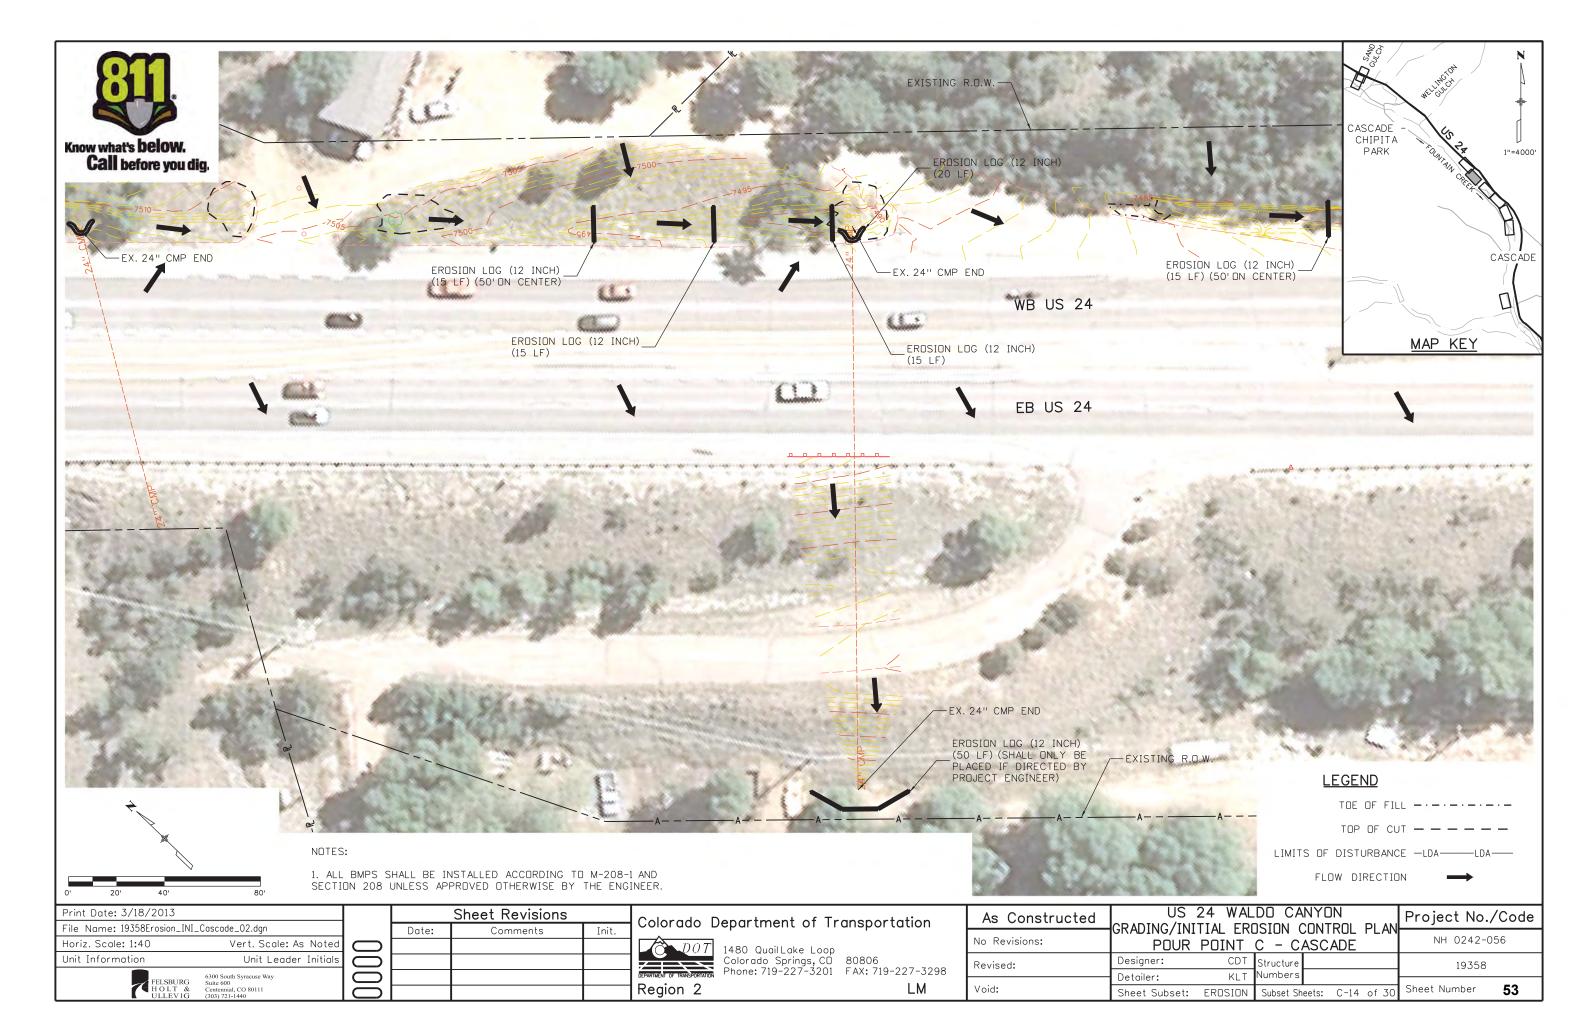


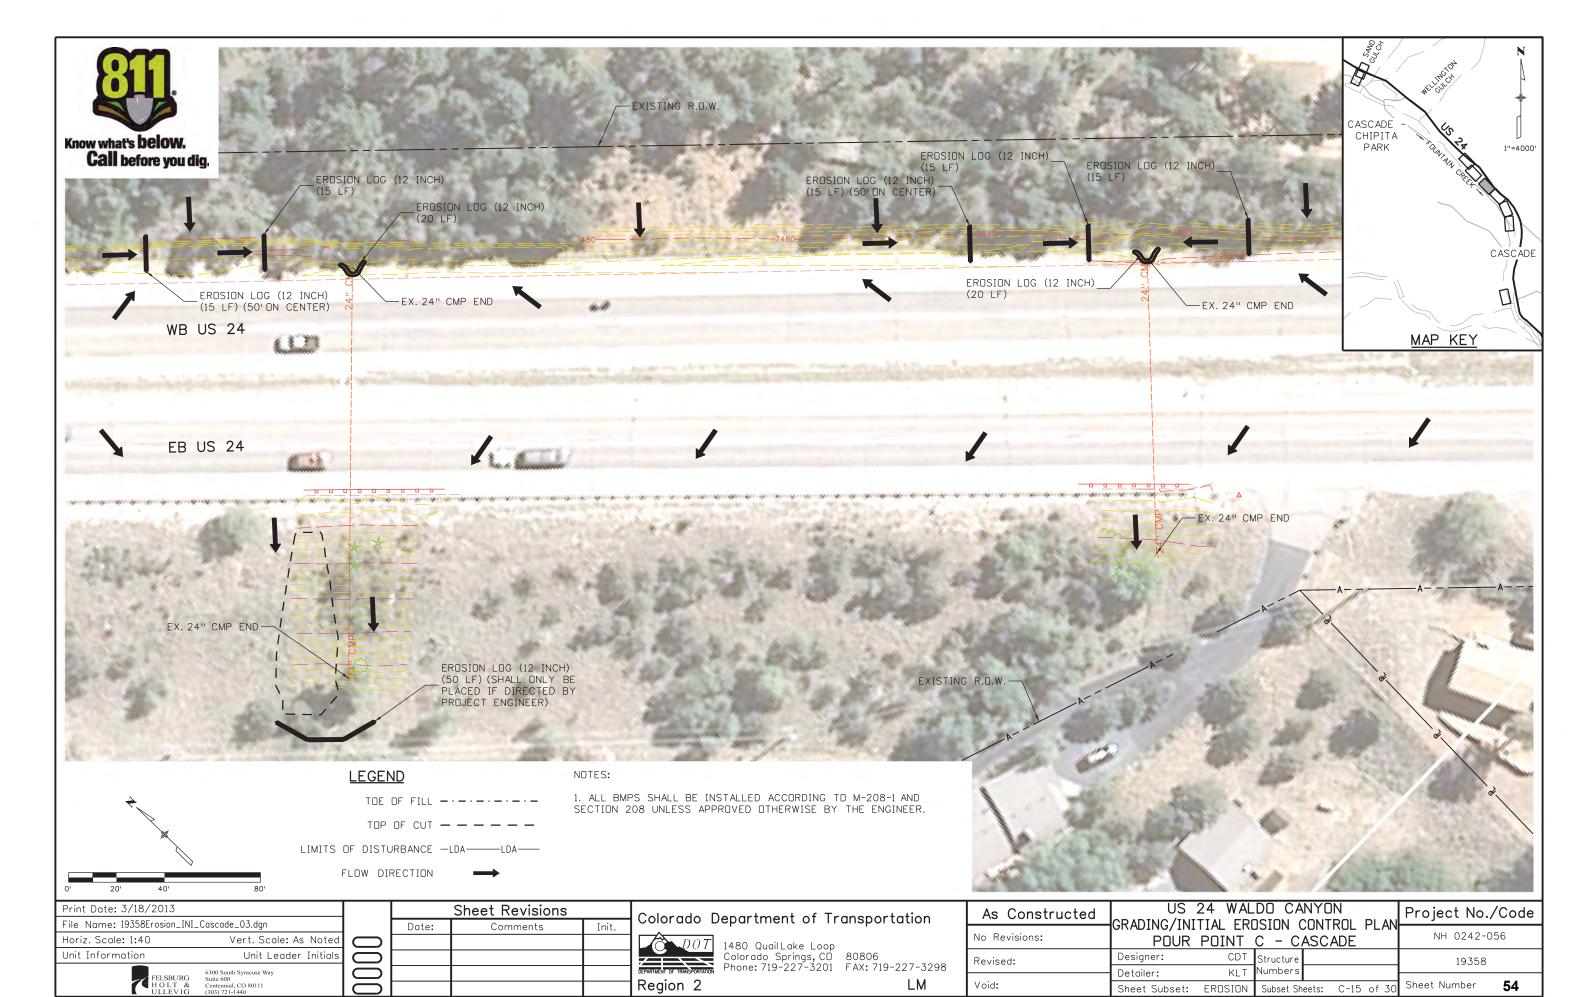


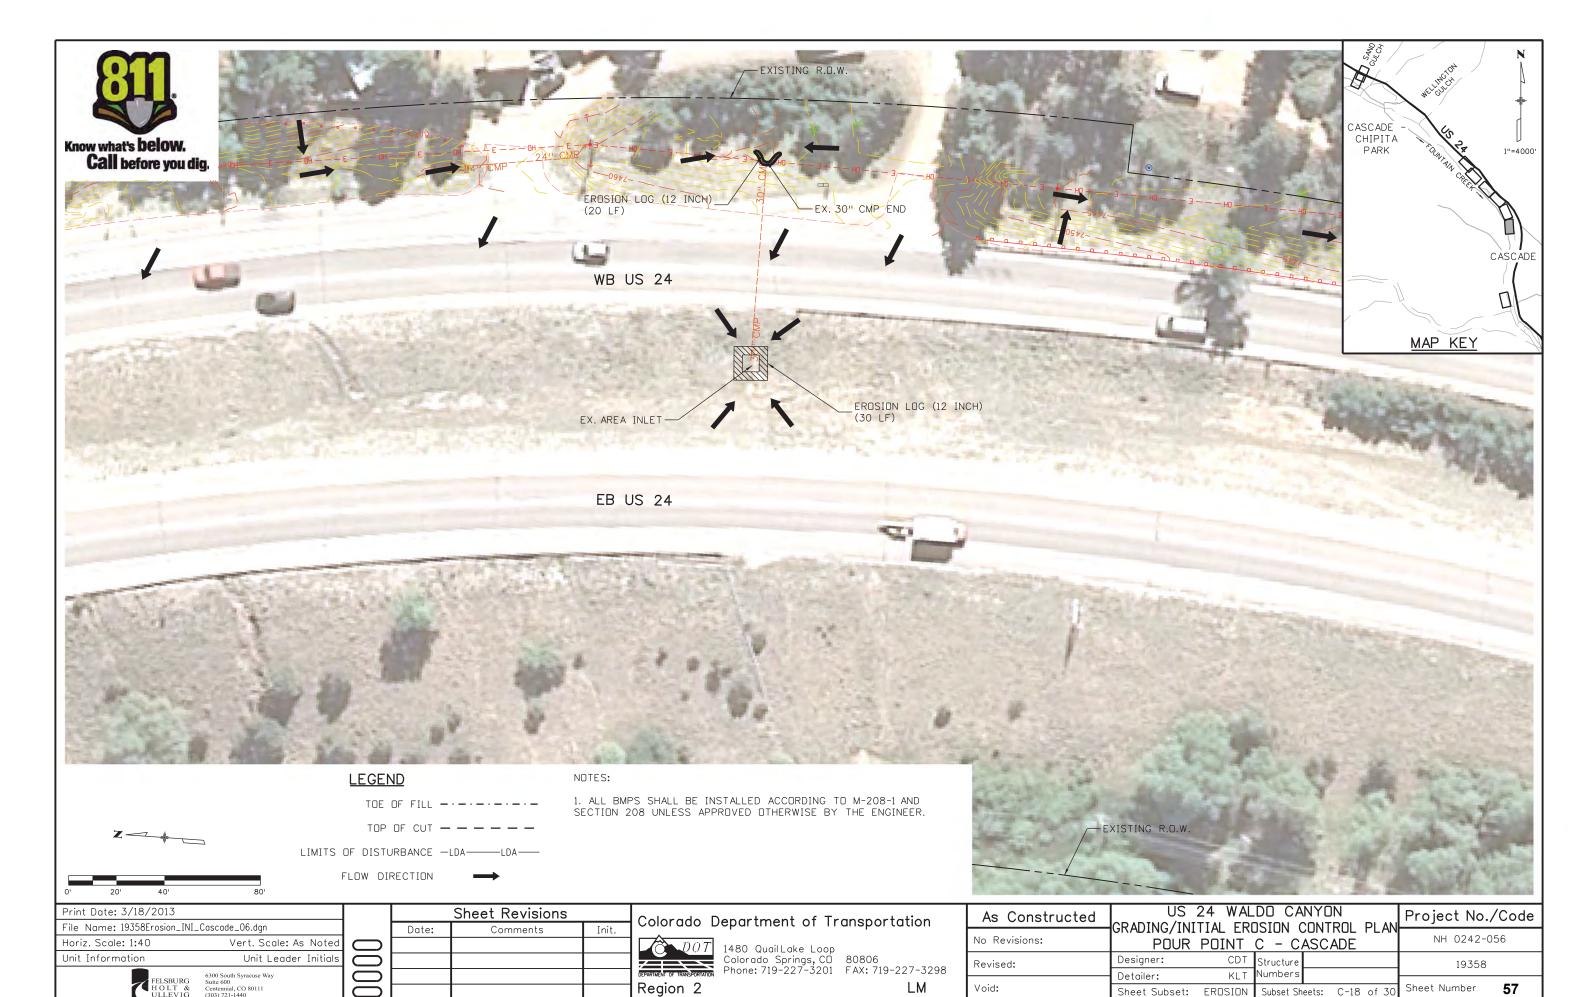


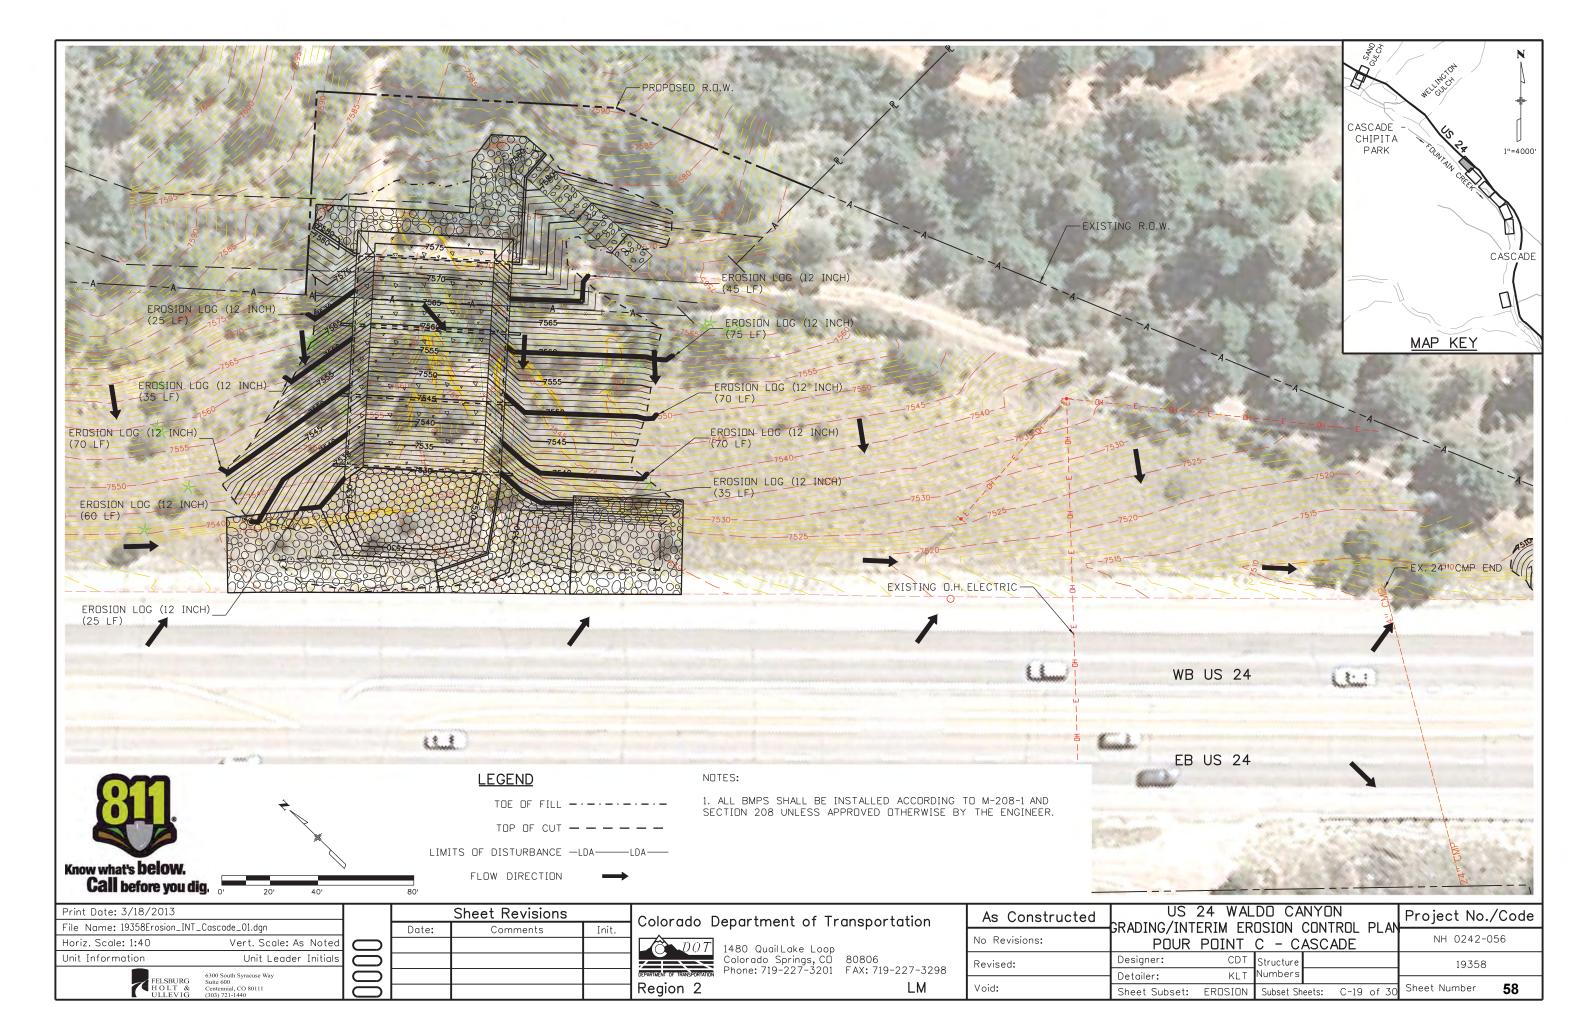


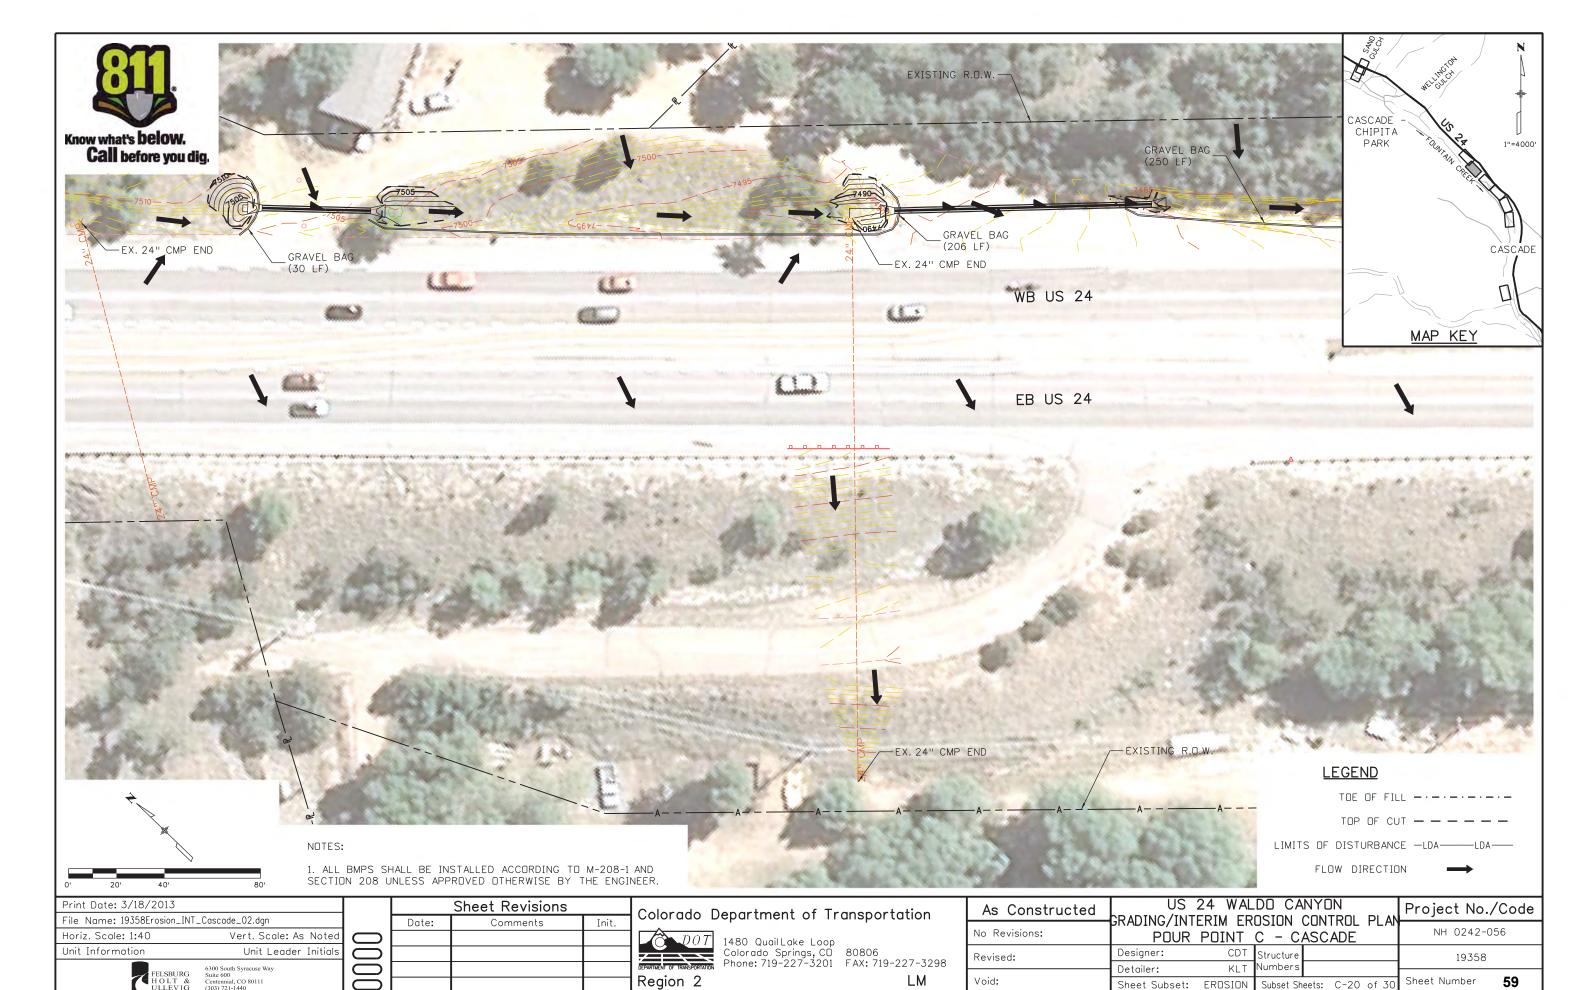


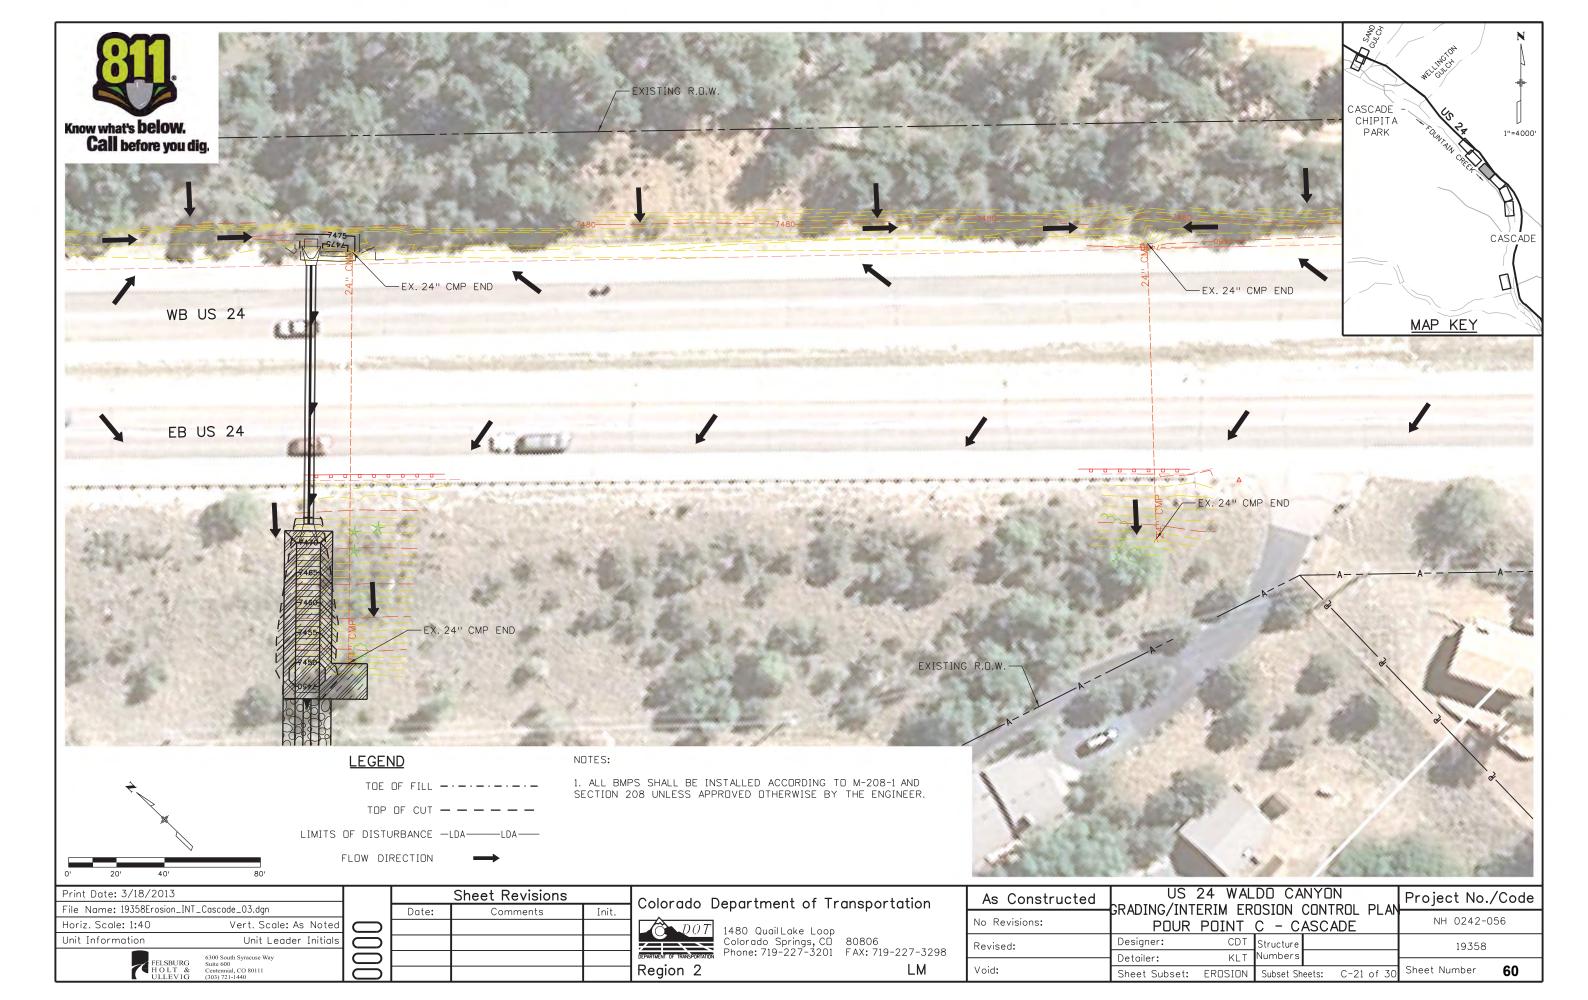


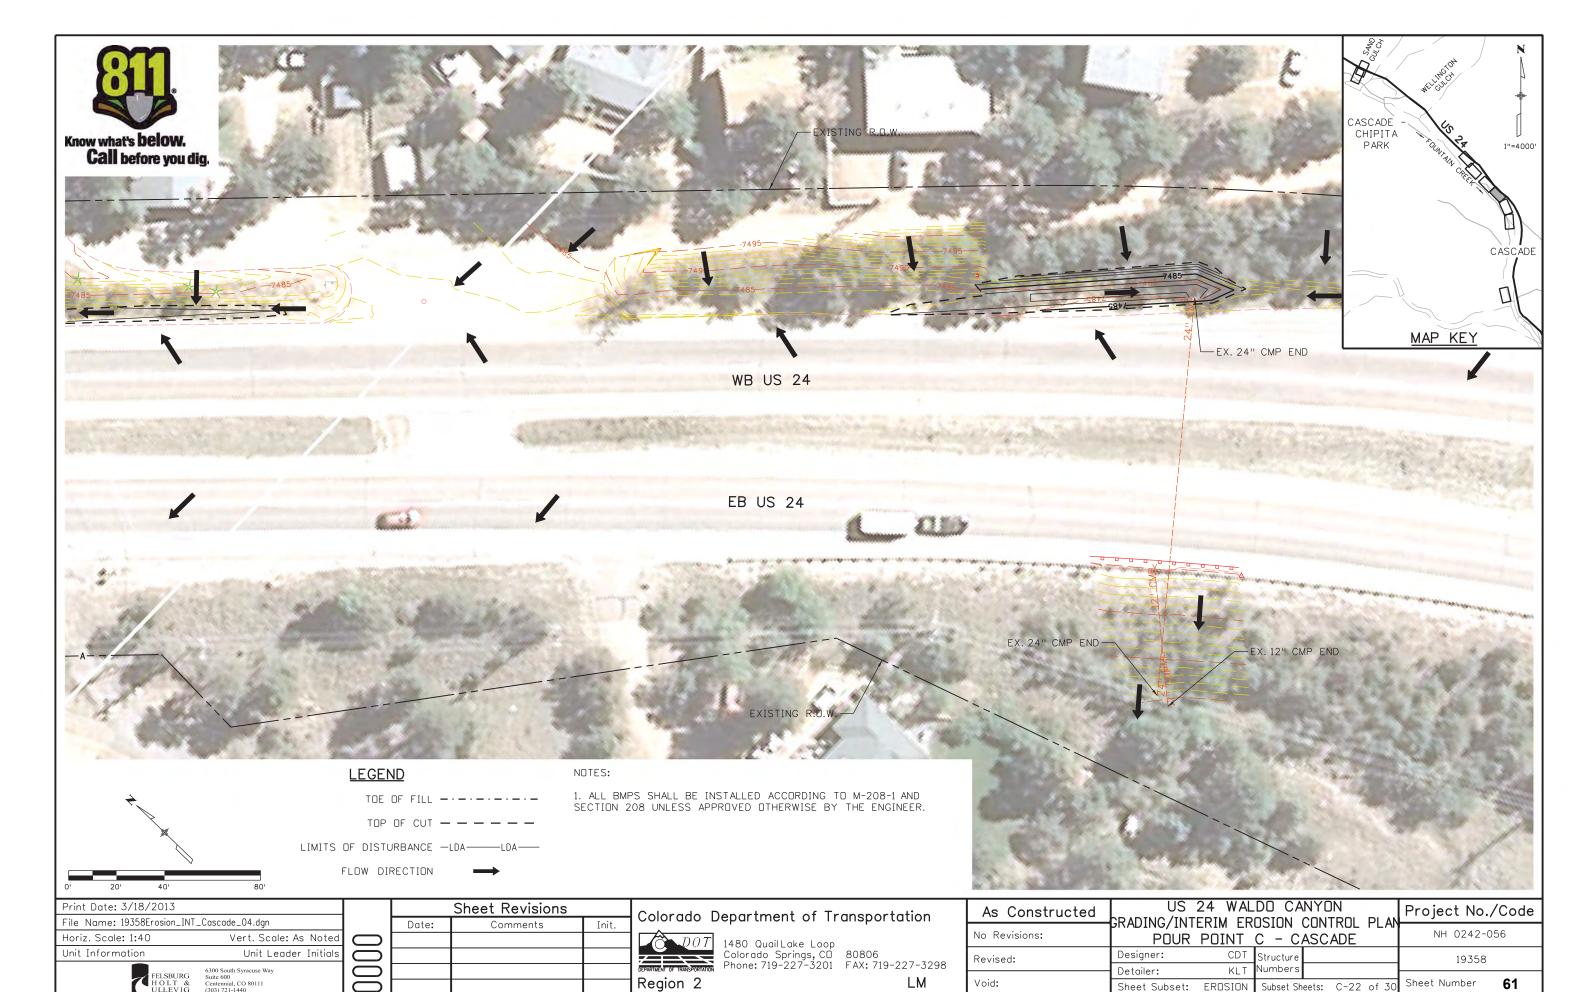


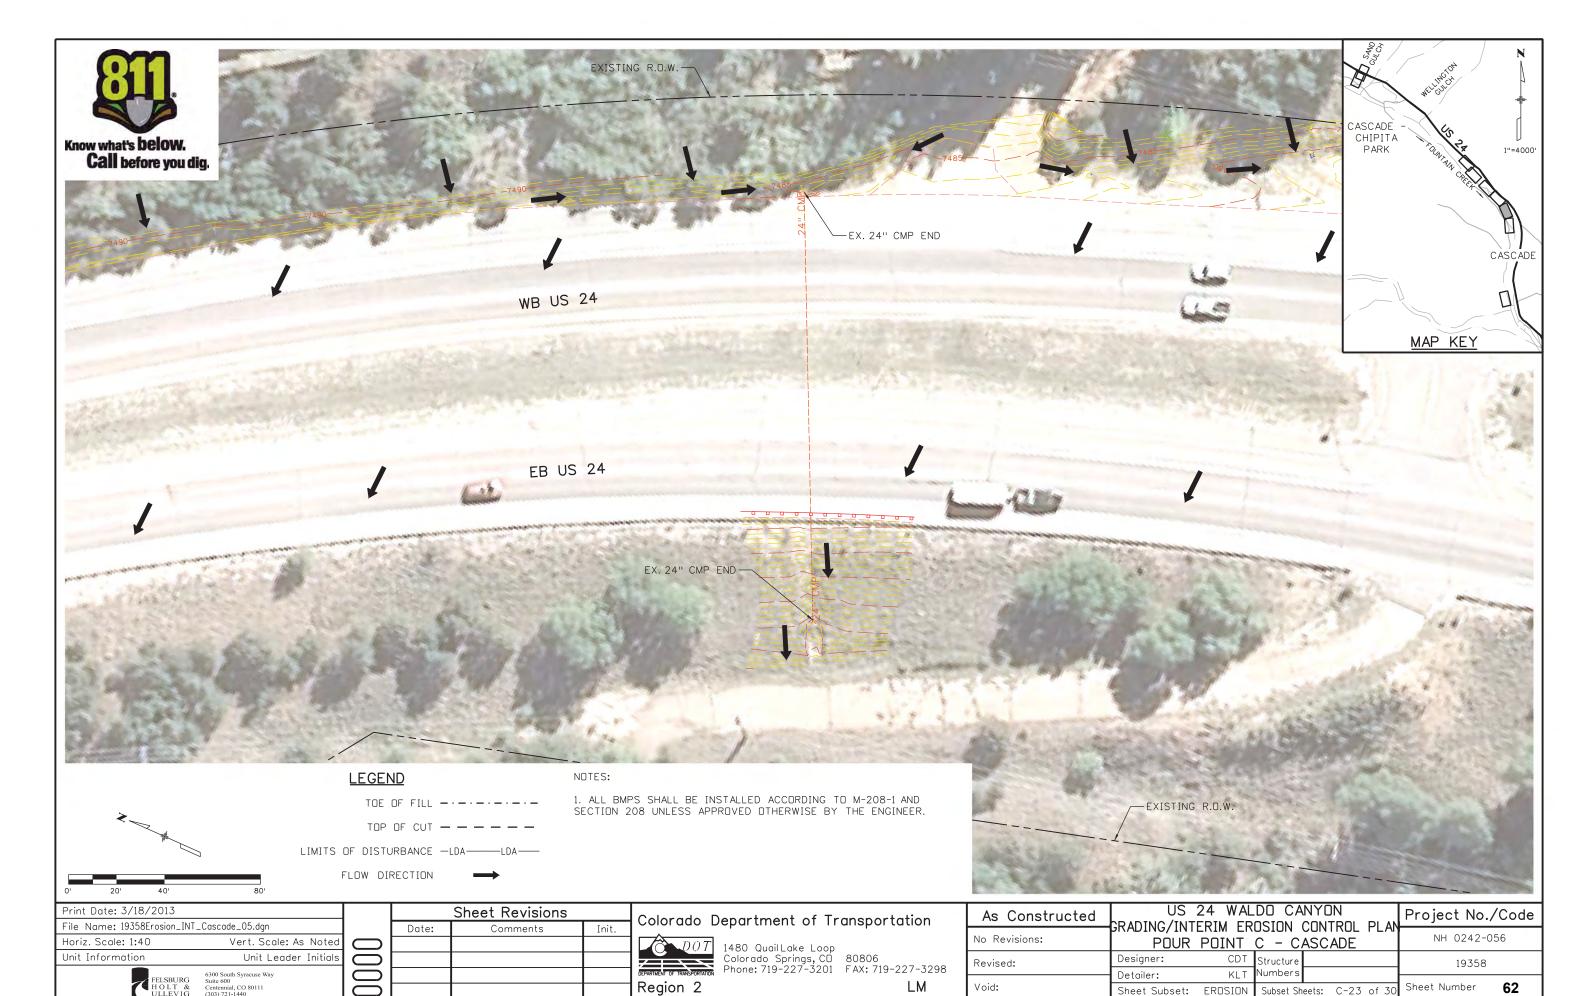


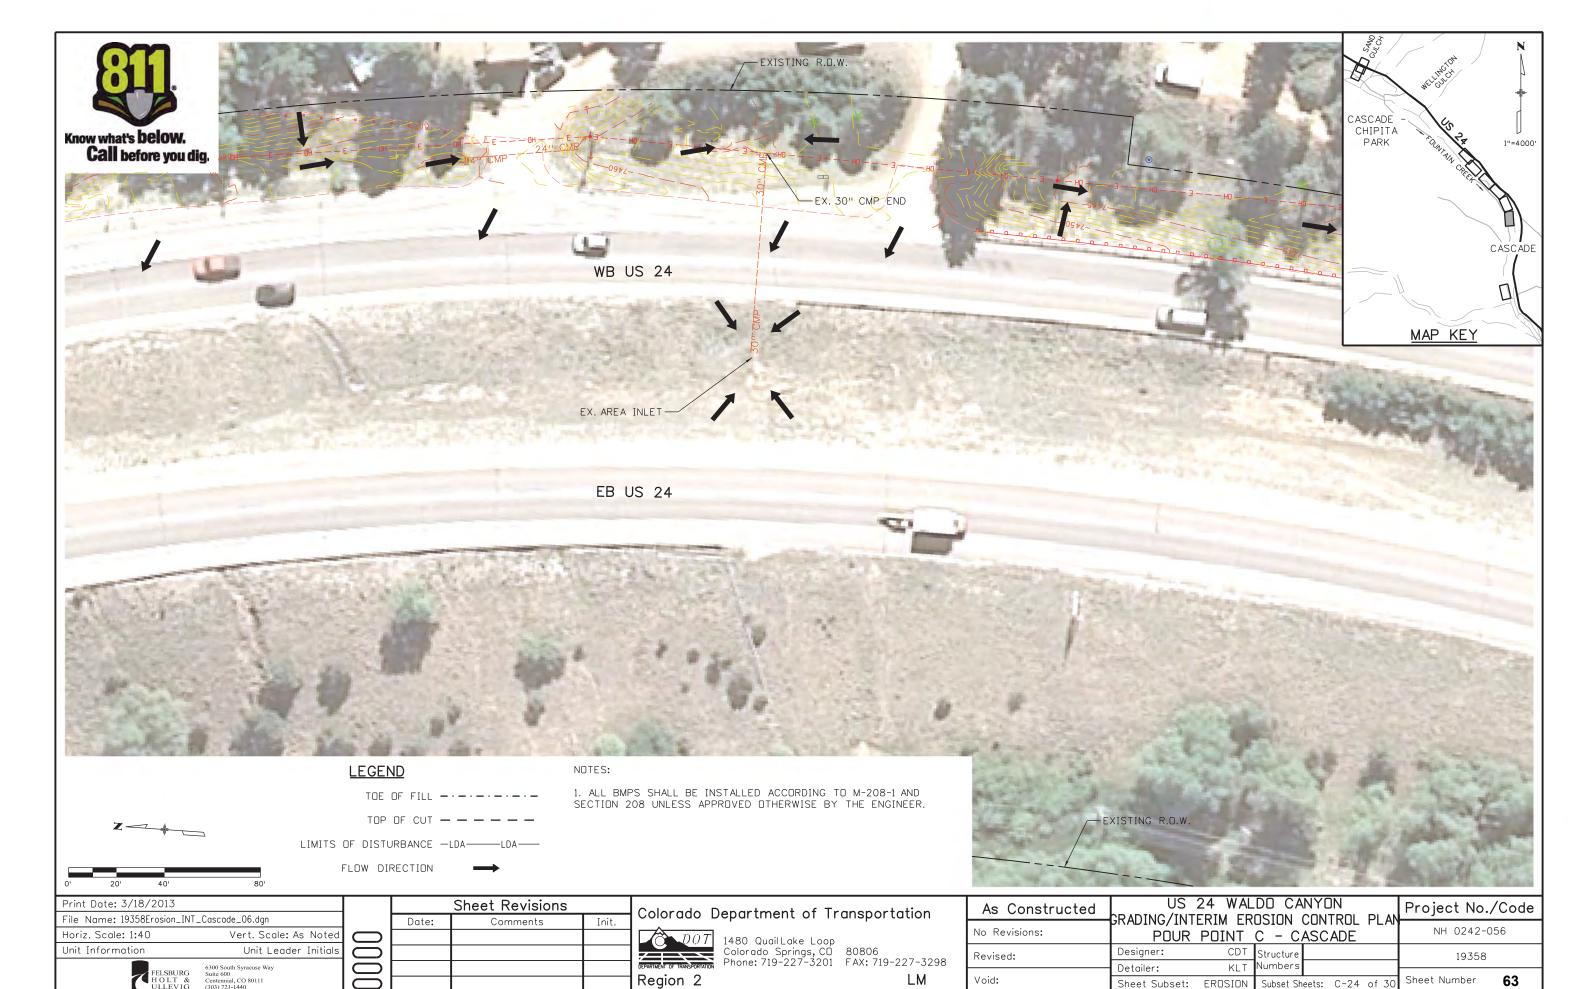


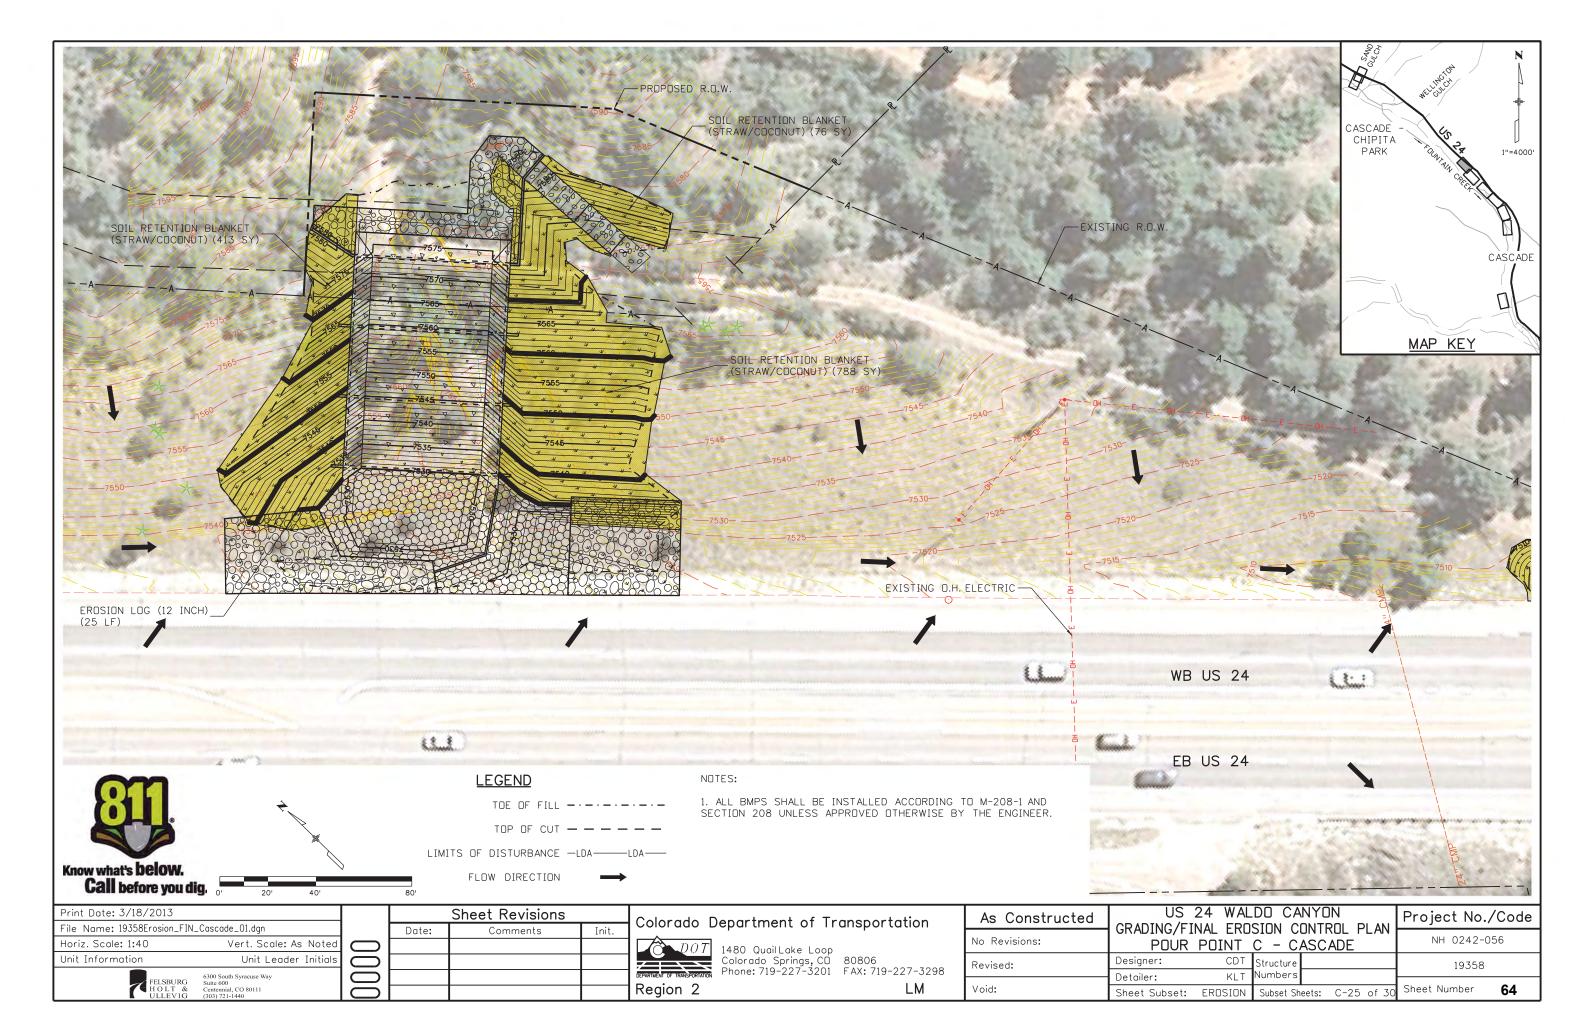


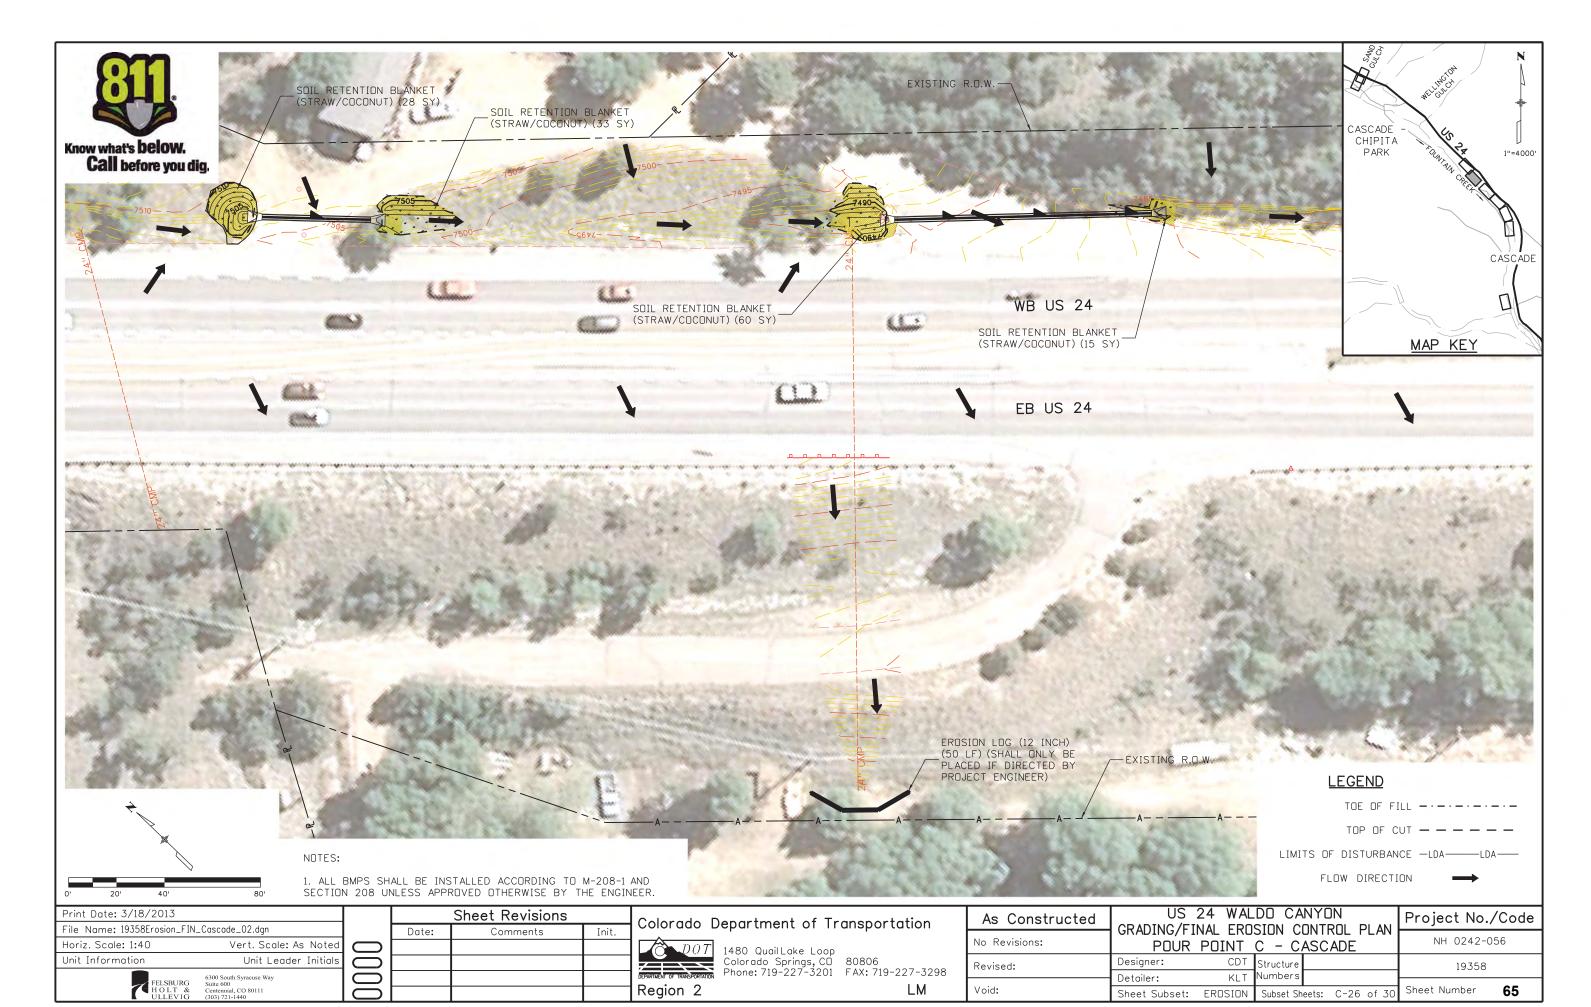

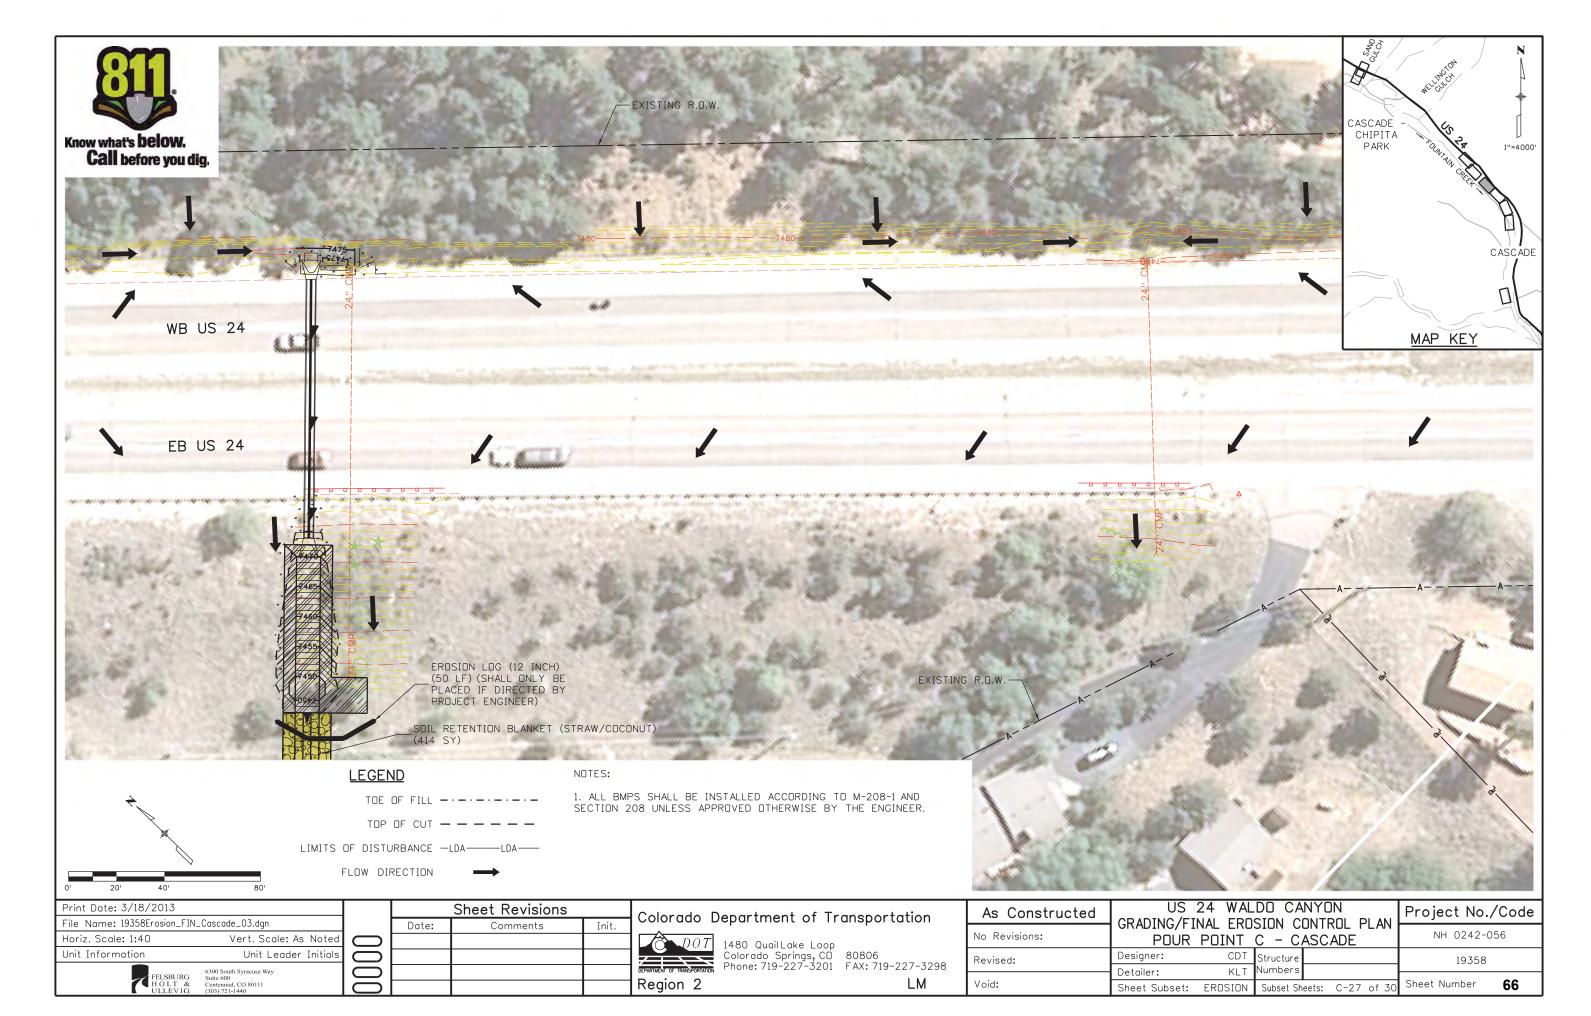

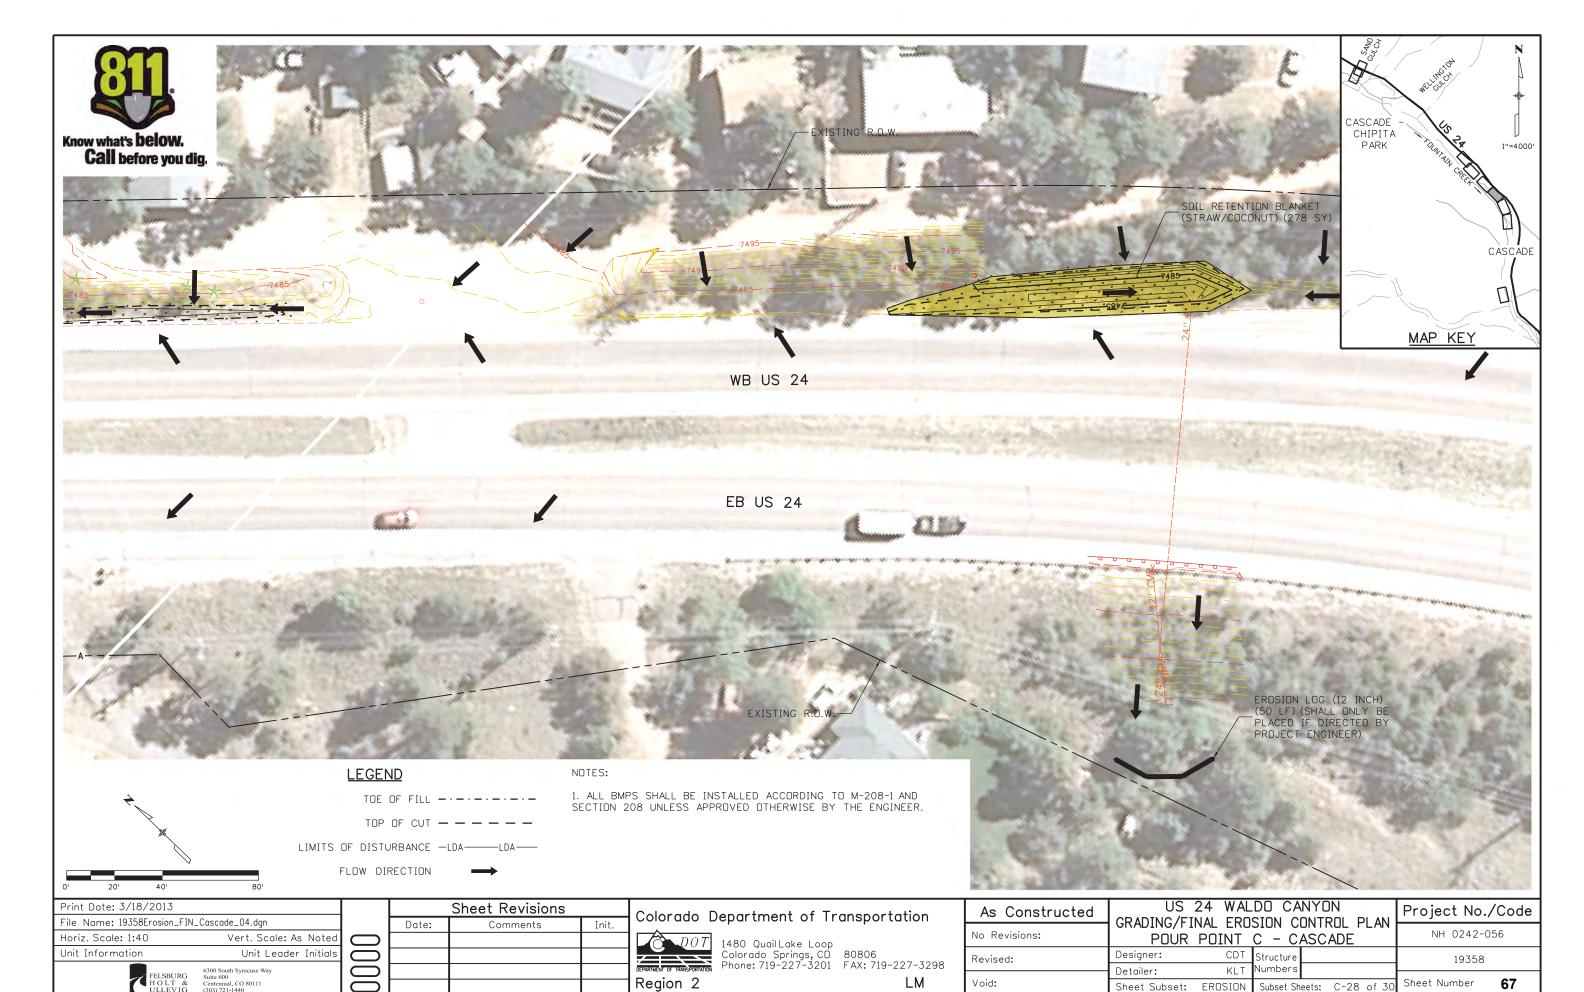

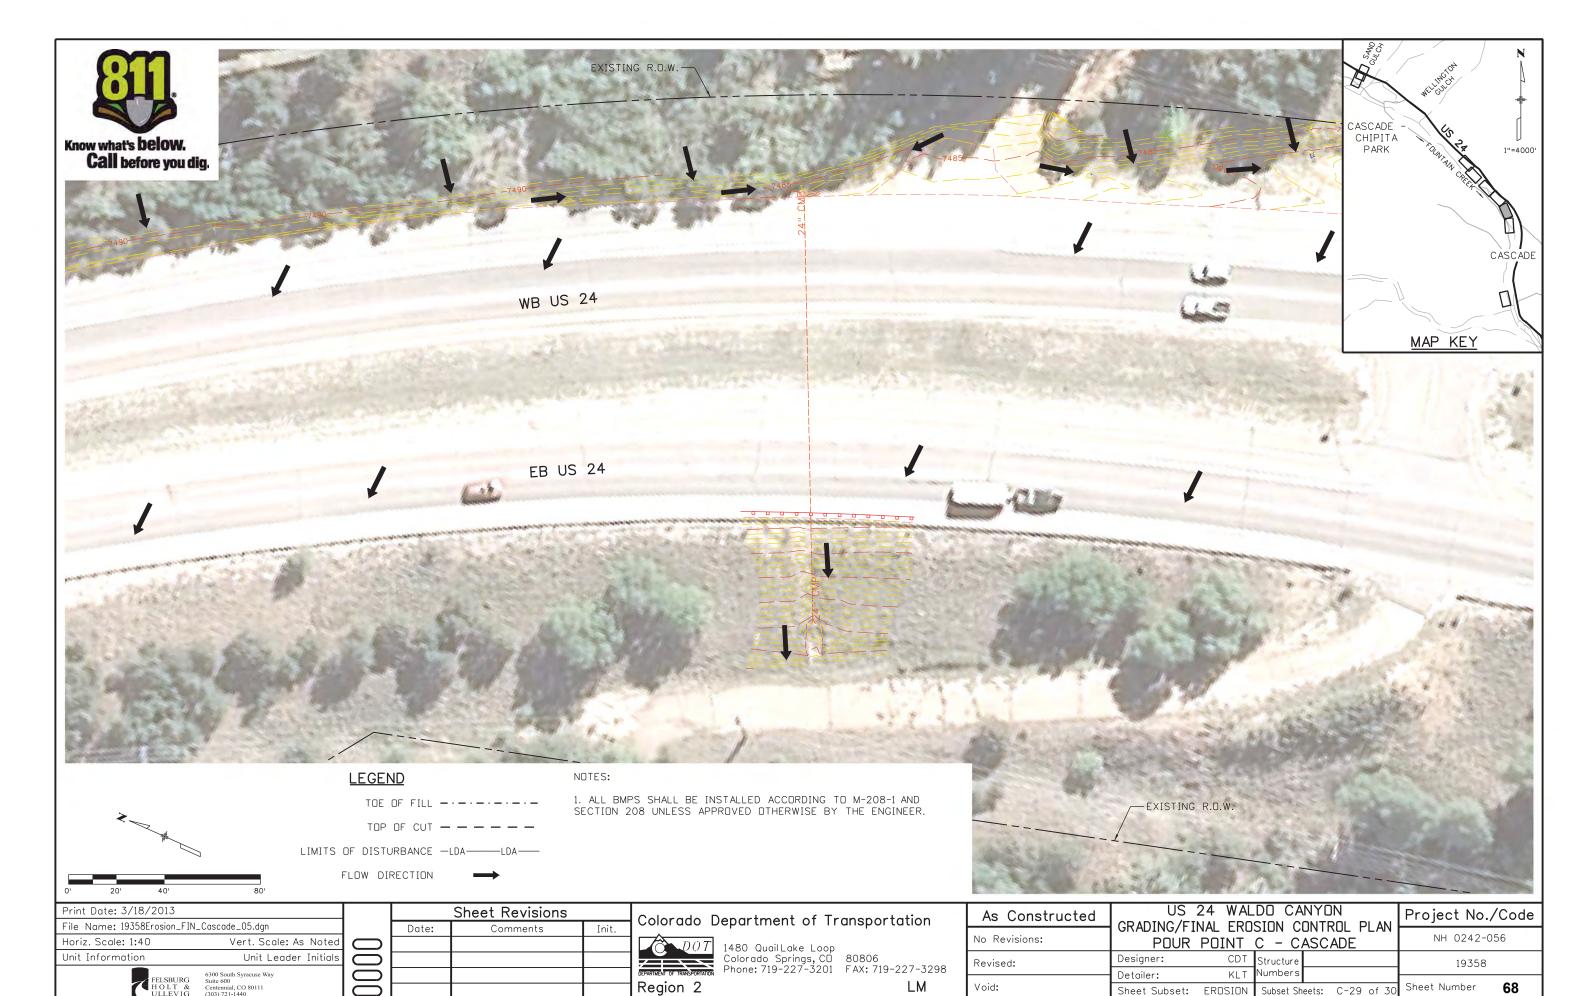

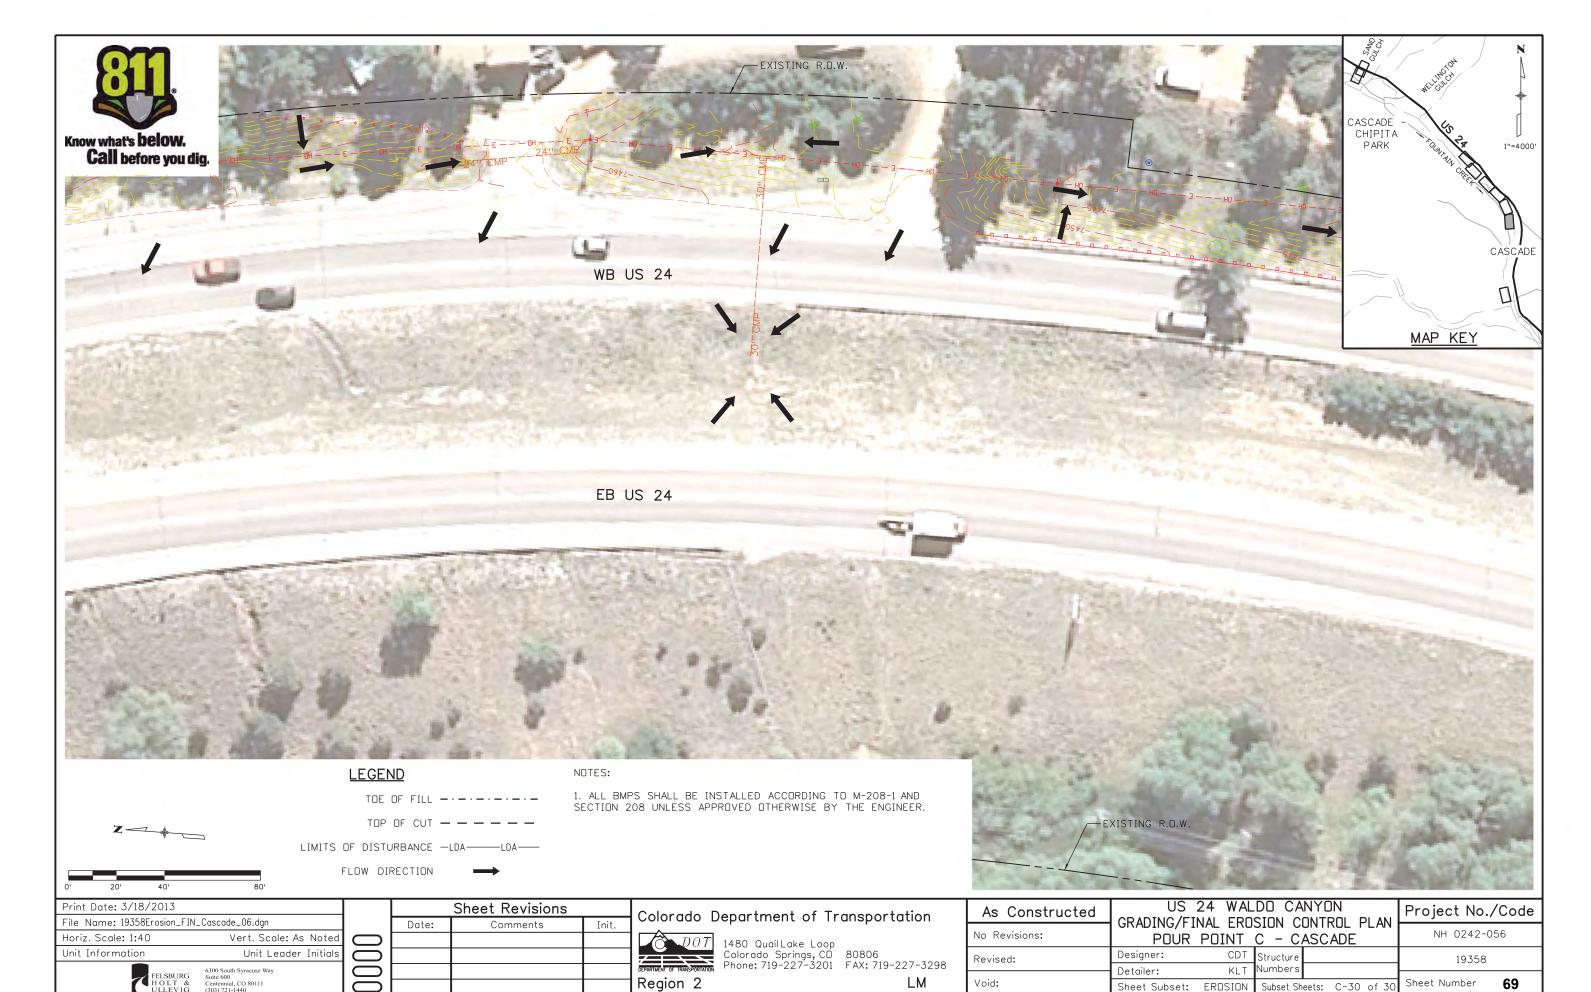

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POUR POINT H TABULATION

CONTRACT ITEM NO.	CONTRACT ITEM	UNIT	QUANTITY
201-00001	CLEARING AND GRUBBING	LS	1
202-00035	REMOVAL OF PIPE	LF	4
202-04002	CLEAN CULVERT	EA	1
203-01622	SWEEPING (WITH PICKUP BROOM)	HR	40
208-00034	GRAVEL BAG	LF	150
208-00045 CONCRETE WASHOUT STRUCTURE		EA	1
208-00070 VEHICLE TRACKING PAD		EA	1
208-00103 REMOVAL AND DISPOSAL OF SEDIMENT (LABOR)		HR	80
208-00105 REMOVAL AND DISPOSAL OF SEDIMENT (EQUIPMENT)		HR	40
208-00205	EROSION CONTROL SUPERVISOR	DAY	30
210-02900	210-02900 RELAY RIPRAP		15
601-01000	CONCRETE CLASS B	CY	15
601-03050	CONCRETE CLASS D (WALL)	CY	13
602-00000	REINFORCING STEEL	LB	750


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File Name: 19358HYDR_Tabs_Earthwork_WaldoCyn.dgn			Date:	Comments	Init.
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Unit Information	Unit Leader Initials				
FELSBURG HOLT & HULLEVIG	6300 South Syracuse Way Suite 600 Centennial, CO 80111)0			

Colorado	Department of Transportation
DOT	1480 QuailLake Loop

Region 2


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O Quail Lake Loop rado Springs, CD ne: 719-227-3201	80806 FAX: 719-227-3298


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No Revisions:	POUR POINT H - WALDO CANYON			NH 0242-056			
Revised:	Designer:		Structure			19358	
	Detailer:	KLT	Numbers				
Void:	Sheet Subset:	TAB	Subset She	eets:	H-1 of 6	Sheet Number	70

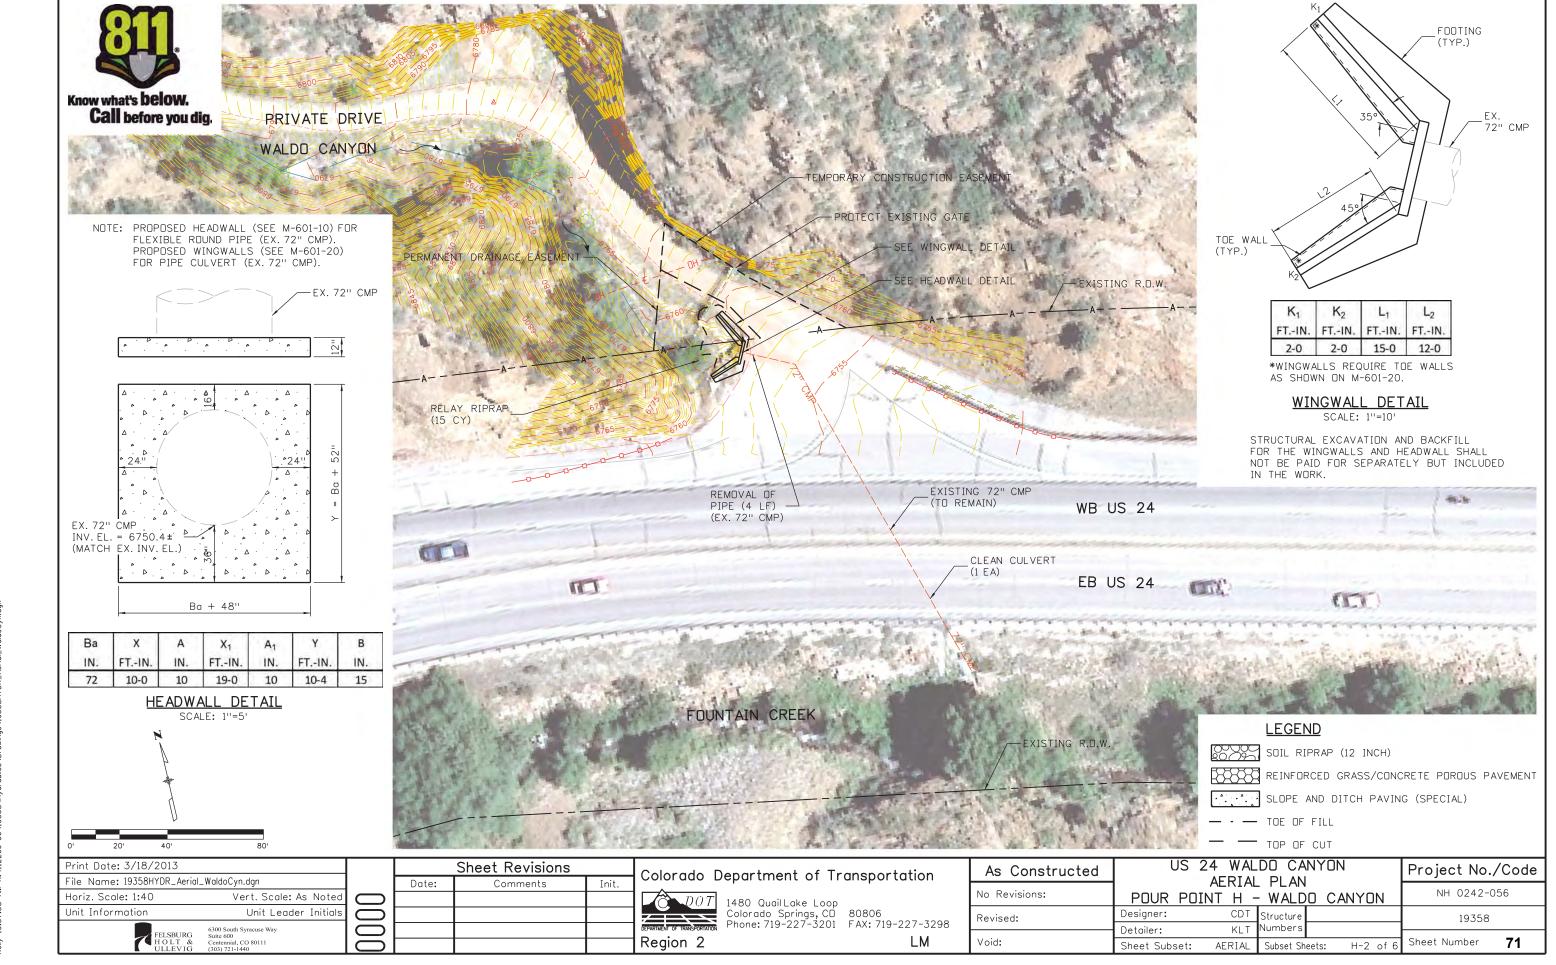

POINT DATA TABLE - POUR POINT H - GRADING

POINT	NORTHING	EASTING	ELEVATION	DESCRIPTION
G1	381076.80	162767.89	6761.00	FINISHED GRADE
G2	381077.67	162770.42	6761.00	FINISHED GRADE
G3	381074.58	162777.68	6760.00	FINISHED GRADE
G4	381076.06	162775.87	6760.00	FINISHED GRADE
G5	381076.45	162773.00	6760.00	FINISHED GRADE
G6	381074.39	162767.04	6760.00	FINISHED GRADE
G7	381066.52	162768.74	6756.00	FINISHED GRADE
G8	381059.16	162764.20	6755.00	FINISHED GRADE
G9	381063.58	162766.35	6755.00	FINISHED GRADE
G10	381067.66	162778.20	6755.00	FINISHED GRADE
G11	381058.59	162767.26	6754.00	FINISHED GRADE
G12	381062.42	162769.12	6754.00	FINISHED GRADE
G13	381058.94	162777.44	6751.00	FINISHED GRADE
G14	381060.56	162782.13	6751.00	FINISHED GRADE
G15	381057.50	162776.74	6751.00	FINISHED GRADE
G16	381052.81	162778.36	6751.00	FINISHED GRADE
G17	381056.32	162770.80	6754.00	FINISHED GRADE
G18	381051.53	162768.22	6756.00	FINISHED GRADE
G19	381049.55	162768.90	6756.00	FINISHED GRADE

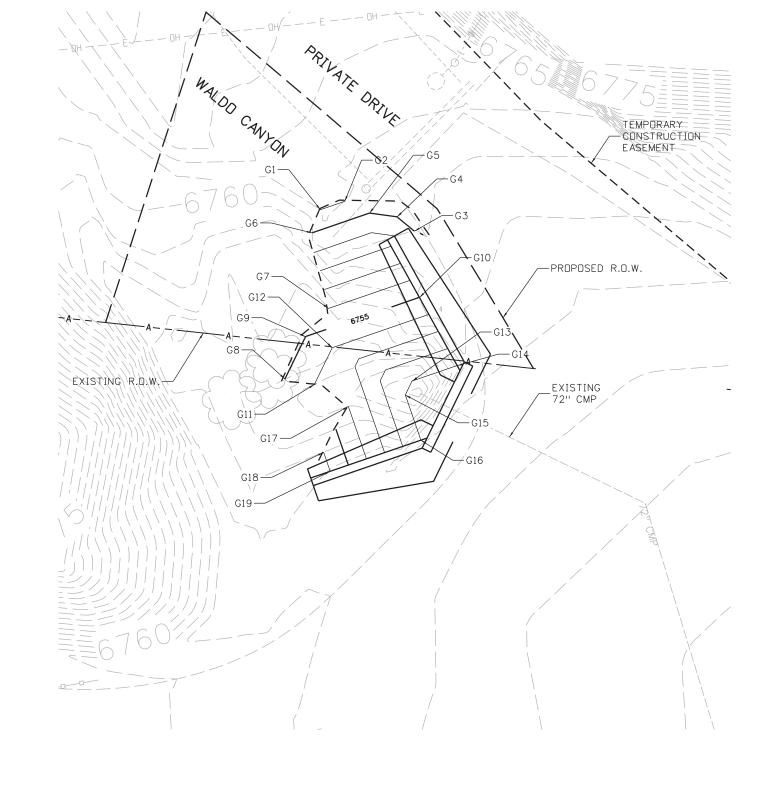

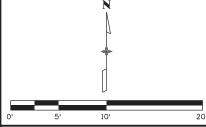



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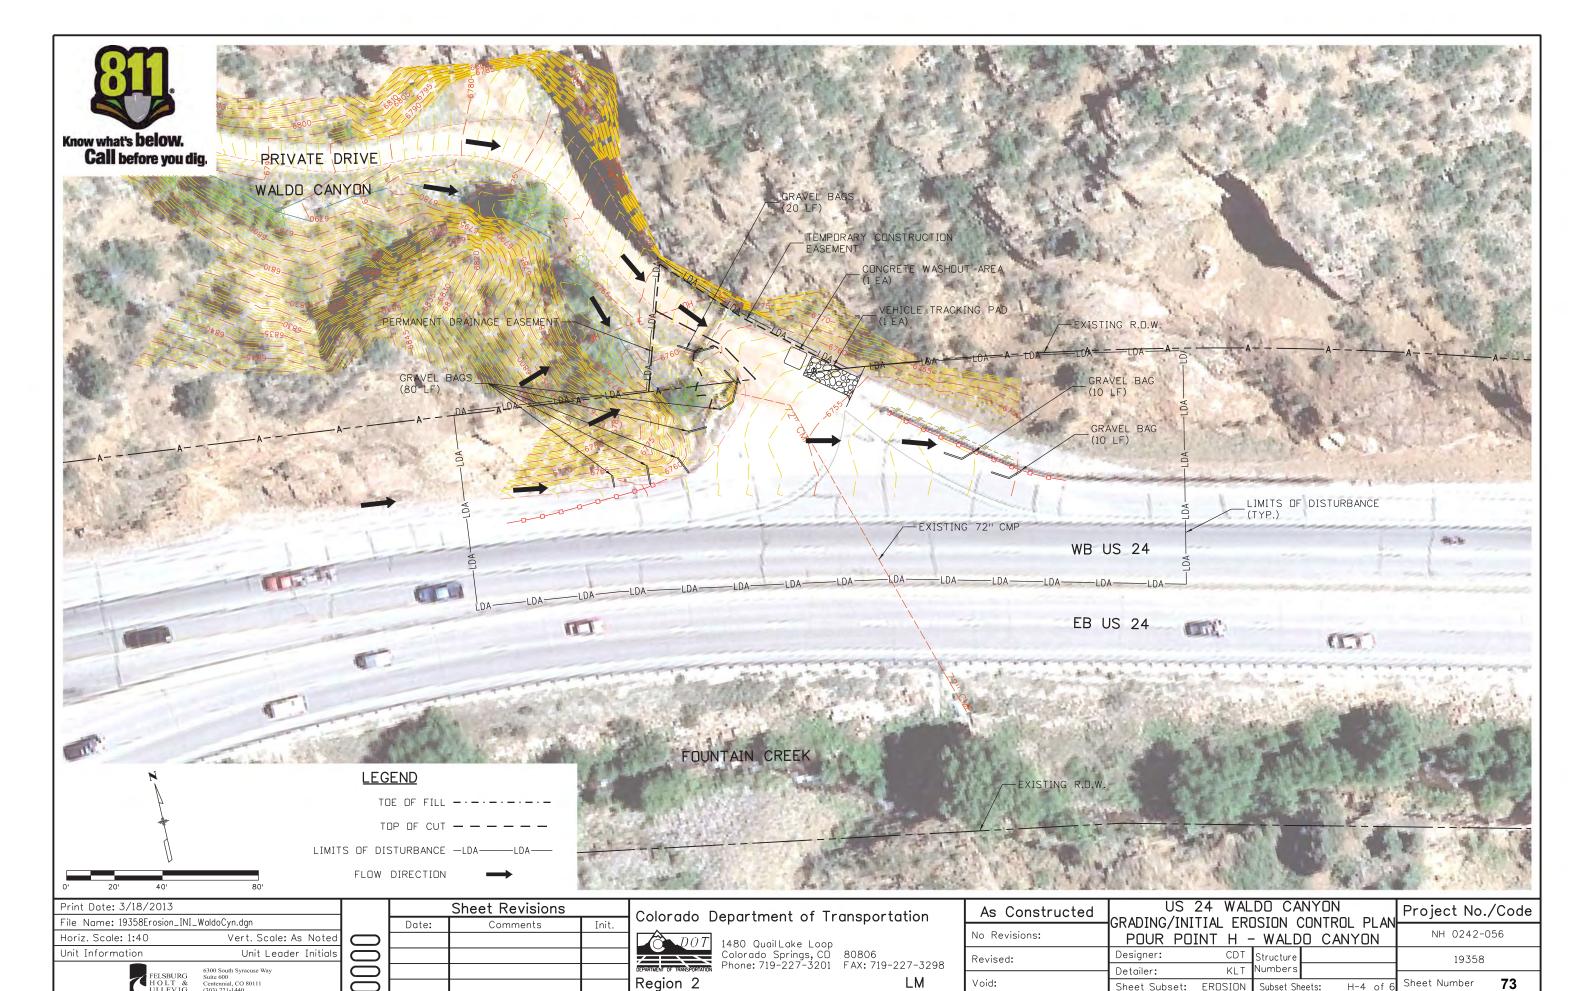
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Unit Information Unit Leader Initials	
FELSBURG 6300 South Syracuse Way Suite 600	
HOLT & Centennial, CO 80111 ULLEVIG (303) 721-1440	


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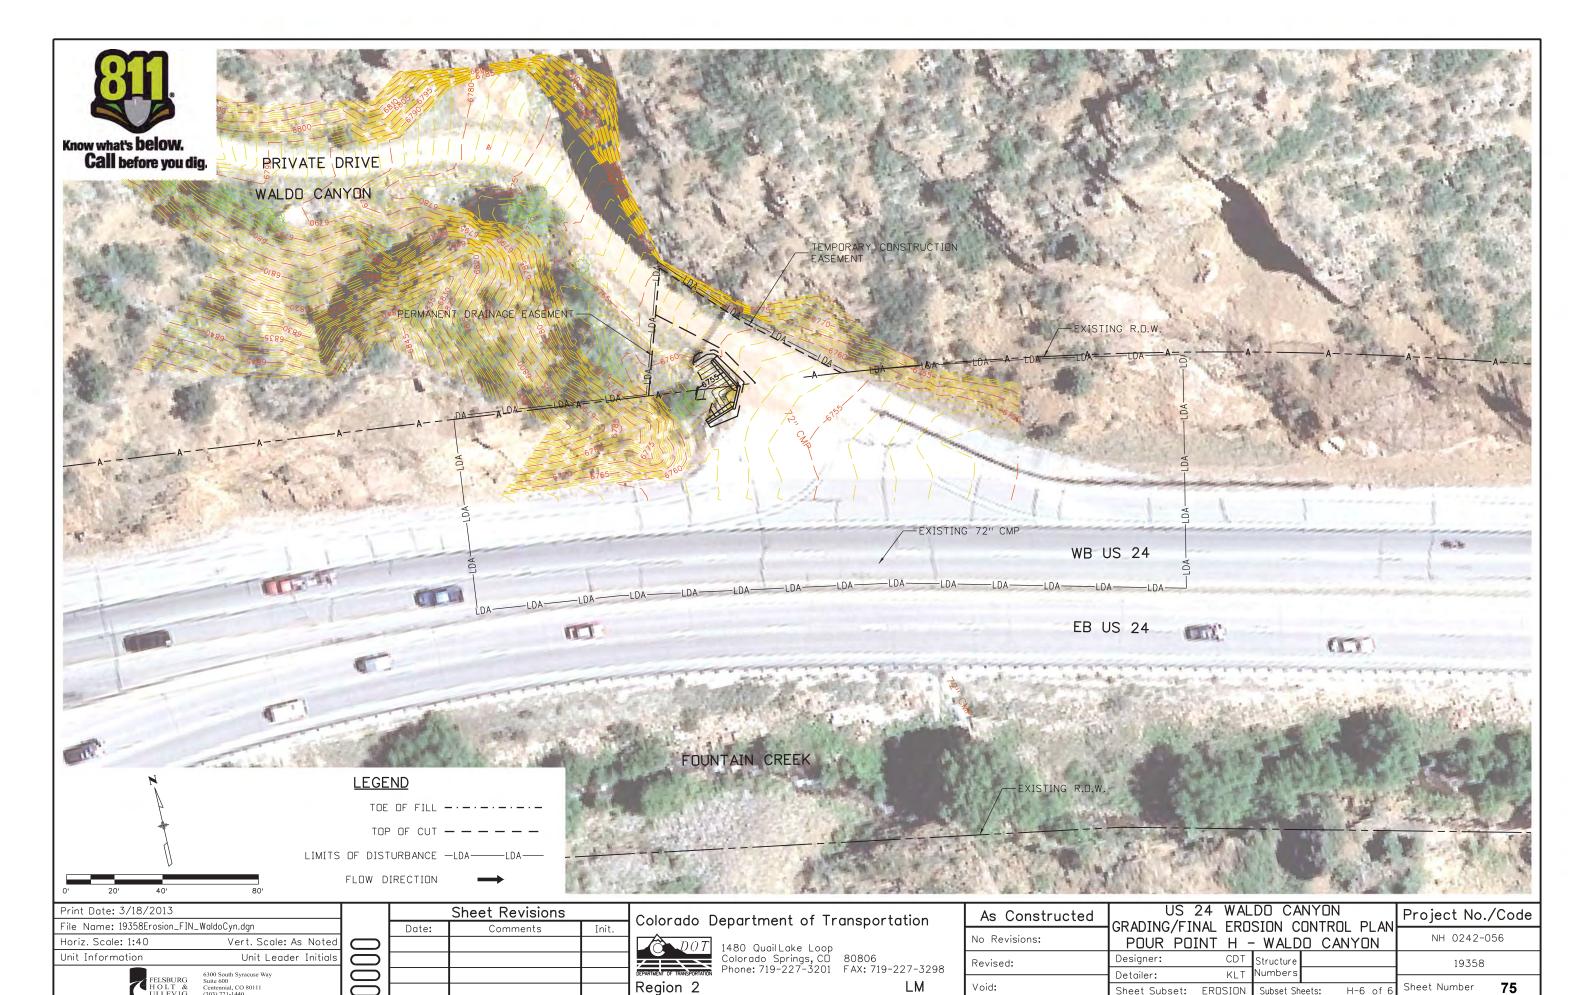
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POUR POINT J - TABULATION

CONTRACT ITEM NO.	CONTRACTITEM	UNIT	QUANTIT
201-00001	CLEARING AND GRUBBING	LS	1
202-00027	REMOVAL OF RIPRAP	SY	86
203-00010	UNCLASSIFIED EXCAVATION (COMPLETE IN PLACE)	CY	12916
203-00060	EMBANKMENT MATERIAL (COMPLETE IN PLACEO	CY	450
203-00598	ROCK SCALING	HR	60
203-01622	SWEEPING (WITH PICKUP BROOM)	HR	40
206-00000	STRUCTURE EXCAVATION	CY	450
206-00510	FILTER MATERIAL (CLASS A)	CY	200
207-00205	TOPSOIL	CY	202
208-00002	EROSION LOG (12 INCH)	LF	455
208-00034	GRAVEL BAG	LF	490
208-00041	ROCK CHECK DAM	FA	1
208-00045	CONCRETE WASHOUT STRUCTURE	EA	2
208-00070	VEHICLE TRACKING PAD	EA	2
208-00103	REMOVAL AND DISPOSAL OF SEDIMENT (LABOR)	HR	80
208-00105	REMOVAL AND DISPOSAL OF SEDIMENT (EQUIPMENT)	HR	40
208-00205	EROSION CONTROL SUPERVISOR	DAY	30
208-00301	TEMPORARY DIVERSION	LF	300
210-00475	RESET CLOSED CIRCUIT TELEVISION POLE	EA	1
210-00810	RESET GROUND SIGN	EA	1
212-00006	SEEDING (NATIVE)	AC	0.25
212-00032	SOIL CONDITIONING	AC	0.25
213-00002	MULCHING (WEED FREE)	AC	0.25
216-00041	SOIL RETENTION BLANKET (STRAW/COCONUT)	SY	563
304-06000	AGGREGATE BASE COURSE (CLASS 6)	CY	79
420-00102	GEOTEXTILE (EROSION CONTROL) (CLASS 1)	SY	540
504-06315	GROUND NAIL (15 FOOT)	EA	60
506-00010	RIPRAP (SPECIAL)	CY	35
506-00036	GROUTED RIPRAP (36 INCH) (SPECIAL)	CY	275
506-00218	RIPRAP (18 INCH)	CY	275
506-00412	SOIL RIPRAP (12 INCH)	CY	81
506-01020	GEOGRID REINFORCEMENT	SY	856
607-53172	FENCE CHAIN LINK (72 INCH)	LF	174
607-55100	WIRE MESH	SF	52330
609-21020	CURB AND GUTTER TYPE 2 (SECTION II-B)	LF	390
641-10000	SHOTCRETE	SY	139

INDEX				DDO (FOT TOTAL O	
воок	PAGE	SHEET	ITEM	PROJECT TOTALS	
			*EMBANKMENT MATERIAL (CIP) (FROM CROSS-SECTIONS) (FOR INFO ONLY) ACCESS ROAD STA. 0+00.00 TO STA. 04+46.03	CU. YDS.	
			SUBTOTAL	226	
			TOTAL	226	
			*UNCLASSIFIED EXCAVATION (FROM CROSS-SECTIONS) ACCESS ROAD STA. 0+00.00 TO STA. 04+46.03	CU. YDS.	
			SUBTOTAL	162	
			TOTAL FOR PAY QUANTITY	162	

COMPACTION (FOR INFORMATION ONLY) (MOISTURE & DENSITY CONTROL) EMBANKMENT (NET)	226
TOTAL	226
WETTING QUANTITIES (FOR INFORMATION ONLY) COMPACTION	M. GAL.
(226 x 0.040 M, GAL./yd) TOTAL	9
ACCESS ROAD QUANTITIES BALANCE (FOR INFORMATION ONLY)	CU. YDS;
EMBANKMENT (NET)	226
EMBANKMENT X FACTOR (1.15)	260
BALANCE TOTAL	260
UNCLASSIFIED EXCAVATION TO BE IMPORTED BY THE CONTRACTOR BALANCE TOTAL	162 98 260


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Unit Information	Unit Leader Initials	(
FELSBURG HOLT & ULLEVIG	6300 South Syracuse Way Suite 600 Centennial, CO 80111 (303) 721-1440	(
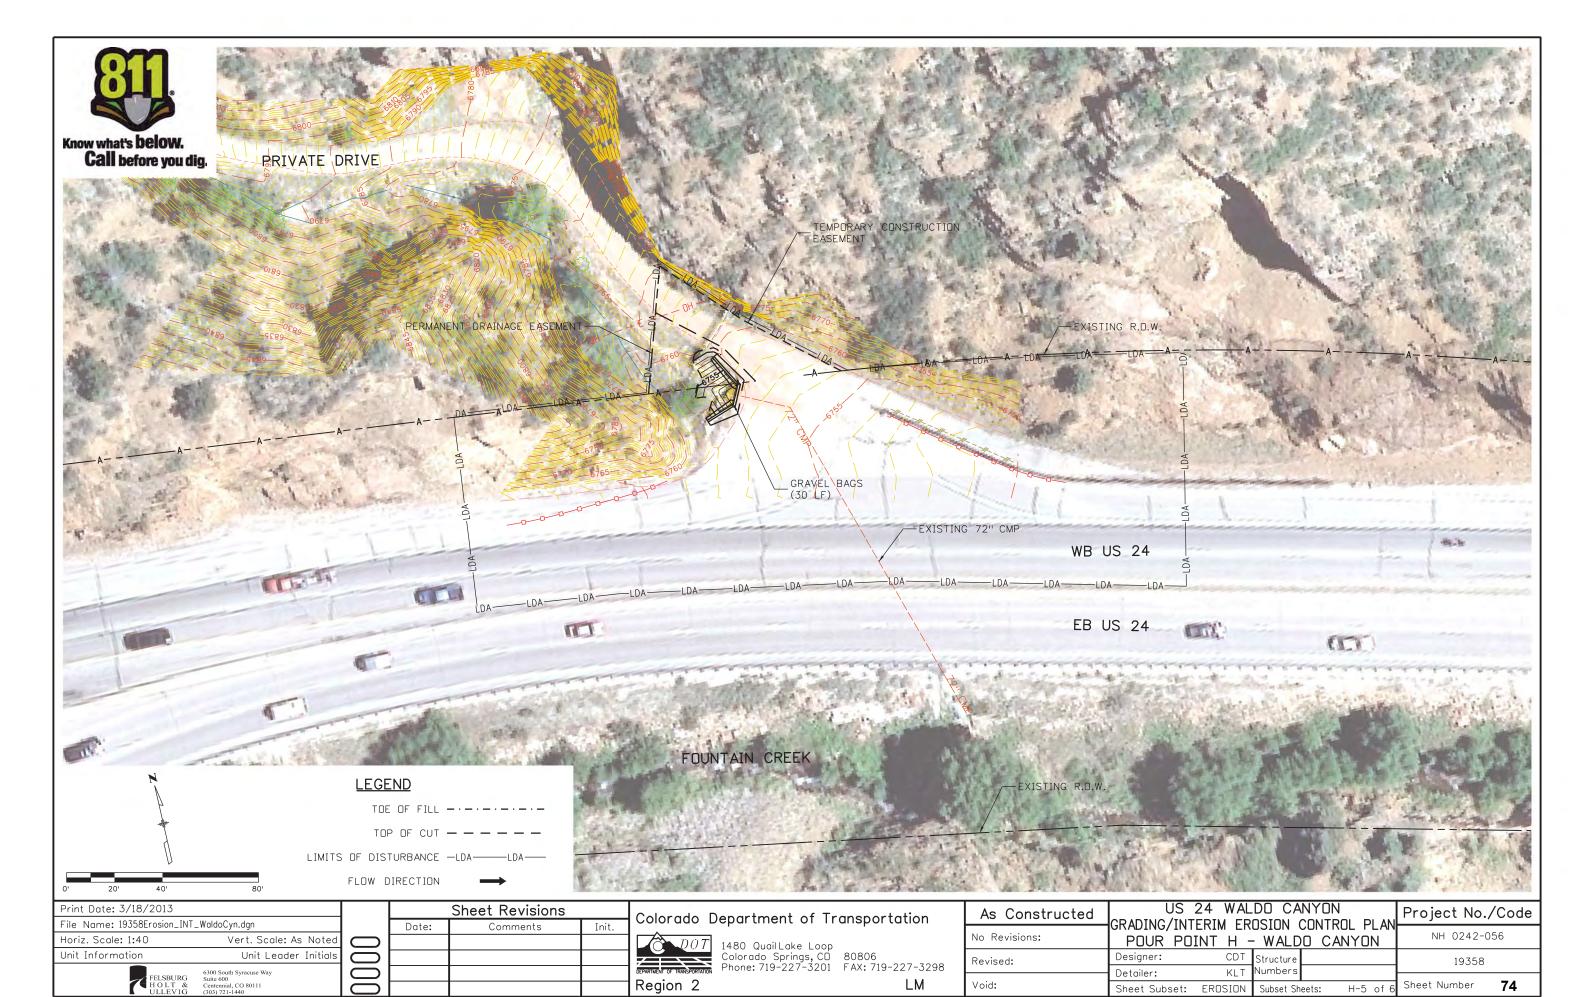
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			DEPARTMENT OF TRANSPORTATION
			Region 2

Colorado D	epartment of Tr	ansportation
DOT	1480 QuailLake Loop Colorado Springs, CO Phone: 719-227-3201	

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As Constructed	TABULATION				Project No./Code		
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	Detailer:	KLT	Numbers				
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P17

C2 1+15.04 378347.3184 N 2°36'18" E 1+28.95 378361.2104 C3 1+32.66 378364.9059 N 6°51'19" E 1+47.70 378379.8446 C4 1+65.53 378397.6298 N 6°45'49" W 1+87.52 378419.4666 C5 1+90.95 378422.8574 N 10°41'44" W 2+09.86 378441.4396 C6 2+38.69 378466.7210 N 43°43'35" W 2+49.94 378474.8555 C7 2+69.29 378485.9345 N 65°53'41" W 2+91.11 378494.8469 C8 378498,7147 3+02,58 N 74°39'30" W 3+22,23 378503.9131 C9 3+24.81 378504.5500 N 76°37'49" W 3+48.88 378510.1174 C10 3+84.74 378523.2698 N 60°11'24" W 378553.7373 4+46.03 0+87.41 1*0₀ -ACCESS ROAD HCL

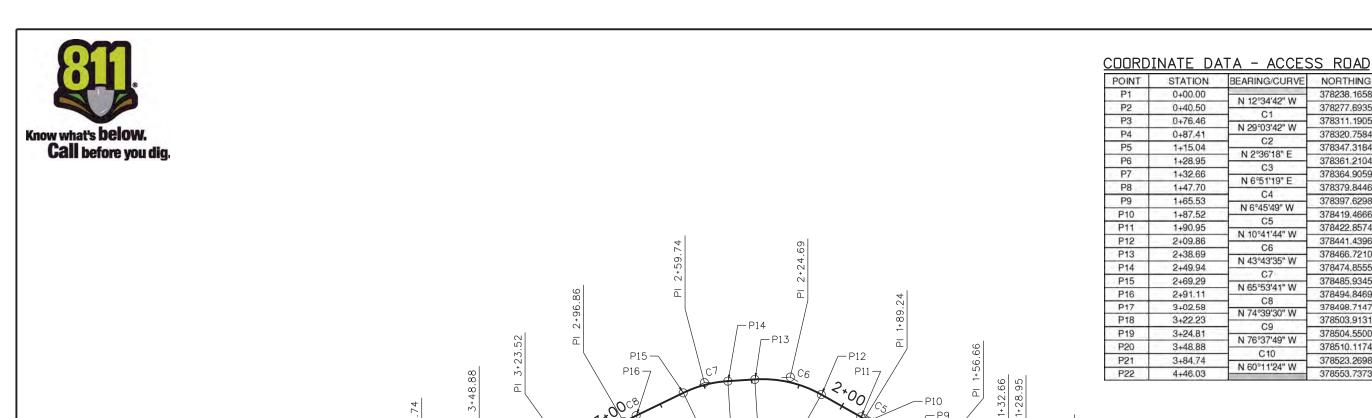∟P2

BEARING/CURVE

N 12°34'42" W

C1

N 29°03'42" W

NORTHING

378238.1658

378277.6935

378311,1905

378320.7584

EASTING

165043.9779

165035.1582

165022.4205

165017.1035

165010.8601

165011.4921

165011.7979

165013.5939

165013.6081

165011.0183

165010.4976

165006.9880

164993.9890

164986.2083

164970.4967

164950.5776

164939,7894

164920.8411

164918.3406

164894,9289

164861.6924

164808.5145

CURVE DATA - ACCESS ROAD CURVE RADIUS LENGTH TANGENT DELTA C1 16°29'00" 125 35.96 18.11 C2 31°40'00" 50 27.63 14.18 C3 4°15'01" 50 3.71 1.86 C4 13°37'08" 75 17.83 8.96 C5 3°55'55" 50 3.43 1.72 C6 33°01'52" 50 28.83 14.83 C7 22°10'05" 50 19.35 9.80 C8 8°45'50" 75 11.47 5.75 C9 1°58'19" 75 2.58 1.29 C10 16°26'25" 125 35.87 18.06

PT 2+38.69 PC 2+09.86

P5-

PI 1+01.59

0+76.46

0+40.50

0'	20'	40'	80'		
Print	Date: 3/1	8/2013			
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ULLEVIG (303) 721-1440				

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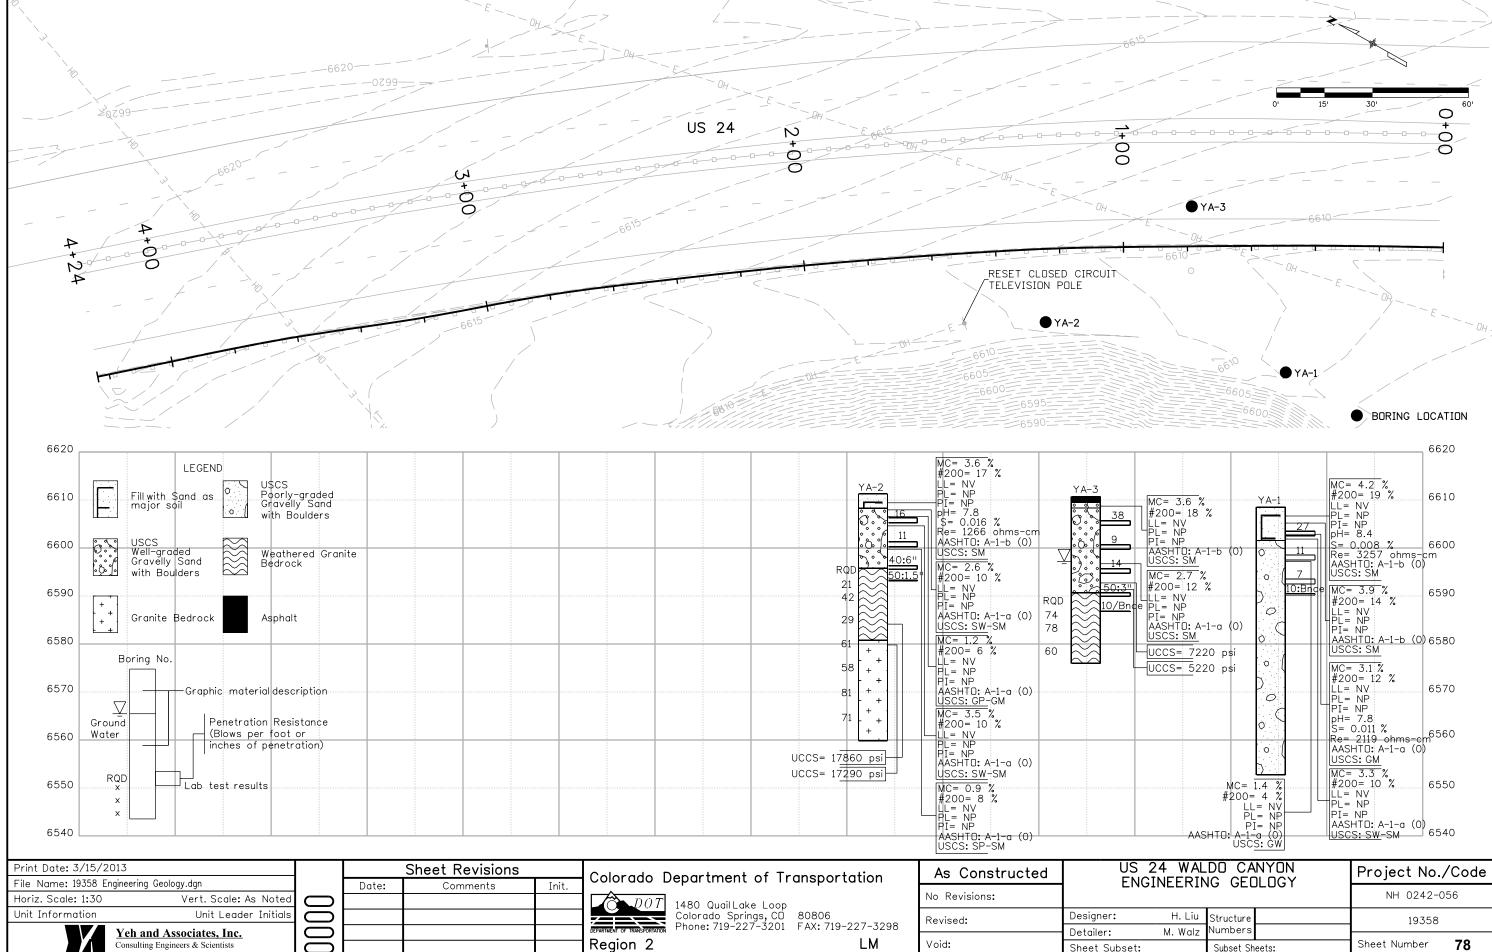
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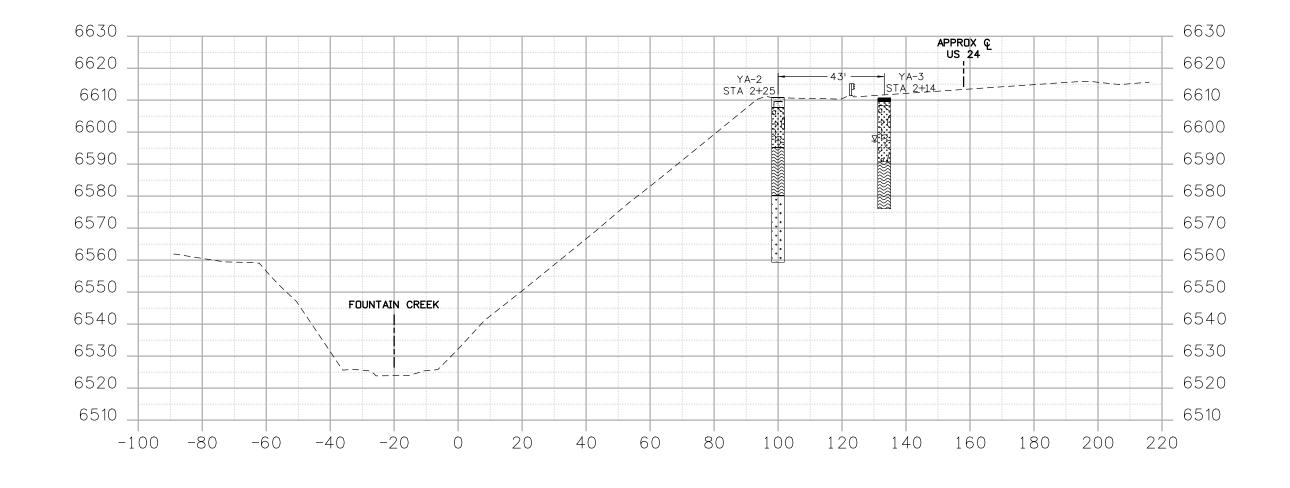
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DO	T 1480 Quaillake Loop	


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DEPARTMENT OF TRANSPORTATION	Pr
Region 2	

480 QuailLake Loop Colorado Springs, CO 80806 Phone: 719-227-3201 FAX: 719-227-3298 LM

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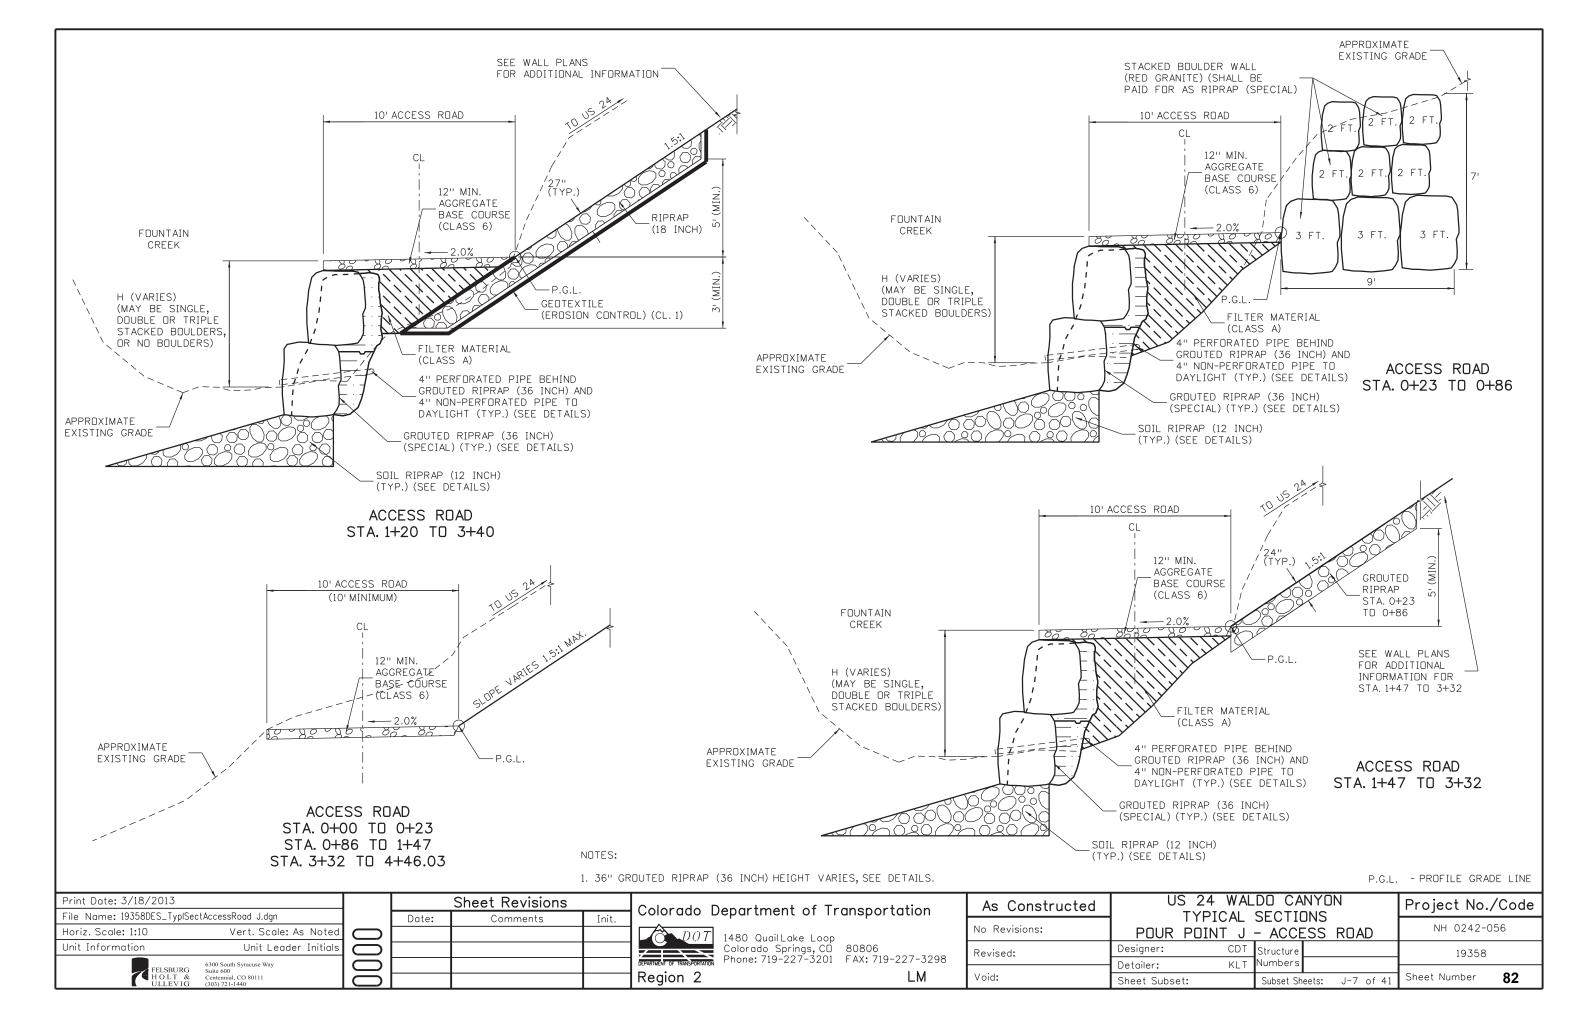






NOTE: SEE GRADING AND SECTION DETAIL
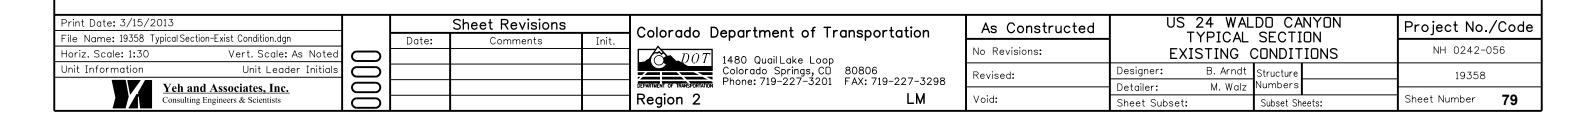
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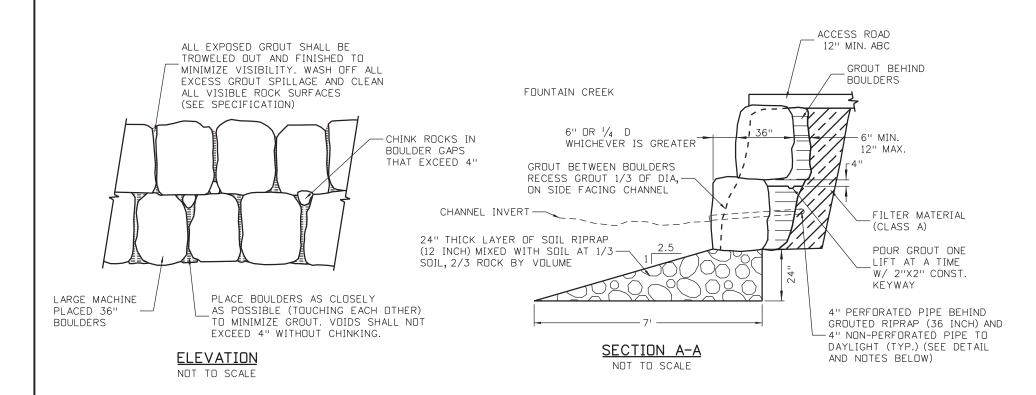
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Subset Sheets: J-9 of 41

Region 2

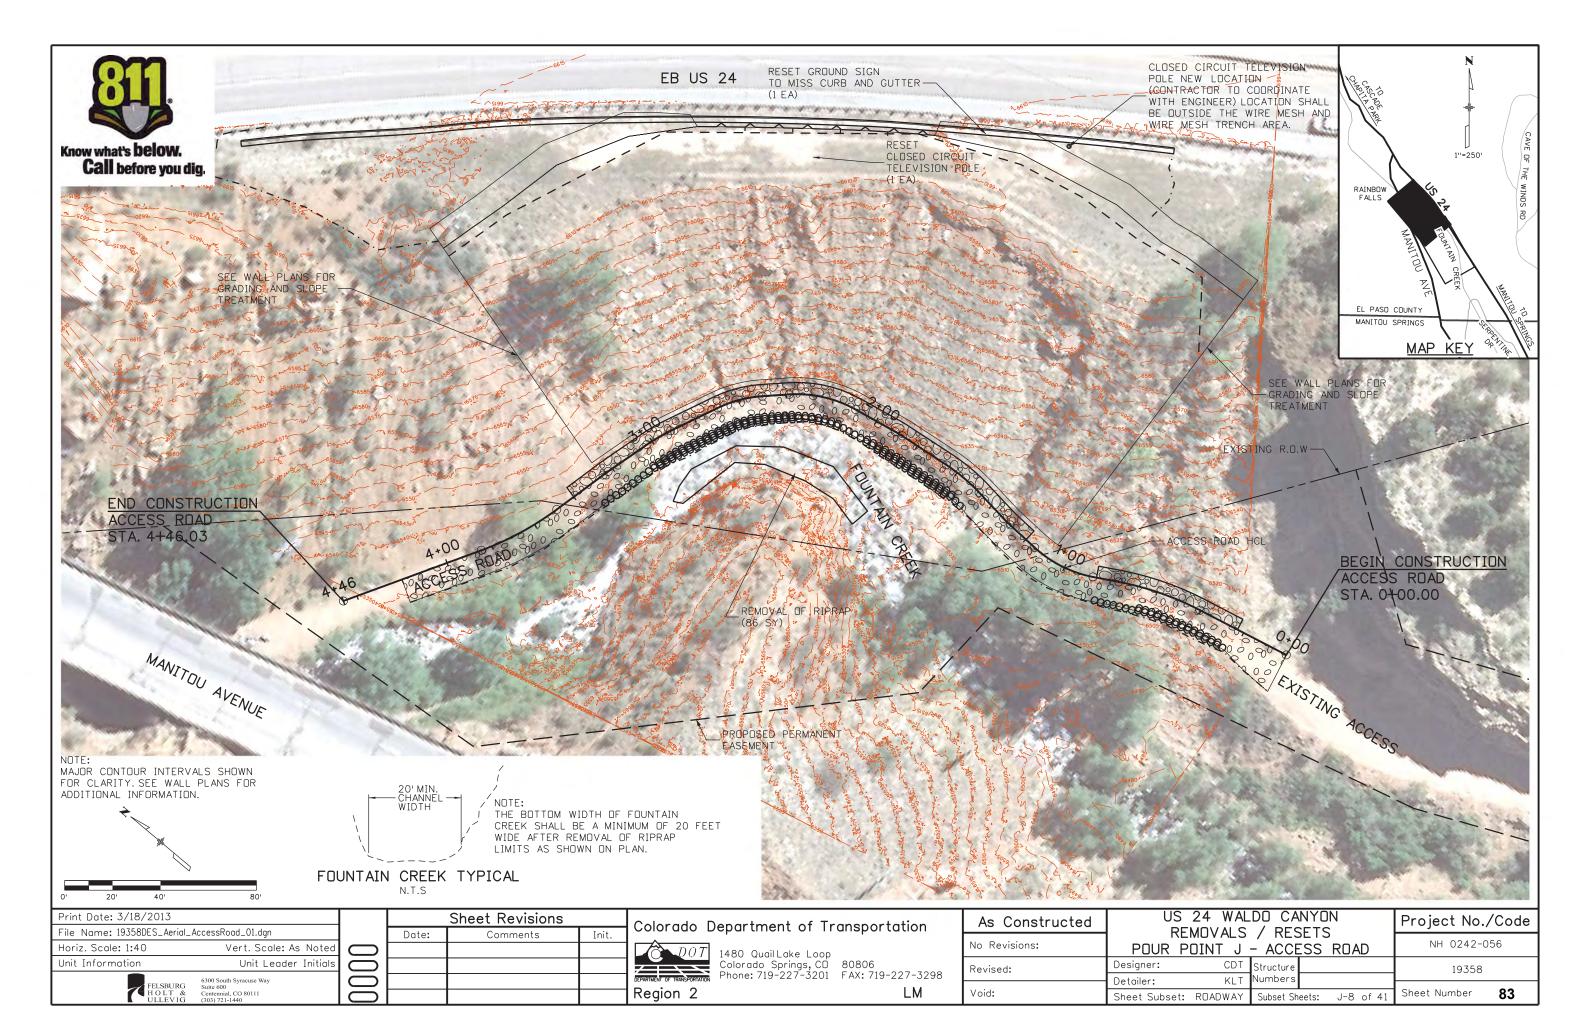

EROSION CONTROL BLANKET (STRAW/COCONUT) (SEE EROSION CONTROL -PLANS FOR LOCATION AND QUANTITIES) FINISHED GRADE -DESIGN RIPRAP GRADE SOIL RIPRAP (d50) (SEE PLANS) (MIX SOIL AND RIPRAP) TOPSOIL 6" TYP. DEPTH= 2' MIN. SUBGRADE VARIES (SEE PLANS) PEPARE COMPACTED SUBGRADE PER SPECIFICATIONS OR PLACE ON UNDISTURBED SUBGRADE OR SLOPE VARIES GEOTEXTILE (EROSION CONTROL) (SEE PLANS)

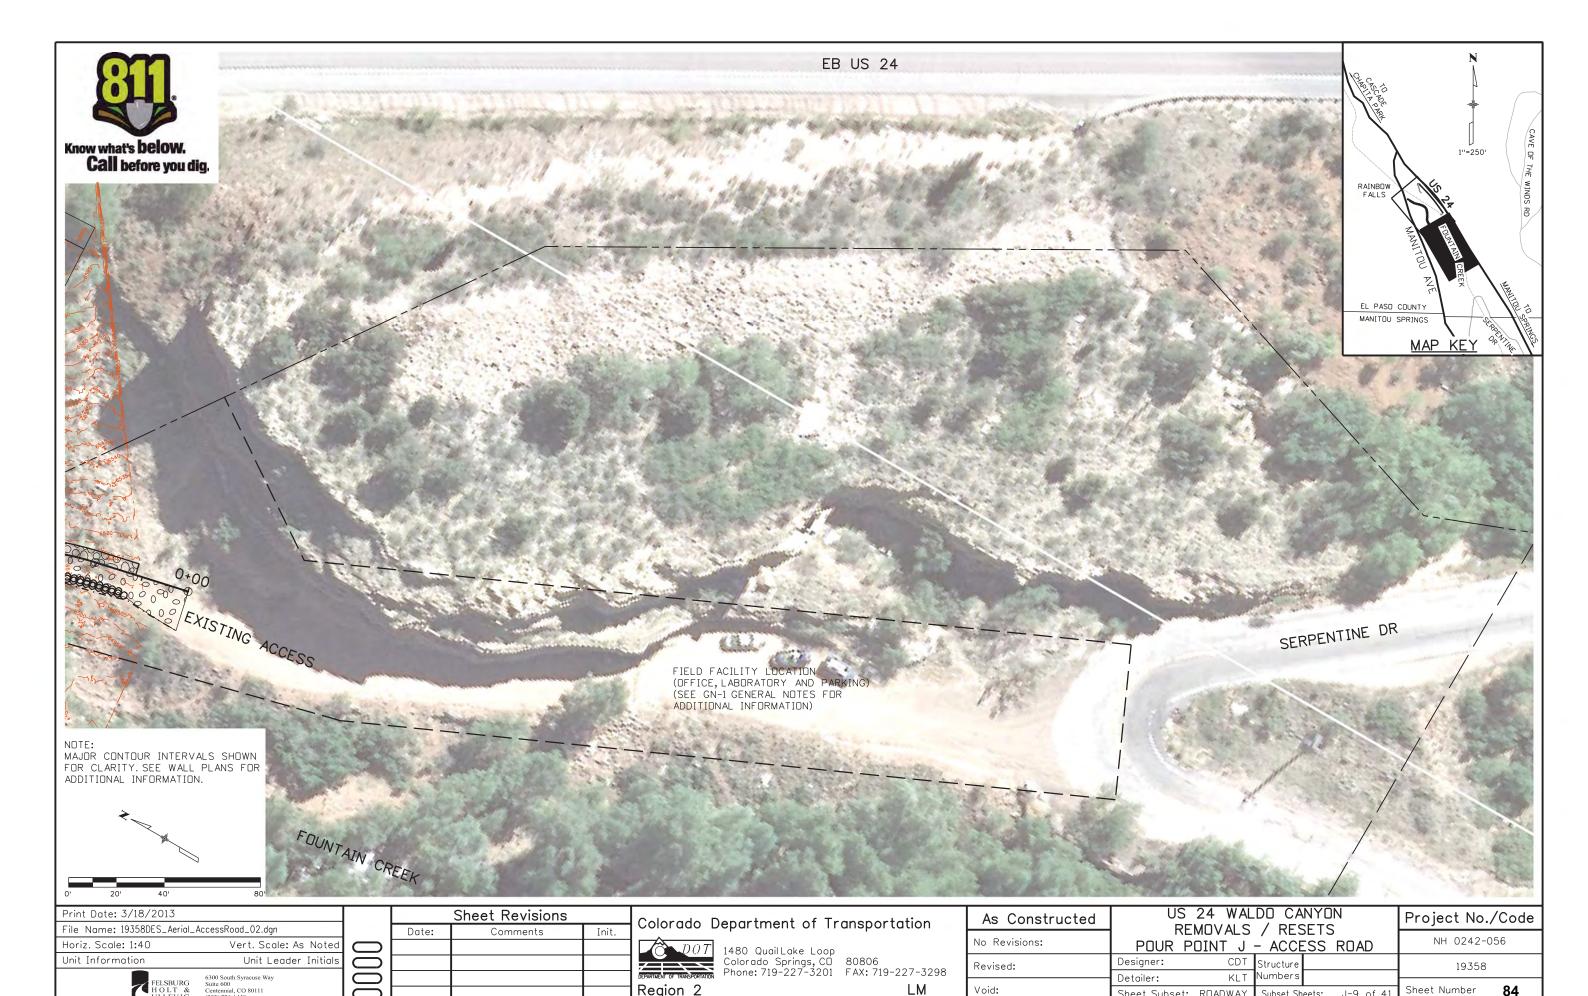
SOIL RIPRAP (d50) TYPICAL SECTION NOT TO SCALE

SOIL RIPRAP (12 INCH) NOTES:

- SOIL RIPRAP DETAILS ARE APPLICABLE TO SLOPED AREAS. REFER TO THE PLAN FOR ACTUAL LOCATION AND LIMITS.
- 2. MIX UNIFORMLY 2/3 RIPRAP BY VOLUME WITH 1/3 OF APPROVED SOIL BY VOLUME FROM THE ENGINEER PRIOR TO PLACEMENT.
- 3. PLACE STONE-SOIL MIX TO RESULT IN SECURELY INTERLOCKED ROCK AT THE DESIGN THICKNESS. GRADE COMPACT AND LEVEL TO ELIMINATE ALL VOIDS AND ROCKS PROJECTING ABOVE DESIGN RIPRAP TOP GRADE.
- 4. CRIMP MULCH AS CALLED FOR IN THE PLANS AND SPECIFICATIONS.
- 5. TOPSOIL PAID FOR AS TOPSOIL (CY). SEE PLANS FOR ADDITIONAL INFORMATION.

GROUT PLACEMENT NOTES:

- 1. TRENCH BEHIND BOULDERS A MINIMUM OF 12" OR $\frac{1}{2}$ d50, WHICHEVER IS LESS.
- 2. PLACE AND VIBRATORY -COMPACT GROUT FOR BOTTOM ROW OF BOULDERS BEFORE PLACING AND GROUTING TOP ROW OF BOULDERS.
- 3. GROUT MAY BE MIXED ON SITE FROM ONE PART PORTLAND CEMENT AND SIX PARTS SAND, BY VOLUME (15% CEMENT).
- 4. EQUIPMENT FOR GROUTING OPERATIONS SHALL BE LOCATED SOUTH OF THE PROJECT NEAR THE CONSTRUCTION STAGING AREA ADJACENT TO SERPENTINE DR.
- 4" PERFORATED PIPE NOTES:
- 1. SEE M-605-1 FOR PIPE UNDERDRAIN TYPICAL SECTION.
- 2. ALL MATERIALS AND LABOR SHALL BE INCLUDED IN THE COST OF GROUTED RIPRAP (36 INCH) (SPECIAL).

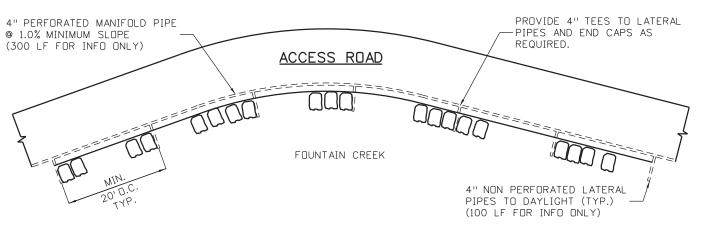


4" PERFORATED PIPE DETAIL


NOT TO SCALE

GROUTED RIPRAP (36 INCH) (SPECIAL) DETAILS

SOIL RIPRAP (d50) DETAILS

Print Date: 3/18/2013		Sheet Revisions		Colorado Department of Transportation		As Constructed	•	DO CANYON	Project No./Code
File Name: 19358HYDR_Detail_AccessRoad_01.dgn	Date:	Comments	Init.		Г		BOULDER	DETAILS	
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Unit Information Unit Leader Initials				Colorado Springs, CD 80806		Revised:	Designer: CDT	Structure	19358
FELSBURG 600 South Syracuse Way				DEPARTMENT OF TRANSPORTATION Phone: 719-227-3201 FAX: 719-227-329	¹⁸		Detailer: KLT	Numbers	
HOLT & Centennial, CO 80111 ULLEVIG (303) 721-1440				Region 2 LM		Void:	Sheet Subset: ROADWAY	Subset Sheets: J-10 DF 41	Sheet Number 85

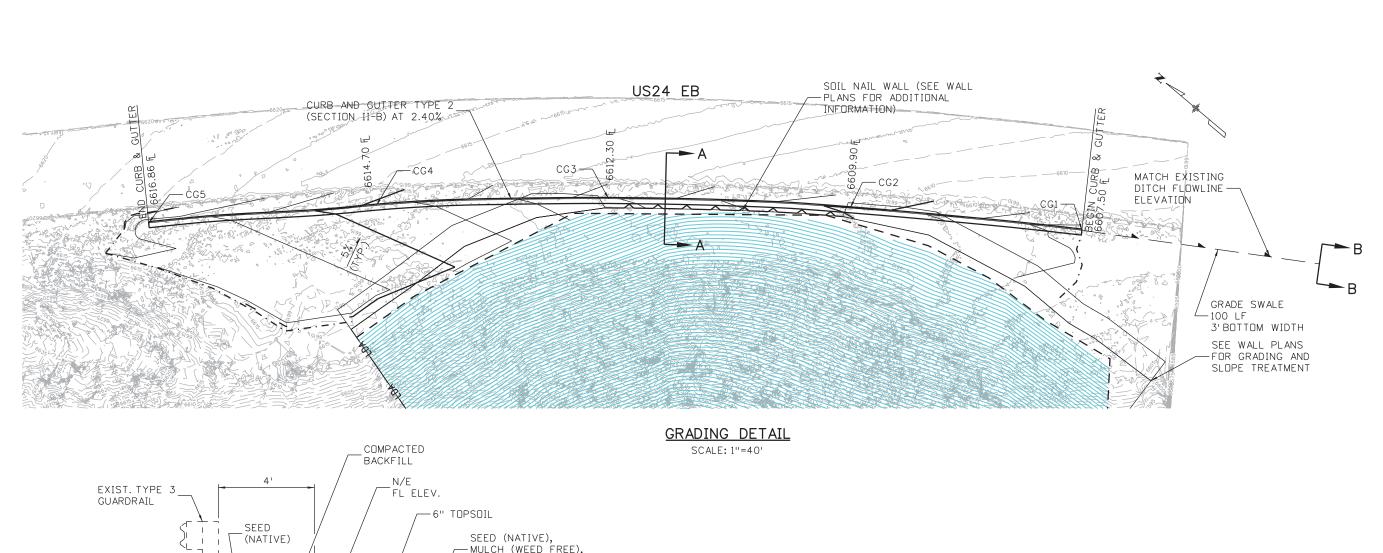

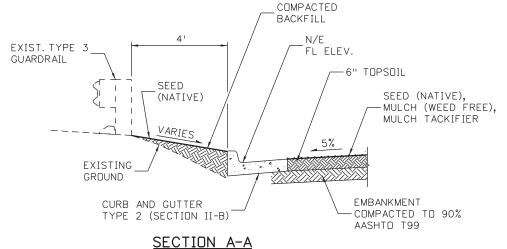

HORIZONTAL SCALE: 1"=10'

VERTICAL SCALE: 1"=10"

MATCH EXISTING DITCH FLOWLINE

SECTION B-B

N.T.S.

POINT DATA FOR CURB AND GUTTER

POINT	NORTHING	EASTING	ELEVATION	DESCRIPTION
CG1	165175.58	378409.65	6607.50	FINISHED GRADE - C&G FLOWLINE ELEVATION
CG2	165120.64	378489.65	6609.90	FINISHED GRADE - C&G FLOWLINE ELEVATION
CG3	165058.85	378569.31	6612.30	FINISHED GRADE - C&G FLOWLINE ELEVATION
CG4	164994.40	378641.67	6614.70	FINISHED GRADE - C&G FLOWLINE ELEVATION
CG5	164927.83	378709.67	6616.86	FINISHED GRADE - C&G FLOWLINE ELEVATION

Print Date: 3/18/2013		
File Name: 19358HYDR_Detail.	_AccessRoad_02.dgn	
Horiz. Scale: 1:40	Vert. Scale: As Noted	(
Unit Information	Unit Leader Initials	(
FELSBURG HOLT & ULLEVIG	6300 South Syracuse Way Suite 600 Centennial, CO 80111 (303) 721-1440	

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DEPARTMENT	$\overline{}$		1480 QuailLake Loop Colorado Springs, CO Phone: 719-227-3201	

As Constructed	US 24 WALDO CANYON GRADING DETAIL			Project No./Code			
No Revisions:	POUR POINT J - ACCESS ROAD				NH 0242-056		
Revised:	Designer:		Structure Numbers			19358	
Void:	Detailer: Sheet Subset:	1,70		ets:	J-11 OF 41	Sheet Number	86

GENERAL NOTES

- GROUND NAIL WALL IS INTENDED AS AN EMBANKMENT SLOPE STABILIZATION SYSTEM THAT WILL BE BACKFILLED IN FRONT OF THE FACING.
- ALL STEEL SHALL BE EPOXY-COATED OR GALVANIZED UNLESS OTHERWISE NOTED.
- 3. N DENOTES NON-COATED REINFORCING STEEL.

WIRE MESH

- WIRE MESH. WIRE MESH FOR FINAL SLOPE SHALL BE 8 X 10 DOUBLE TWIST HEXAGONAL NETTING, ZINC AND PVC COATED IN ACCORDANCE WITH ASTM A975-97 (2003). THE MINIMUM MESH WIRE DIAMETER SHALL BE 2.7 MM AND HAVE A TENSILE STRENGTH OF 75 KSI PER ASTM A 641 FOR SOFT TEMPER STEEL. CONTRACTOR SHALL SUBMIT SAMPLE COLOR FOR
- LACING WIRE AND FASTENERS. LACING WIRES, FASTENERS, TIES, CLIPS, AND CONNECTING WIRE SHALL BE SUPPLIED IN SUFFICIENT QUANTITY FOR SECURELY FASTENING ALL EDGES OF THE SLOPE PROTECTION WIRE MESH AS SHOWN IN THE PLANS AND SHALL BE IN ACCORDANCE WITH ASTM A 975-97(2003) PER PVC COATED GABION CHARACTERISTICS.
- MESH WILL BE MEASURED AND PAID BY THE SQUARE FOOT COMPLETED IN PLACE EXCLUSIVE OF THE AREA OF WIRE MESH USED IN ANY OVERLAPS. CONTRACTOR TO VERIFY QUANTITIES WITH ENGINEER PRIOR TO ORDERING MATERIALS.

GROUND NAIL WALL

- GROUND NAILS-ASTM A 519, HOLLOW INJECTION BAR, MINIMUM 1-1/2INCH (38mm) BAR WITH A MINIMUM YIELD STRENGTH OF 90 KIPS. BARS SHALL BE EPOXY COATED PER ASTM A-934 (PURPLE COATING).
- CONTRACTOR TO INSTALL 3 VERIFICATION TESTS AT LOCATIONS DESIGNATED IN PLANS OR AS APPROVED BY THE ENGINEER. VERIFICATION GROUND NAILS TO BE INSTALLED FULL DI WITH UPPER 10 FEET HAVING ADEQUATE BOND BREAKER TO TRANSFER LOADING TO BOTTOM 5 FEET OF GROUND NAIL. TESTING SHALL BE CONDUCTED AND ACCEPTED BY THE ENGINEER PRIOR TO PRODUCTION NAIL CONSTRUCTION.
- GROUT GROUT MAY BE NEAT-CEMENT OR WITH SAND, WITH TYPE II CEMENT IN ACCORDANCE WITH ASTM C150. WATER-CEMENT RATIO SHOULD BE BETWEEN 0.4 AND 0.6 AND GROUT SHOULD DEVELOP THE FOLLOWING STRENGTHS AT THE SPECIFIED CURE PERIODS.

 f'c=3,000 PSI MINIMUM 7 DAY
- END HARDWARE NUTS AND WASHERS SHALL BE IN ACCORDANCE WITH GROUND NAIL MANUFACTURER'S RECOMMENDATIONS BEARING PLATE SHALL BE IN ACCORDANCE WITH ASTM A36, GRADE 36. ALL NUTS, WASHERS AND BEARING PLATES SHALL BE EPOXY COATED IN ACCORDANCE WITH ASTM A934.
- SHOTCRETE IN ACCORDANCE WITH CDOT REVISED SECTION 641.
- UNLESS OTHERWISE NOTED ON THE PLANS, MINIMUM COVER OF SHOTCRETE REINFORCEMENT AND NAIL END HARDWARE SHOULD BE AS FOLLOWS:
 FACE EXPOSED TO WEATHER 2"
 FACE EXPOSED TO SOIL 3"
- 7. WELDED WIRE MESH SHALL BE IN ACCORDANCE WITH ASTM A185. FY=65,000 PSI
- WALERS AND VERTICAL BEARING BARS SHALL BE IN ACCORDANCE WITH ASTM A615. FY=60,000 PSI
- STRIP DRAINS CONSIST OF 12" WIDE DIMPLED CORES WRAPPED IN GEOTEXTILE IN ACCORDANCE WITH SPECIAL PROVISIONS.

<u>GROUND NAIL WALL SPECIAL NOTES</u>

- THE CONTRACTOR IS RESPONSIBLE FOR MAINTAINING SLOPE STABILITY ABOVE AND BELOW THE GROUND NAIL WALL DURING CONSTRUCTION.
- THE CONTRACTOR IS RESPONSIBLE FOR FIELD LOCATING ALL NEARBY UTILITIES. CONFLICTING UTILITIES MAY REQUIRE GROUND NAIL WALL REDESIGN, AT ENGINEER'S DISCRETION.
- THE BOND STRENGTHS (Q_d) SHOWN ON THE PLANS ARE THE MINIMUM ASSUMED FOR DESIGN.
- GROUND NAIL LENGTHS SHOWN ON THE PLANS ARE THE MINIMUM LENGTHS REQUIRED.
- 5. PRIOR TO BEGINNING EXCAVATION FOR THE GROUND NAIL WALL, THE CONTRACTOR SHALL:
 - A. SURVEY THE LAYOUT LINE AND TOP OF WALL LINE.
 - CONFIRM THE LINES, GRADES, AND EXCAVATION LIMITS SHOWN ON THE PLANS.
 - THE CONTRACTOR SHALL MODIFY THE PLAN WALL PROFILES USING THE FIELD SURVEY INFORMATION AND SUBMIT TO THE ENGINEER FOR REVIEW AND APPROVAL.

GROUND NAIL WALL CONSTRUCTION SEQUENCE

- EXCAVATE ONE LIFT TO A MAXIMUM DEPTH OF FIVE (5) FEET. BOULDERS, COBBLES AND/OR BEDROCK MAY BE ENCOUNTERED AT ANY DEPTH OF THE EXCAVATION OR DURING DRILLING. IF SLOUGHING GROUND CONDITIONS ARE ENCOUNTERED, GROUND NAILS SHALL BE DRILLED AND INSTALLED THROUGH A TEMPORARY STABILIZING BERM OR PLACEMENT OF A SACRIFICIAL REINFORCED SHOTCRETE FLASH COAT SHALL BE USED TO TEMPORARILY STABILIZE EXCAVATION PRIOR TO DRILLING GROUND NAILS, CARE SHOULD BE TAKEN DURING EXCAVATION THAT NO GROUND IS LOST FROM BEHIND THE EXISTING SHOTCRETE.
- PROVIDE A PRODUCTION NAIL LOCATION PLAN TO THE ENGINEER FOR REVIEW. INSTALL GROUND NAILS AT THE SPACINGS AND TO THE LENGTHS SHOWN ON THE PLANS. INJECT GROUT CONTINUOUSL AS GROUND NAIL IS DRILLED/INSERTED. THE TOP ROW OF GROUND NAILS SHALL BE WITHIN 2.5 FEE OF THE TOP OF THE WALL. THE BOTTOM ROW OF NAILS SHALL BE WITHIN 2 FEET OF THE BOTTOM OF THE WALL. THE TOLERANCE FOR GROUND NAIL LOCATIONS SHALL BE 6 INCHES.
- THE DRILL HOLE SHALL BE GROUTED CONTINUOUSLY DURING DRILLING. CONTINUOUS GROUT FLOW SHALL BE OBSERVED AT THE SURFACE. IF LOSS OF GROUT CIRCULATION OCCURS, DRILLING ADVANCEMENT SHOULD BE STOPPED AND GROUT PUMPING SHALL CONTINUE UNTIL GROUT RETURN IS RE-ESTABLISHED. IF GROUT RETURN DOES NOT RE-ESTABLISH. THE BAR SHALL BE REMOVED AND THE ENGINEER SHOULD BE NOTIFIED. THE COMPLETE GROUND NAIL INSTALLATION, INCLUDING DRILLING, NAIL PLACEMENT AND GROUTING SHALL OCCUR WITHIN THE SAME WORK SHIFT. DRILL HOLES SHALL NOT BE LEFT OPEN OVERNIGHT FOR COMPLETION DURING A SUBSEQUENT SHIFT.
- INSTALL SHOTCRETE TO THE MINIMUM THICKNESS SHOWN ON THE DRAWINGS AND TO ATTAIN THE MINIMUM COVERAGES SPECIFIED HEREIN. GIVE SPECIAL ATTENTION TO FILLING THE VOID IN THE BORE HOLE ABOVE THE GROUT LINE. COLD WEATHER PROTECTION MEASURES MAY BE NECESSARY.
- INSTALL THE GROUND NAIL END HARDWARE AFTER THE SHOTCRETE HAS BEEN INSTALLED. WHILE THE SHOTCRETE IS STILL WET, EMBED THE PLATE INTO THE SHOTCRETE SURFACE UNTIL THERE IS NO VOID BEHIND THE PLATE. HAND TIGHTEN THE NUT. APPLY ADDITIONAL SHOTCRETE TO ATTAIN MINIMUM COVERAGE FOR THE GROUND NAIL AND END HARDWARE.
- ONCE THE GROUT AND SHOTCRETE OF THE CURRENT LIFT HAVE ATTAINED 50% OF THEIR SPECIFIED STRENGTHS, REPEAT CONSTRUCTION SEQUENCE TO THE BOTTOM OF THE WALL.
- 8. AT THE BOTTOM LIFT, CONSTRUCT GEOCOMPOSITE STRIP DRAINS AS SHOWN ON THE DRAWINGS.

GROUND NAIL WALL DESIGN PARAMETERS

1. THE FOLLOWING VALUES HAVE BEEN USED FOR DESIGN PARAMETERS:


Ф GRANULAR ON-SITE SOIL

ANGLE OF INTERNAL FRICTION COHESION UNIT WEIGHT DESIGN SHEAR RESISTANCE BOND STRESS (ALLOWABLE) Q_d

LIMITATIONS FOR ROCKFALL SYSTEM

ROCKFALL AND ROCKFALL EVENTS ARE SPORADIC AND UNPREDICTABLE. CAUSES CAN INCLUDE, BUT ARE NOT LIMITED TO, FACTORS SUCH AS ANIMAL, HUMAN, CONSTRUCTION, ENVIRONMENTAL, WEATHER, AND/OR EARTHQUAKES. BECAUSE OF THE MULTIPLICITY OF FACTORS AFFECTING ROCKFALL DYNAMICS, ROCKFALL CANNOT BE PREDICTED AND IS NOT AN EXACT SCIENCE THAT GUARANTEES THE SAFETY OF INDIVIDUALS AND PROPERTY. HOWEVER, BY THE APPLICATION OF SOUND ENGINEERING PRINCIPLES TO A RANGE OF ROCKFALL DYNAMICS, THE RISK OF INJURY AND PROPERTY LOSS CAN BE REDUCED BY THE USE OF PROPERLY DESIGNED ROCKFALL MITIGATION FEATURES IN IDENTIFIED RISK AREAS. CONSEQUENTLY, NEITHER THE ROCKFALL HAZARD IN TERMS OF PROBABILITY OF A ROCKFALL AT ANY SPECIFIC LÓCATION, NOR THE RISK TO PEOPLE OR FACILITIES FROM SUCH EVENTS, IS ASSESSED IN THE DESIGN.

PERIODIC INSPECTION AND MAINTENANCE OF ROCKFALL MITIGATION FEATURES IS NECESSARY TO ENSURE THE DESIRED PROTECTION LEVEL IS NOT DEGRADED BY IMPACT DAMAGE WHICH EXCEEDS THE DESIGN LIMITS OF THE MESH SYSTEM INCLUDING, BUT NOT LIMITED TO, EXTREMELY WET SNOW AVALANCHES OR LARGE DEBRIS FLOW EVENTS.

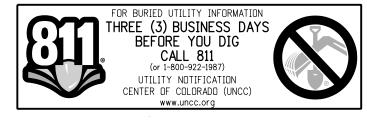


Print Date: 3/18/2013			Sheet Revisions		0-1
File Name: 19358 SNW General Notes.dgn		Date:	Comments	Init.	Colorado
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Yeh and Associates, Inc.					DEPARTMENT OF TRANSPORTATION
Consulting Engineers & Scientists					Region 2


Colorado Department of Transportation




1480 Quail Lake Loop Colorado Springs, CO 80806 Phone: 719-227-3201 FAX: 719-227-3298

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	Detailer: M. Wal	Numbers		
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GNL= GROUND NAIL LENGTH

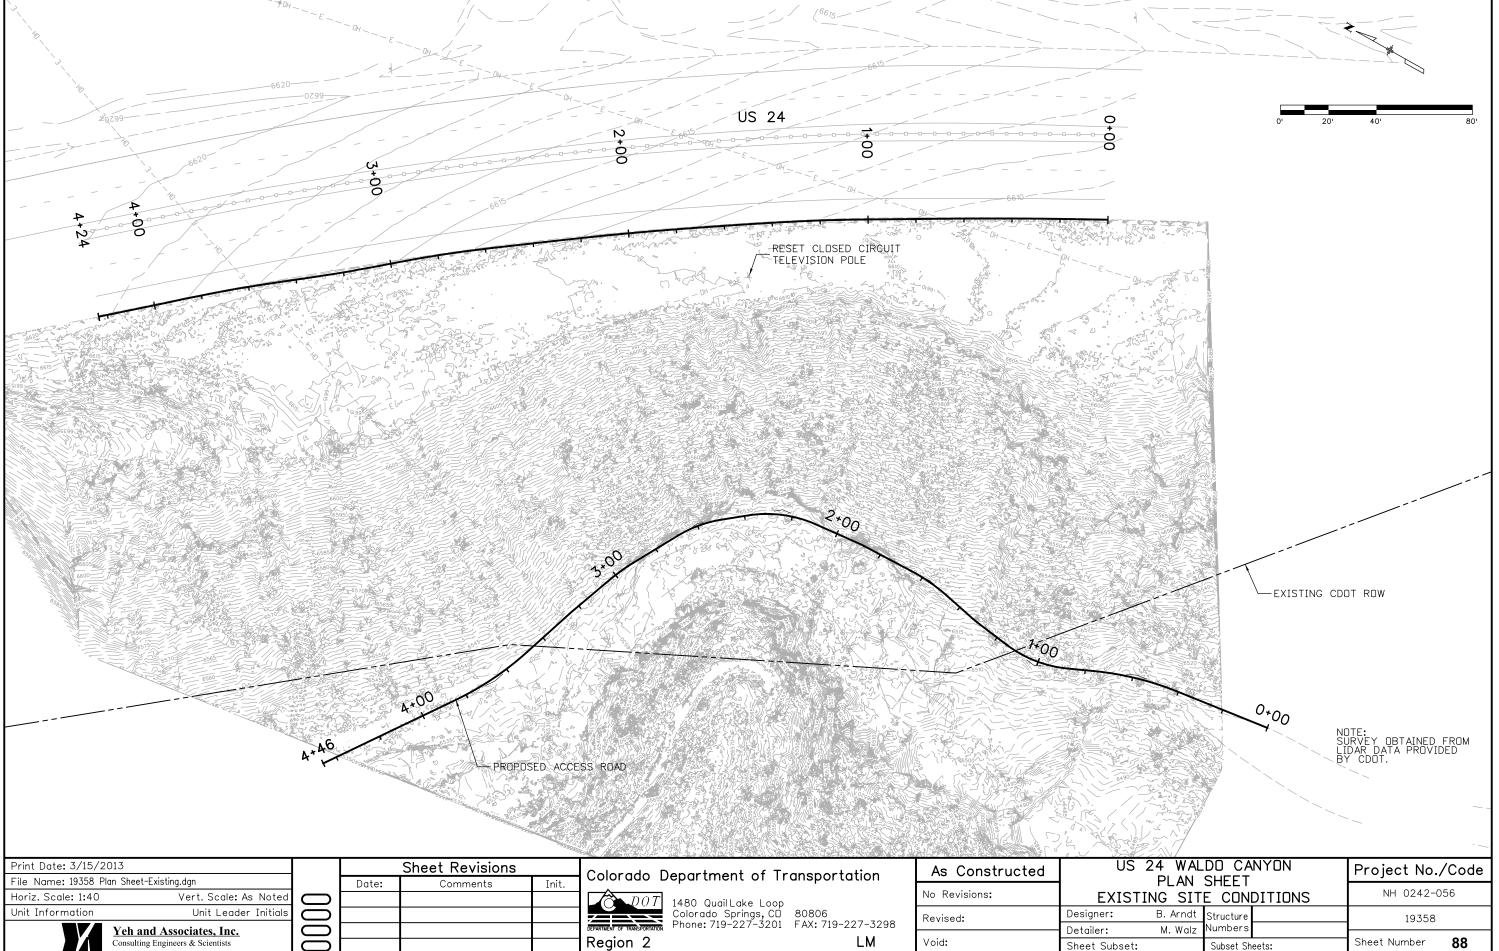⊕ 15' SACRIFICIAL GROUND NAIL LOCATIONS (BOND BREAKER IN UPPER 10' OF BAR)

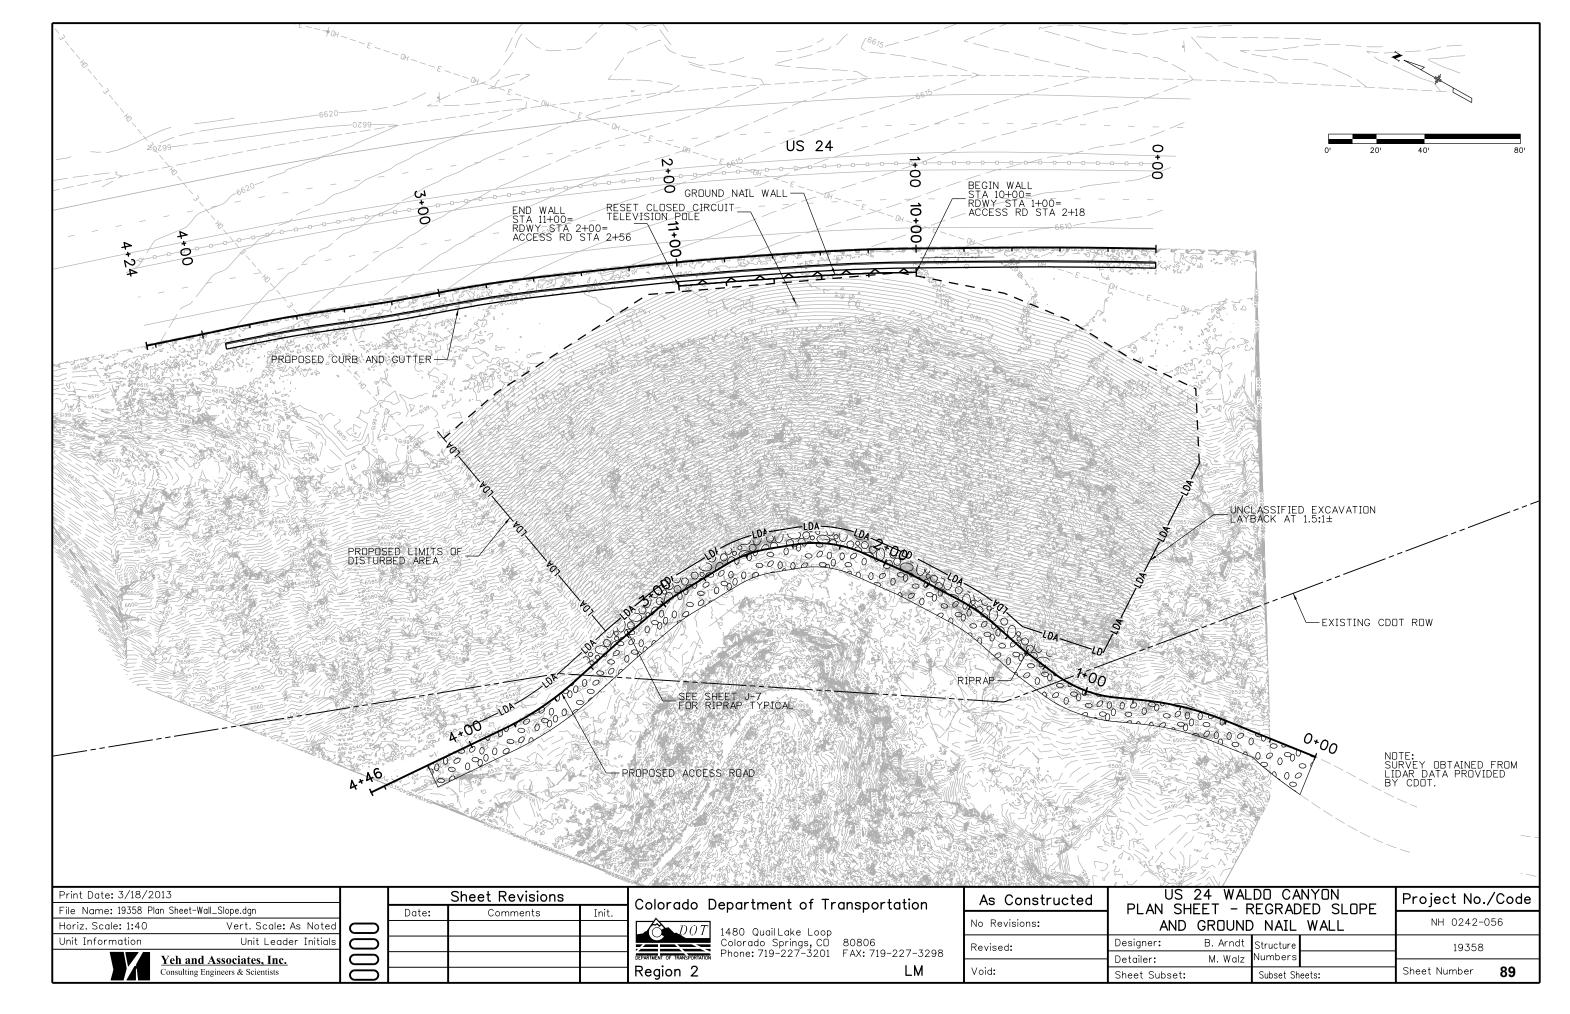Yeh and Associates, Inc.
Consulting Engineers & Scientists

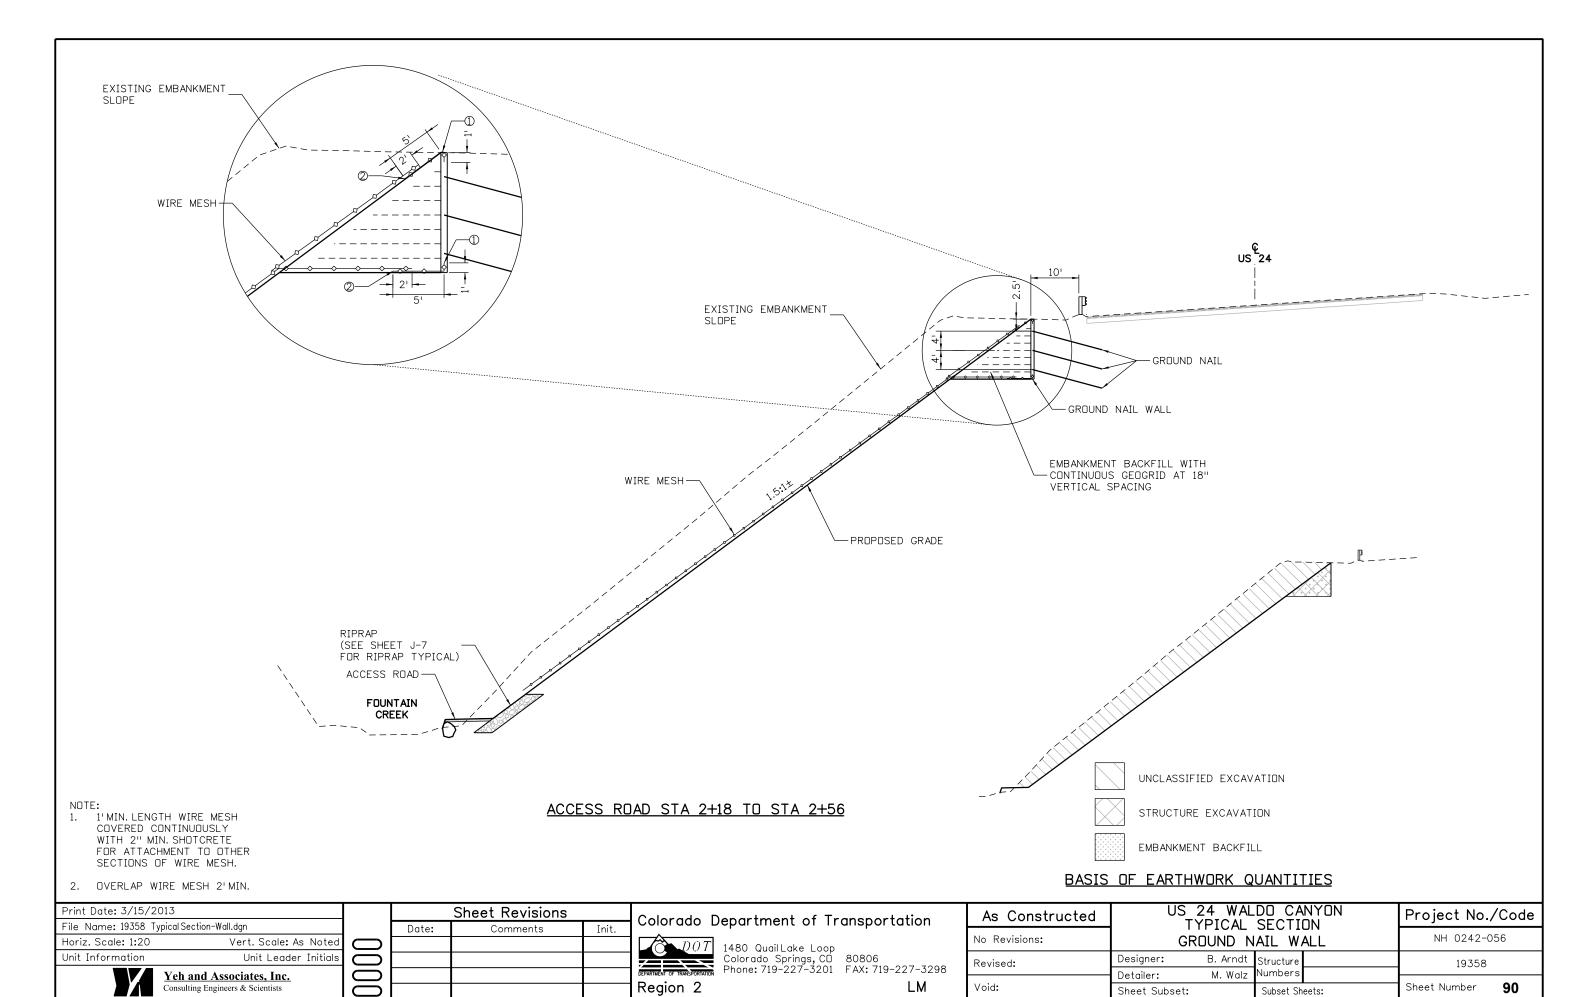Vert. Scale: As Noted

Unit Leader Initials

Sheet Revisions

Init.

Region 2

Date:


☐ 15' GROUND NAIL

Print Date: 3/15/2013

Horiz. Scale: 1:10

Unit Information

File Name: 19358 SN Elevation.dgn

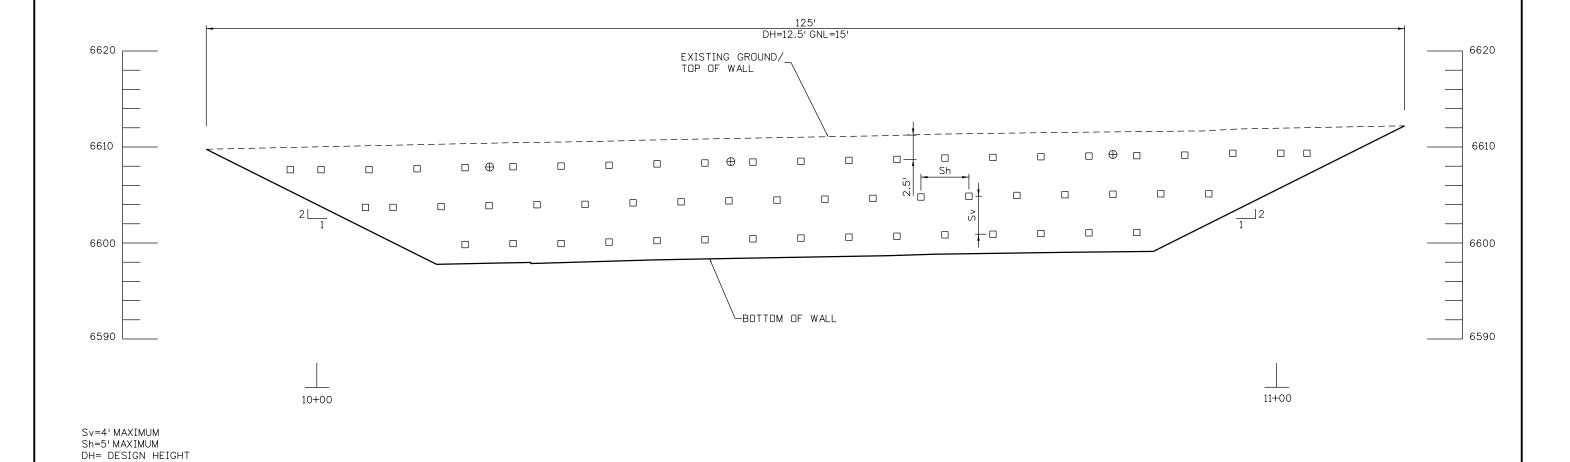

Colorado Department of Transportation

1480 QuailLake Loop Colorado Springs, CD 80806 Phone: 719-227-3201 FAX: 719-227-3298 US 24 WALDO CANYON WALL ELEVATION

B. Arndt Structure

Numbers

Subset Sheets:

M. Walz

Designer:

Detailer:

Sheet Subset:

As Constructed

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Revised:

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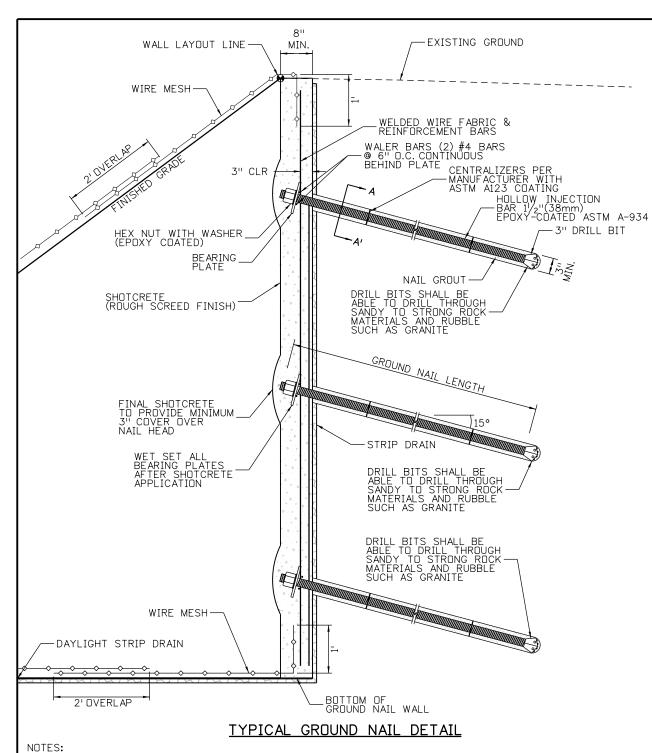
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NH 0242-056

19358

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Sheet Number




SHALL BE INSTALLED THROUGHOUT THE ENTIRE SHOTCRETE FACING, INCLUDING THE FACING BEYOND THE GROUND NAILS. 2. MAXIMUM EDGE DISTANCE OF 3 FT FOR


REINFORCEMENT OF THE SHOTCRETE FACING

- EACH ROW OF GROUND NAILS AT END OF WALL.


4. 3" MIN. COVER ON ALL REINFORCING EXPOSED TO GROUND.

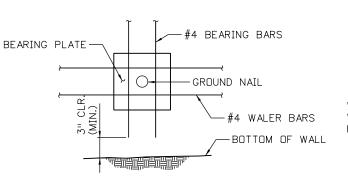


TYPICAL REINFORCEMENT BOTTOM ROW OF GROUND NAILS

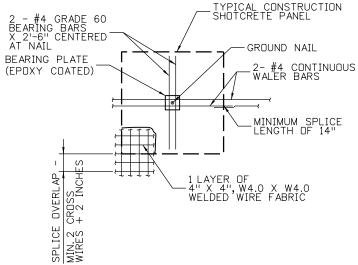


TYPICAL SHOTCRETE FACING PANEL REINFORCEMENT

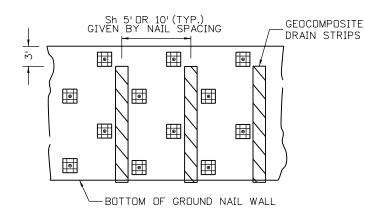


TYPICAL STRIP DRAIN DETAIL

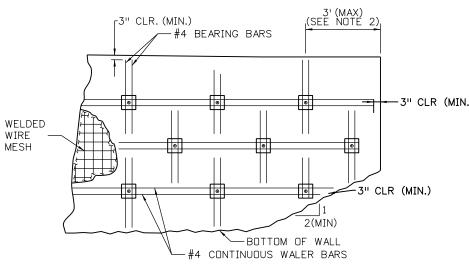

TYPICAL SHOTCRETE FACING REINFORCEMENT - END OF WALL (NOTE 1)

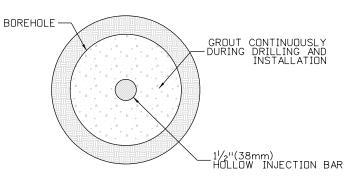

GROUND NAIL CROSS SECTION A-A'

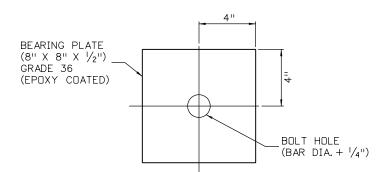

BEARING PLATE DETAIL

3.	THE	MINIMUM	SHOTCRETE	THICKNESS	IS	8	IN.
	FOR	WALL FA	CE.				

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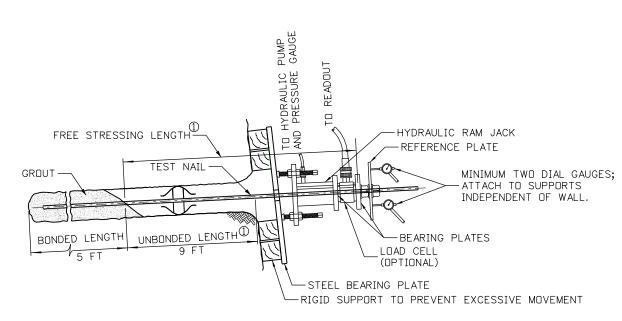
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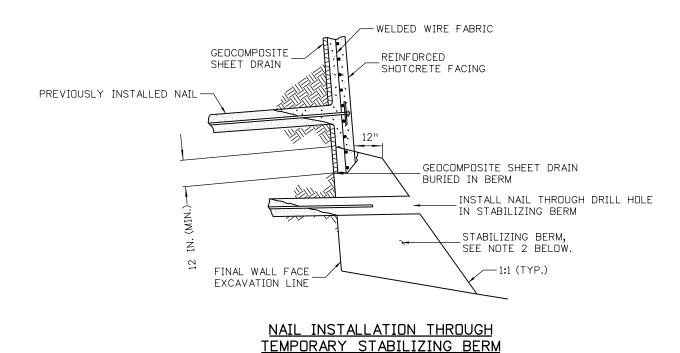
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80 QuailLake Loop Norado Springs, CD 80806 one: 719-227-3201 FAX: 719-227-3298 LM

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Revised:		Structure	19358	
Void:	Detailer: M. Walz Sheet Subset:	Numbers Subset Sheets:	Sheet Number 92	



VERIFICATION GROUND NAIL TEST SETUP



(USE IN CASE OF SLOUGHING GROUND)

NOTES

- I. VERIFICATION NAILS WILL HAVE BONDED, UNBONDED AND FREE STRESSING LENGTHS. PRODUCTION NAILS WIL BE BONDED FOR THE FULL NAIL LENGTH.
- 2. EXCAVATE STABILIZING BERM TO FINAL WALL FACE EXCAVATION LINE FOR SHOTCRETE PLACEMENT. CONTRACTOR SHALL CAREFULLY EXCAVATE STABILIZING BERM TO AVOID HITTING GROUND NAILS BURIED IN THE BERM.

Print Date: 3/15/2013			Sheet Revisions	
File Name: 19358 SNW Tes	ting and Const.dgn	Date:	Comments	Init.
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Unit Information	Unit Leader Initial			
<u>Yeh</u>	and Associates, Inc.			
Consul	ting Engineers & Scientists			

Colorado Department of Transportation




1480 Quail Lake Loop Colorado Springs, CD 80806 Phone: 719-227-3201 FAX: 719-227-3298


Region 2

US 24 WALDO CANYON GROUND NAIL DETAILS Project No./Code As Constructed NH 0242-056 No Revisions: B. Arndt Structure Designer: Revised: 19358 Numbers M. Walz Detailer: Void: Sheet Number 93 Sheet Subset: Subset Sheets:

GROUND NAIL TESTING NOTES:


- 1. SEE SPECIFICATIONS FOR TESTING REQUIREMENTS.
- 2. THE TEST SUPPORT SYSTEM (EG. CRIBBING, CHAIRS, BEARING PLATES, ETC.)
 SHALL BE SUFFICIENT TO COMPLETE THE TEST WITHOUT EXCESSIVE DEFLECTION
 OR BEARING FAILURE. IF TEST SETUP IS NOT ADEQUATE FOR TEST, CONTRACTOR
 SHALL PROPOSE SYSTEM TO ENGINEER.

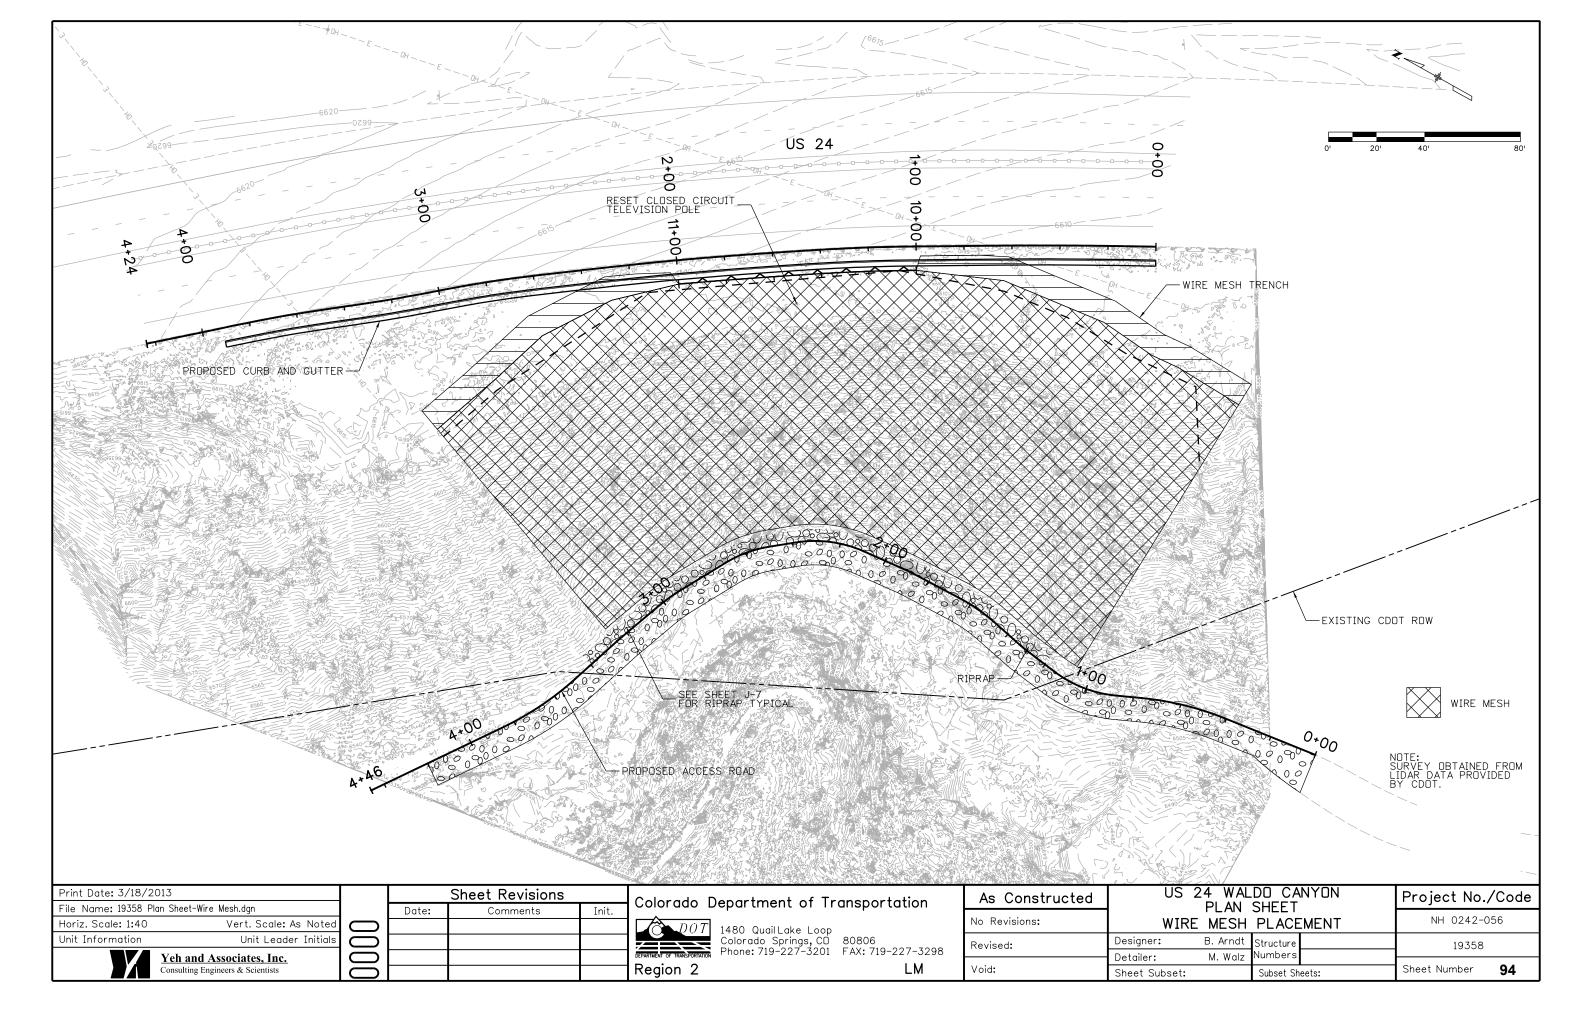


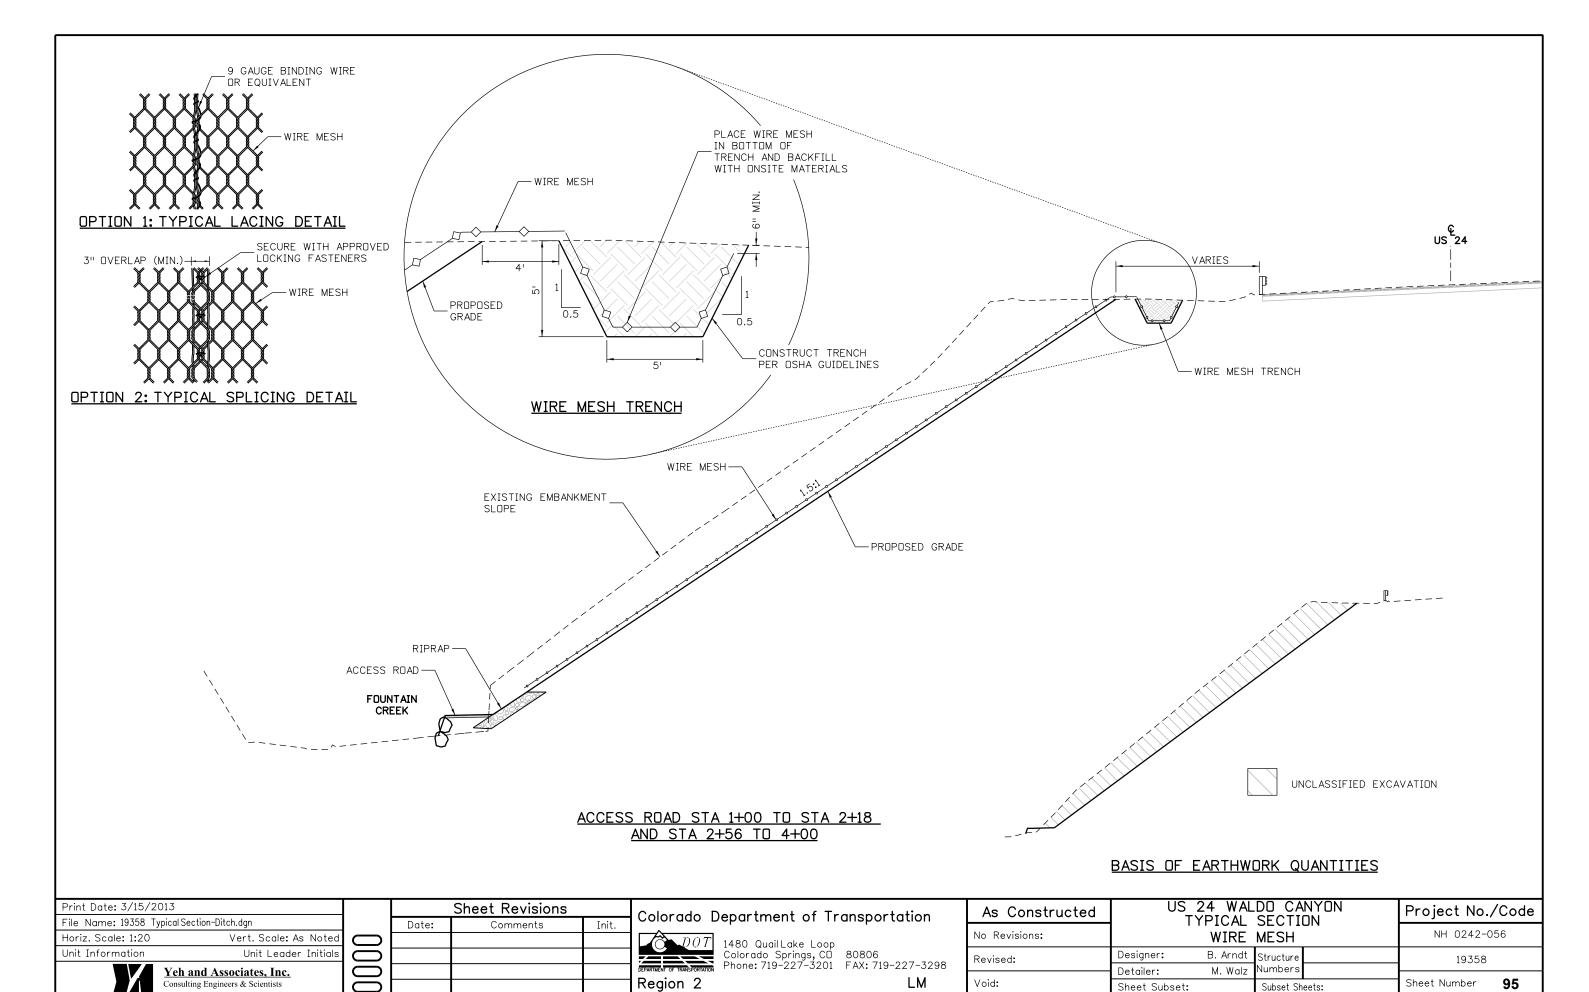

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NH 0242-056

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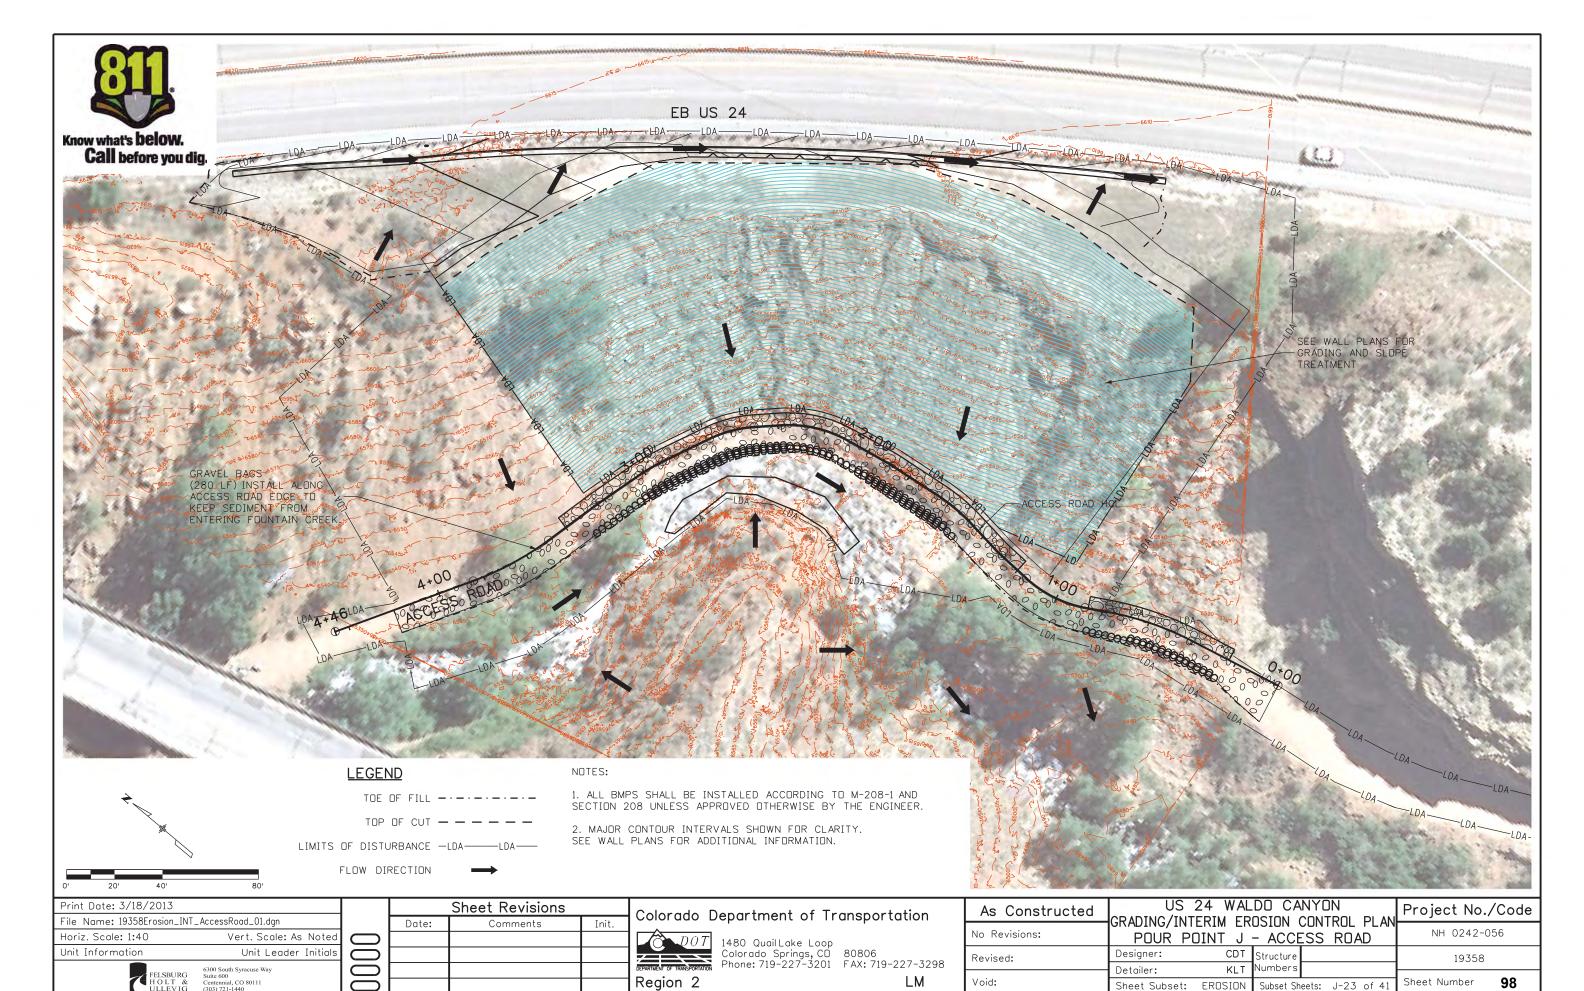
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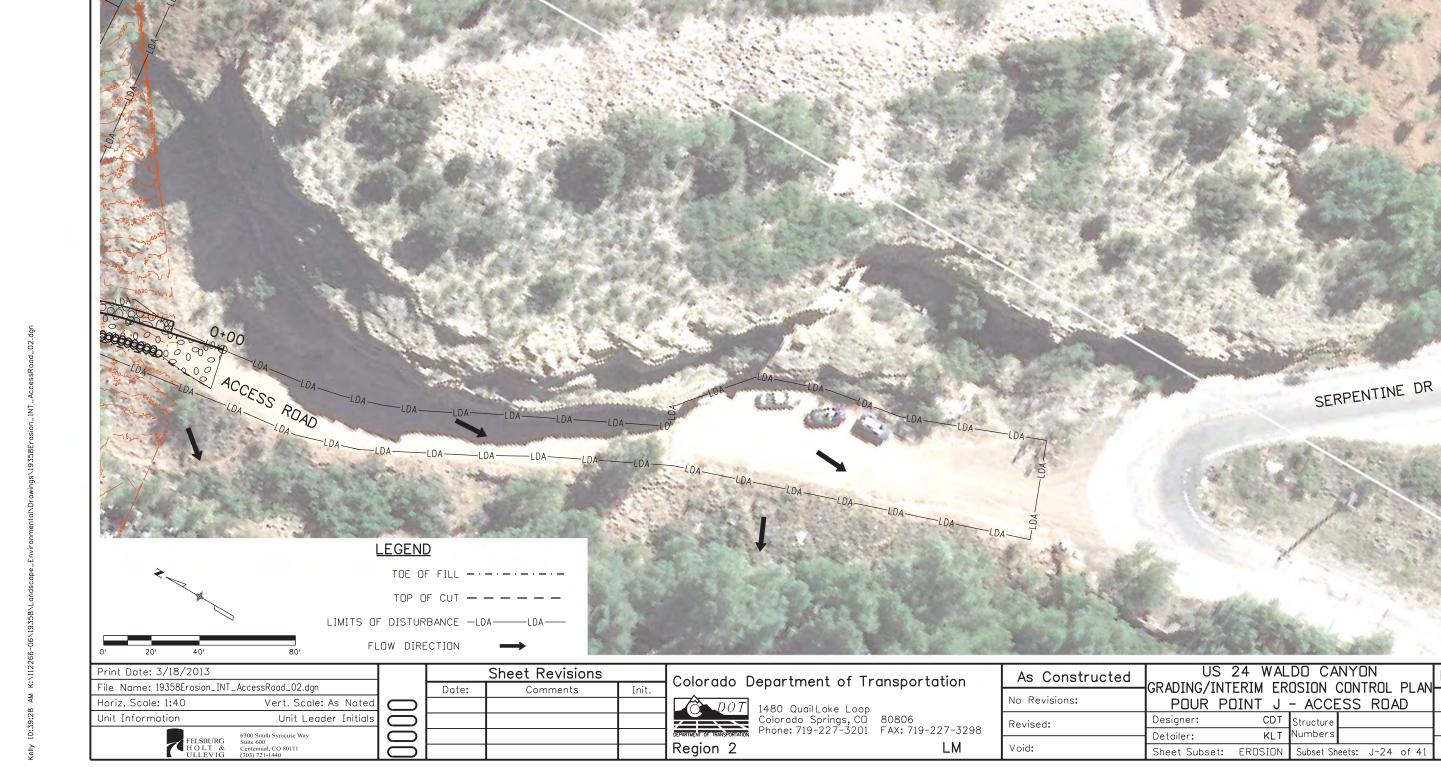
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CDT Structure

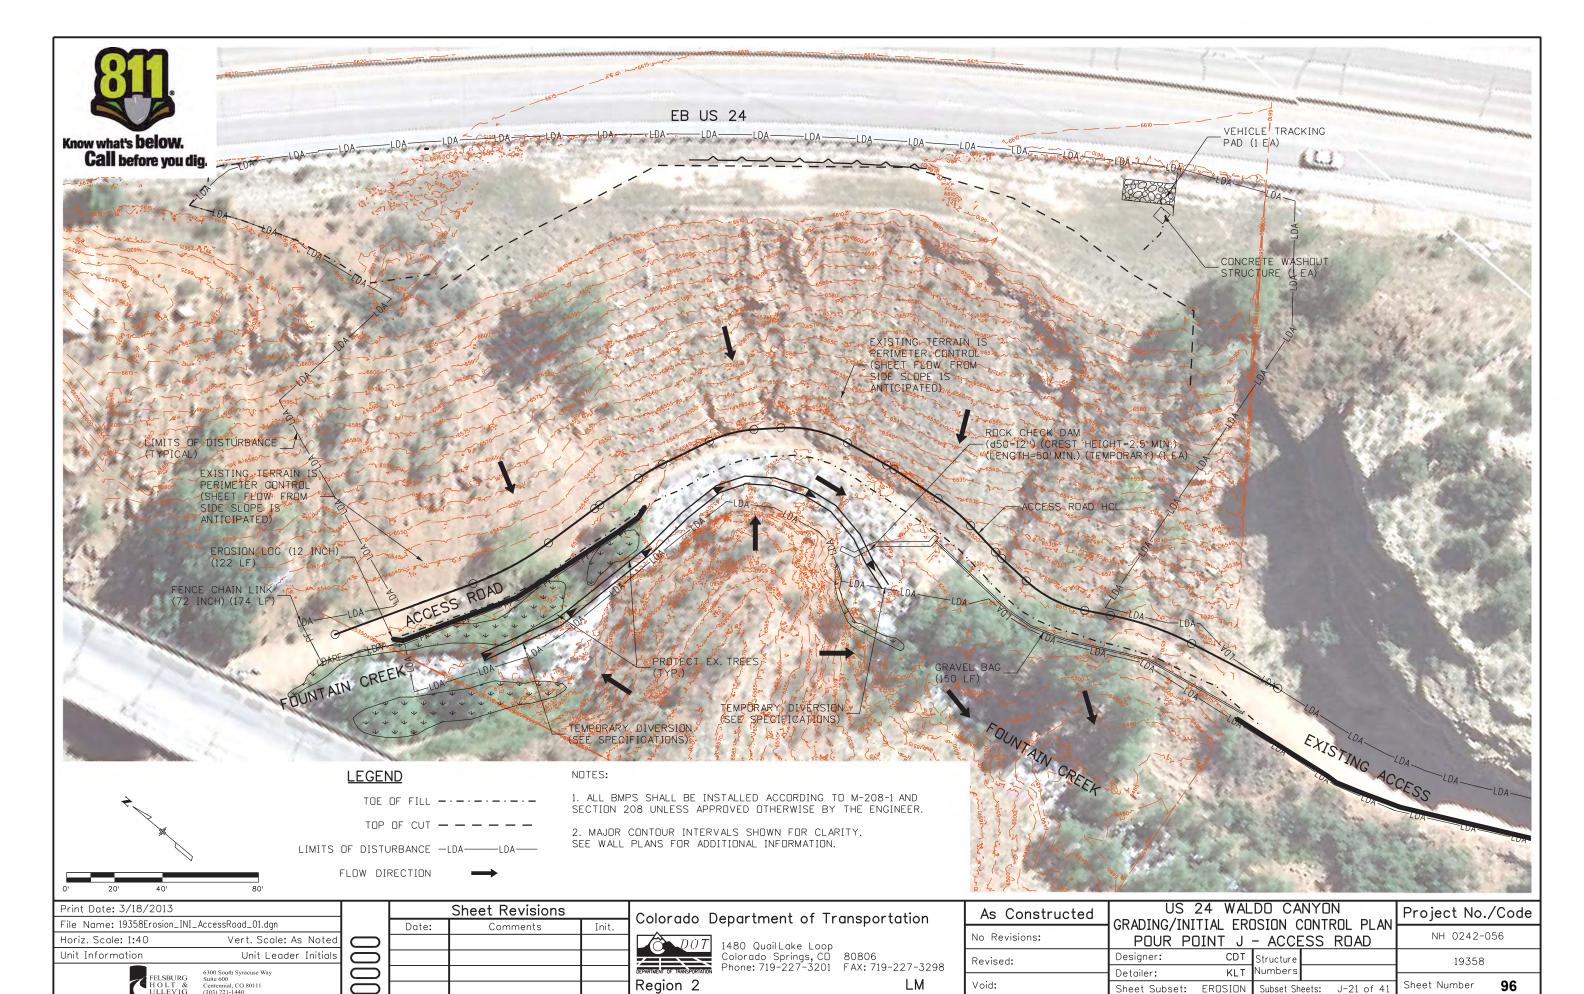Subset Sheets: J-22 of 41

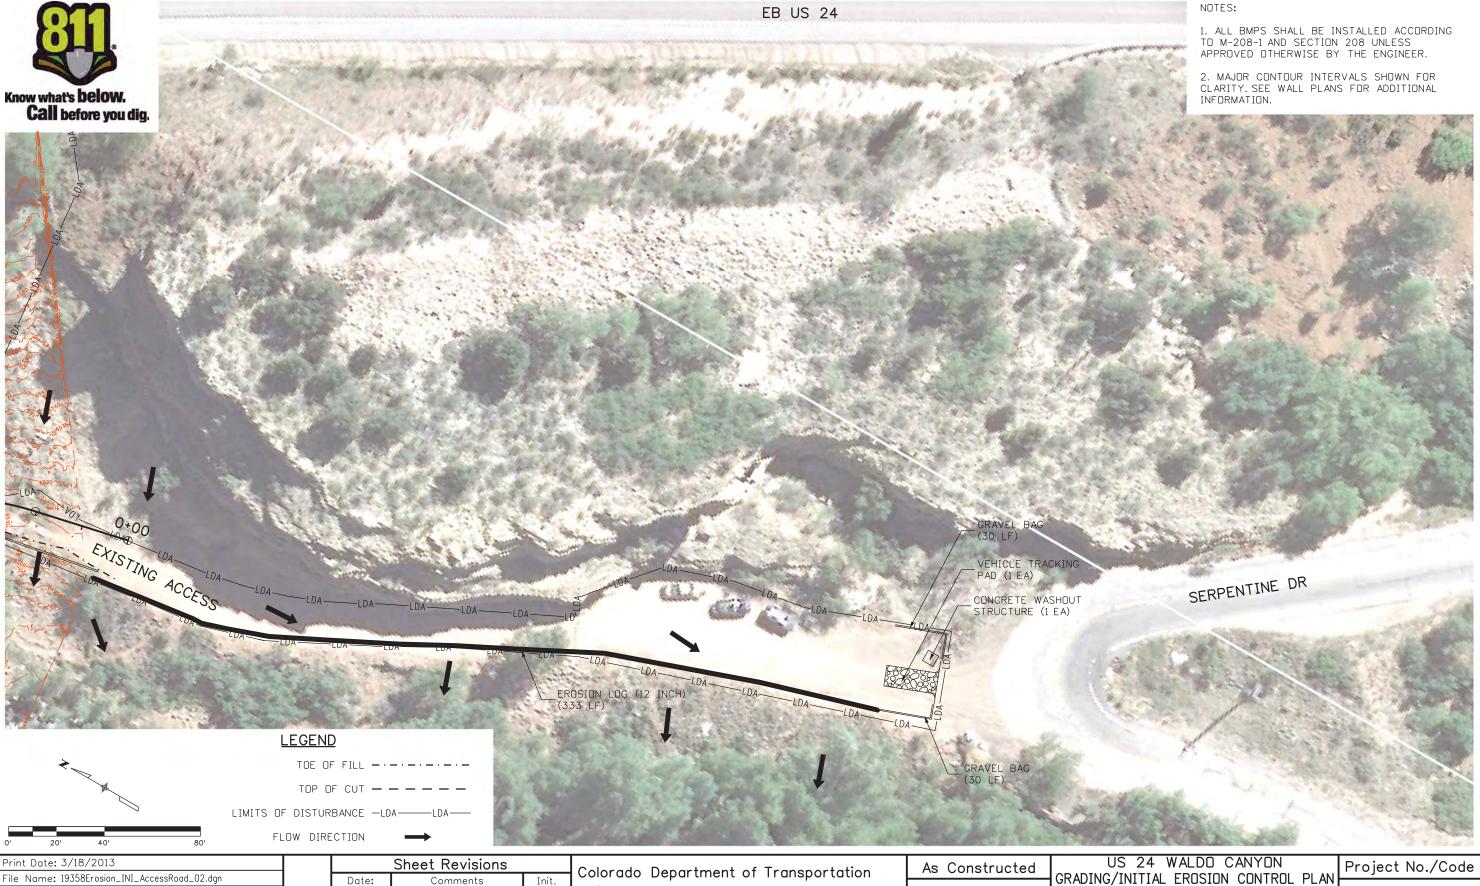



EB US 24

NOTES:

1. ALL BMPS SHALL BE INSTALLED ACCORDING TO M-208-1 AND SECTION 208 UNLESS APPROVED OTHERWISE BY THE ENGINEER.

Project No./Code


NH 0242-056

19358

Sheet Number

2. MAJOR CONTOUR INTERVALS SHOWN FOR CLARITY. SEE WALL PLANS FOR ADDITIONAL INFORMATION.


Know what's **below**. Call before you dig.

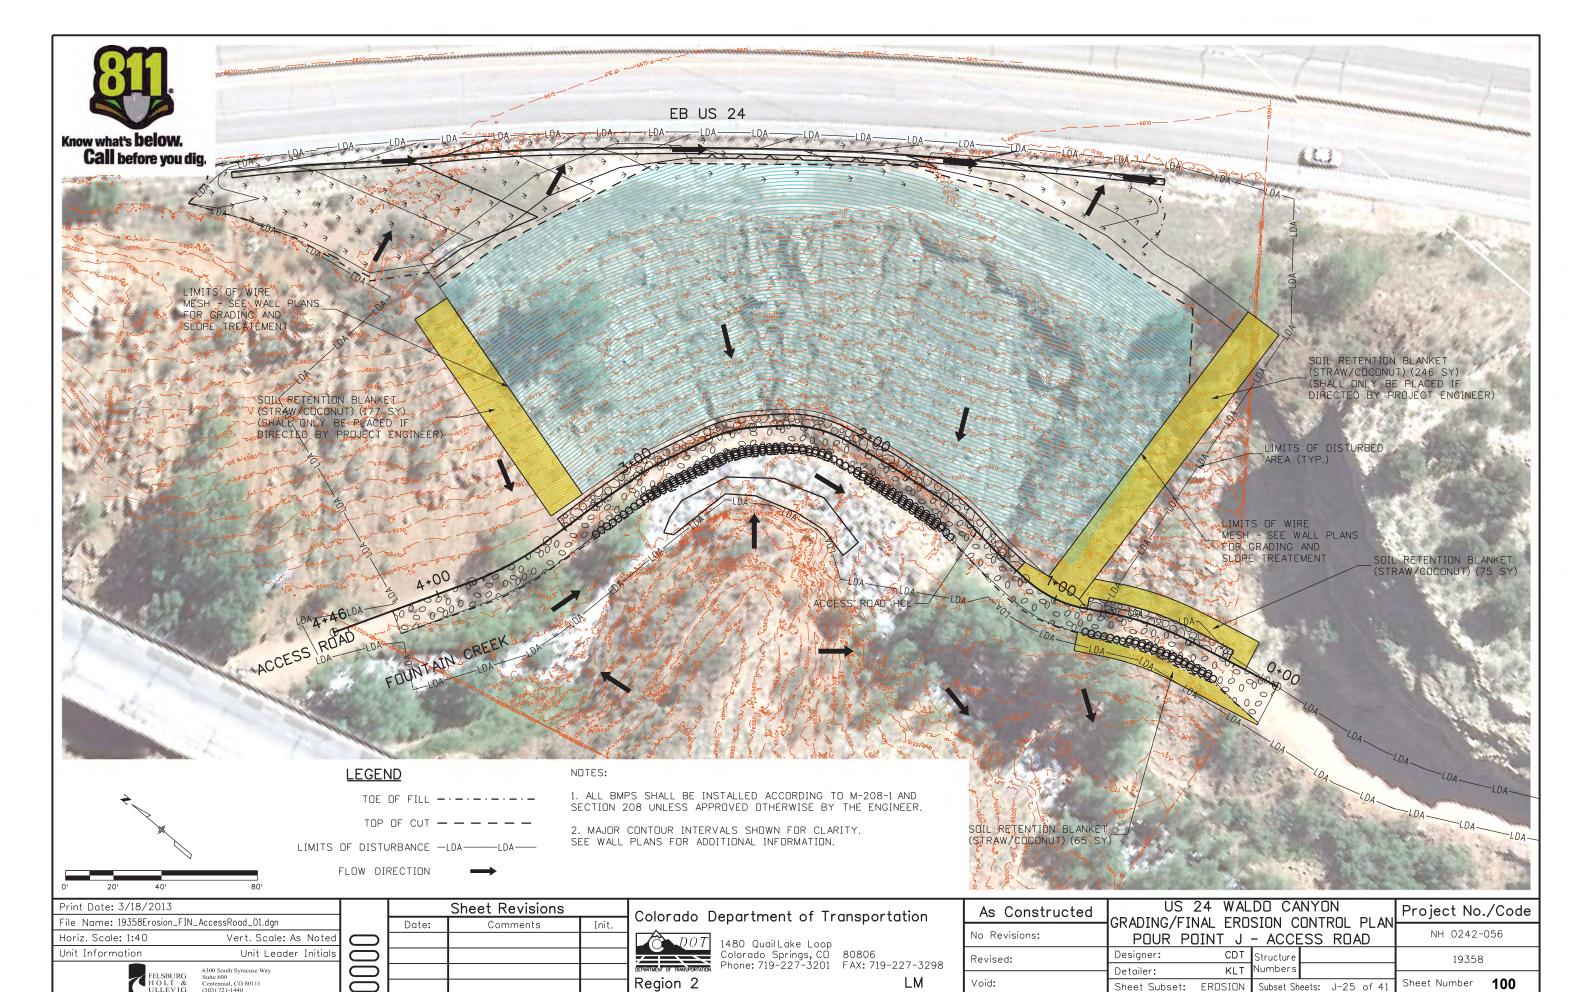

Know what's **below**.

Call before you dig.

EB US 24

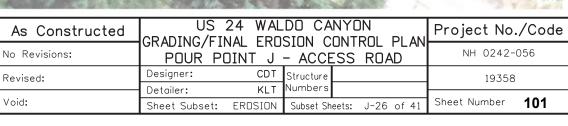


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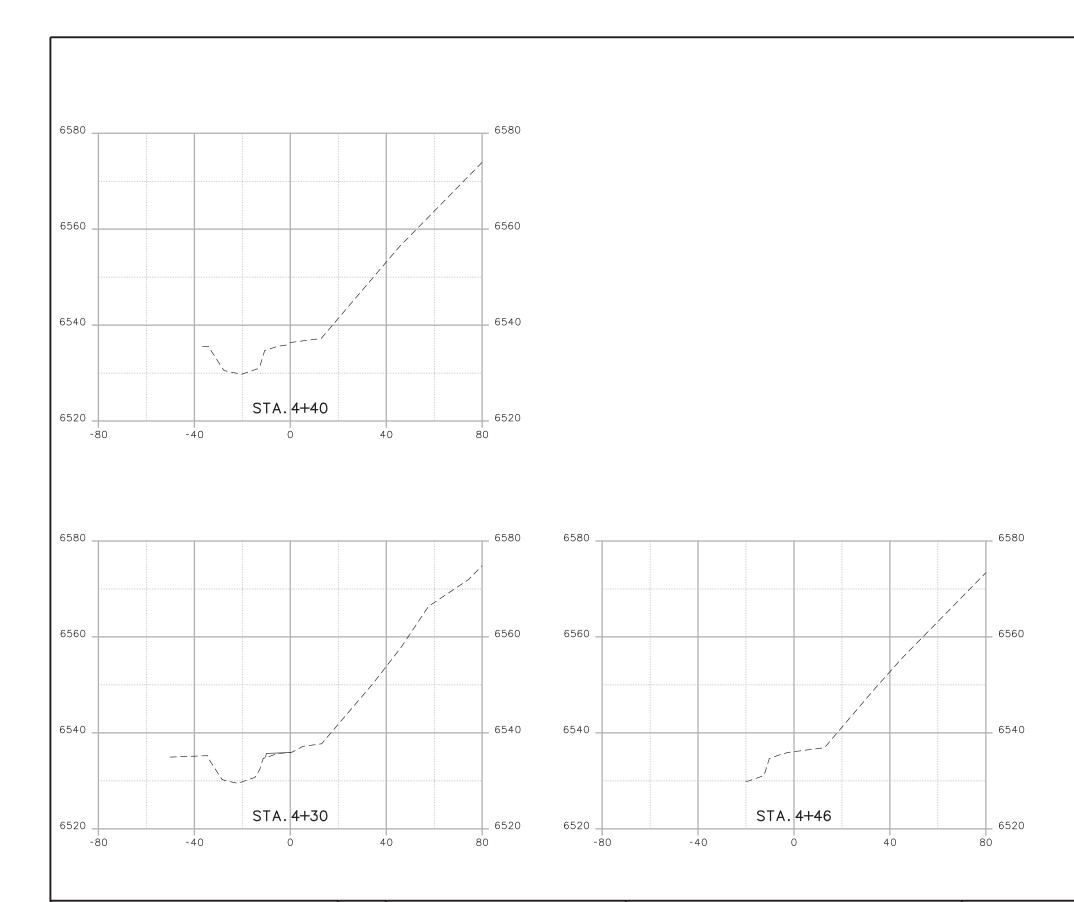
INFORMATION.

1. ALL BMPS SHALL BE INSTALLED ACCORDING TO M-208-1 AND SECTION 208 UNLESS APPROVED OTHERWISE BY THE ENGINEER.

2. MAJOR CONTOUR INTERVALS SHOWN FOR CLARITY. SEE WALL PLANS FOR ADDITIONAL

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Unit Information Unit Leader Initials Designer: CDT	Unit Information Unit Leader Initials Designer: CDT Revised: Designer: CDT Detailer: KLT	Horiz. Scale: 1:40 Vert. Scale: As Noted	(R-X)			
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	O Detailer. Net	-				1

Project No./Code

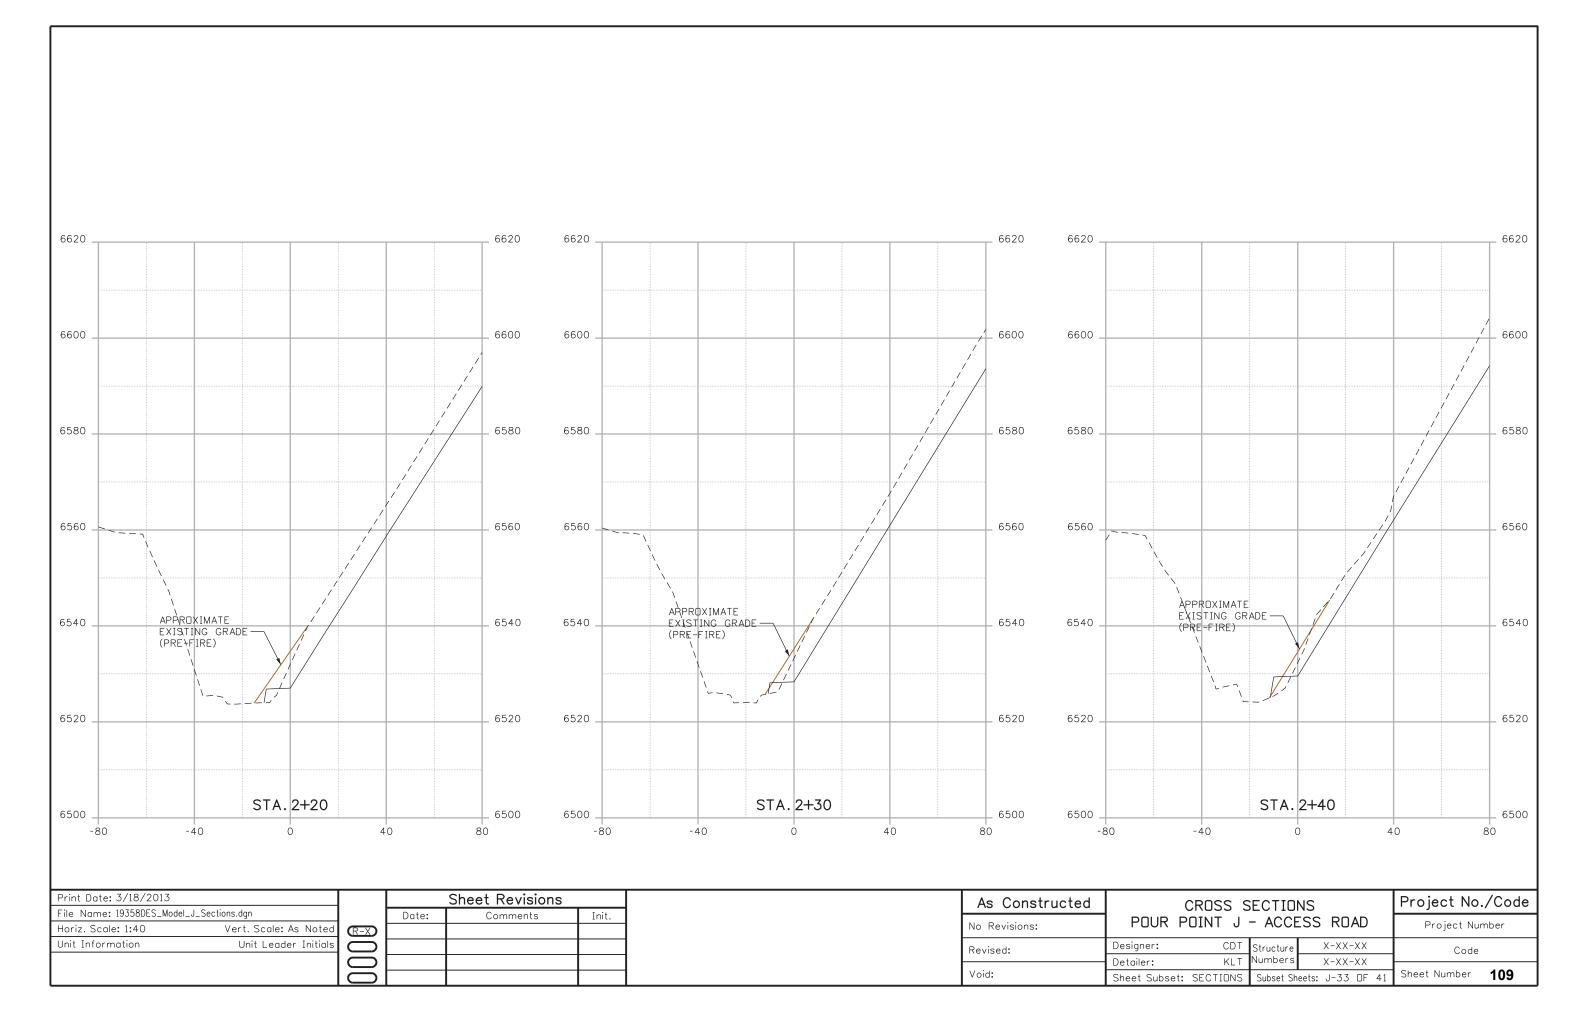Project Number

Code

Sheet Number 116

Phone: (719) 546-5496 FAX: (719) 546-5414

Right of Way Plans Unit: 2152

Sheet Revisions Sheet Revisions Sheet Revisions

COLORADO DEPARTMENT OF TRANSPORTATION Control Diagram Sheet

Project Number: 14173 Project Location: U.S. Hwy. 24

 Project Location:
 Manitou to Cascade

 Project Code:
 Last Mod. Date
 Subset Sheets
 Sheet No.
 Total No. of Sheet


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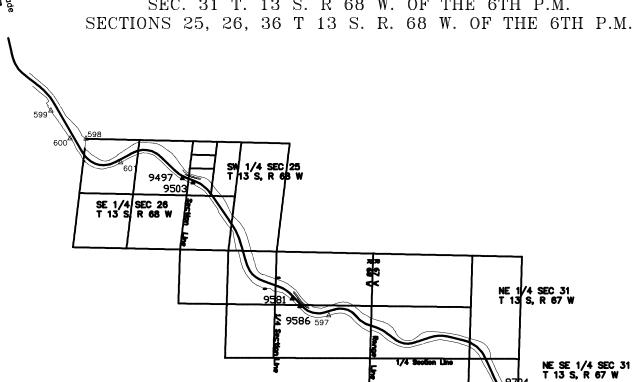
U.S. HIGHWAY 24

IN EL PASO COUNTY

SECTIONS 5, 6 T 14 S. R. 67 W. OF THE 6TH P.M. SEC. 31 T. 13 S. R 68 W. OF THE 6TH P.M.





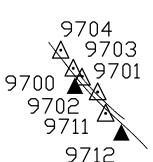

PROJECT COORDINATES

NAME	NORTHING	EASTING	ELEVATION	DESCRIPTION
9581 9712 9503 9700 9497 9586 CDNYERS QUILLEN 9711 9701 9702 9703	381949.066 378731.759 384884.427 379262.309 384994.933 381749.838 401915.887 374992.798 378855.569 379261.637 379096.042	158856.89 164906.292 156340.484 164380.867 156072.267 159044.454 141761.702 168814.069 164769.391 164679.488 164403.557	6992.634 6618.344 7146.085 6625.027 7157.701 6984.54 7924.853 6438.849 6622.303 6620.89 6606.506 6626.13	CDUT Control Monument, 3 1/2' Alum. Cap at M.P. 295.81 CDUT Control Monument, 3 1/2' Alum. Cap at M.P. 297.12 CDUT Control Monument, 3 1/2' Alum. Cap at M.P. 295.03 CDUT Control Monument, 3 1/2' Alum. Cap at M.P. 295.03 CDUT Control Monument, 3 1/2' Alum. Cap at M.P. 294.97 CDUT Control Monument, 3 1/2' Alum. Cap at M.P. 294.97 CDUT Control Monument at M.P. 290.2 NGS Control Monument at M.P. 298.15 CDUT Secondary Control, nall/shiner

[Project Cooordinates (ft) + (northing (1,000,000) or easting (3,000,000) reduction)] x (combined scale factor (0.9996090023) = State Plane Coordinates (ft) (Central Zone - 0502 NAD83)].

QUILLEN A

NE SE 1/4 SEC 31 T 13 S, R 67 W

GEODETIC COORDINATES

NAME	LATITUDE NAD-83	LONGITUDE NAD-83	ELLIPSOID HEIGHT (M)	CONVERGANCE	SCALE FACTOR	NORTHING CO SPC (FT)	EASTING CO SPC (FT)	ORTHO HEIGHT (FT)	NAME	DESCRIPTION
QUILLEN	38ø 51' 36.05163" N	104ø 54' 41.39062" W	1946.554	0ø 22' 16.18481"	0.999944710	1374992.798	3168814.069	6438.849	QUILLEN	NGS CONTROL MONUMENT
9712	38ø 52′ 13.24263 ′ N	104ø 55′ 30.47601″ W	2001.412	0ø 21'45.22716"	0.999943972	1378731.759	3164906.292	6618.343	9712	CDOT TYPE 2 CONTROL MONUMENT
9700	38ø 52′ 18.51767″ N	104ø 55′ 37.07471 ″ W	2003.467	0ø 21'41.06543"	0.999943870	1379262.309	3164380.868	6625.026	9700	CDOT TYPE 2 CONTROL MONUMENT
9586	38ø 52′ 43,42352 ′ N	104ø 56′ 44.33287°W	2113.228	0ø 20' 58.64642"	0.999943397	1381749.838	3159044.455	6984.540	9586	CDOT TYPE 2 CONTROL MONUMENT
9581	38ø 52' 45,40335' N	104ø 56' 46,68849"W	2115.701	0ø 20° 57.16075"	0.999943360	1381949.066	3158856.890	6992,634	9581	CDOT TYPE 2 CONTROL MONUMENT
9503	38ø 53' 14,55730' N	104ø 57' 18.27559" W	2162.559	0ø 20' 37.23910"	0.999942826	1384884.427	3156340.484	7146.085	9503	CDOT TYPE 2 CONTROL MONUMENT
9497	38ø 53' 15,66506' N	104ø 57' 21.65813" W	2166.109	0ø 20° 35.10576"	0.999942806	1384994.933	3156072.267	7157,702	9497	CDOT TYPE 2 CONTROL MONUMENT
CUNYERS	38ø 56′ 03.66464″ N	105ø 00' 21.41541' W	2400.355	0ø 18' 41.73472"	0.999940120	1401915.887	3141761.702	7924.900	CONYERS	NGS CONTROL MONUMENT

GENERAL NOTES

- 1.) This Control Survey Diagram is for the use of the Colorado Department of Transportation. This survey is NOT a complete Land or Right of Way survey, nor is the Control Diagram Sheet a Land or Right of Way Survey Plat.
- 2.) The Control Survey represented by this Control Survey Diagram meets Colorado Department of Transportation minimum horizontal control tolerances for a Type B Survey (+/- 0.25° at a 95% level of certainty).
- 3.) All coordinates listed are based on G.P.S. observations taken in October of 2002.
- 4.) No guarantee as to the accuracy of the information contained hereon is implied or expressed unless this copy bears an original signature and seal of the Professional Land Surveyor certifying this Survey Control

NOTICE: According to Colorado Law you must commence any legal action based upon any defect in this survey within three years after you first discover such defect. In no event may any action based upon any defect in this survey be commenced more than ten years from the date of the certification shown hereon.

BASIS OF BEARING

The basis of bearing for project reference is a line from CDOT Control Monument 9581 to CDOT Control Monument 9586 having a bearing of S 43° 16' 22" E at a distance of 273.63 feet.

SURVEY SYMBOL TABLE

Control Monument / Project

Secondary Monument / Project

SURVEYOR CERTIFICATE

I hereby state that this survey was performed under my supervision and checking, for and on the behalf of the Colorado Department of Transportation, and to the best of my knowledge, the information presented hereon is true and correct.

DAT	E

P.O. Box 536 905 Erie Avenue Pueblo, CO 81002 Phone: 719-546-5438 FAX: 719-54	Colorado Dep	artment of Tran	sportation
Pagian 2	DOT DEPARTMENT OF TRANSPORTATION	905 Erie Avenue Pueblo, CD 81002	FAX: 719-546-
Negion 2	Region 2		TTA

P.O. Box 536 905 Erie Avenue Pueblo, CD 81002 Phone: 719-546-5438 FAX: 719-546-5702

QUARTER, SIXTEENTH,

AND SECTION CORNERS

BENCH MARK

1

RIGHT OF WAY

QUARTER, SIXTEENTH, AND SECTION CORNERS

O USGS

USGS MARKER

⊡

ROW

MARKER

RIGHT OF WAY

●N 10.38 E 3.81 EL 0.00

HIGH ACCURACY REFERENCE

NETWORK CONTROL MONUMENT

MARKER

SECTION CORNER

PROPERTY PIN

⊙ wc

SET FASEMENT

MONUMEN1

⊖ FED

FEDERAL MONUMENT

LOCAL OR PLSS

MONUMENT

PROJECT CONTROL

ACCESS CONTROL LINE

RIGHT OF WAY LINE

BARRIER ACCESS CONTROL LINE

CITY LIMIT LINE (EXISTING)

CDUNTY LINE (EXISTING)

QUARTER SECTION LINE

SIXTEENTH SECTION LINE

TOWNSHIP LINE (EXISTING)

STATE LINE (EXISTING)

SECTION LINE

TOP OF CUT

TOE OF FILL

VIRGIN RIGHT OF WAY LINE (PROPOSED)

MONUMENT

▲ N 9.88 E 3.81 EL 0.00

BLM MARKER

1

TEMPORARY

EASEMENT POINT

WC

SECONDARY CONTROL

SURVEY/ROW

TERRAIN

MONUMENT

WITNESS CORNER

N 10.13
 E 3.81
 EL 0.00

DENSIFICATION

PERMANENT, PROPERTY, SLOPE, & UTILITY EASEMENT LINE

—P ——

PROPERTY BOUNDARY LINE (EXISTING AND PROPOSED)

TEMPORARY EASEMENT LINE (EXISTING)

CONTROL MONUMENT

O NOAA

NOAA MARKER

TTA

Sheet Revisions Sheet Revisions

Sheet Revisions Farnsworth LORADO SPRINGS, COLORADO 80 19) 590-9194 / (719) 590-9111 Fa

EA-4


EA-5

	RI RI	<u>.GHIUFWA</u>	<u>Y</u>					
Title Sheet								
roject Number: NH 0242-056								
Project Location: U.S. 24 Fire Mitigation - Cascade								
EL PASO COUNTY, COLORADO								
oject Code:	Last Mod. Date	Subset	Sheet No.	Sheet Total				
19358	03-06-13	1.00 of 1.00	1.00	13				

DEPARTMENT OF TRANSPORTATION STATE OF COLORADO

RIGHT OF WAY PLANS OF PROPOSED PROJECT NO. NH 0242-56 STATE HIGHWAY NO. 24 EL PASO COUNTY

Lineal Units = U.S. Survey Feet

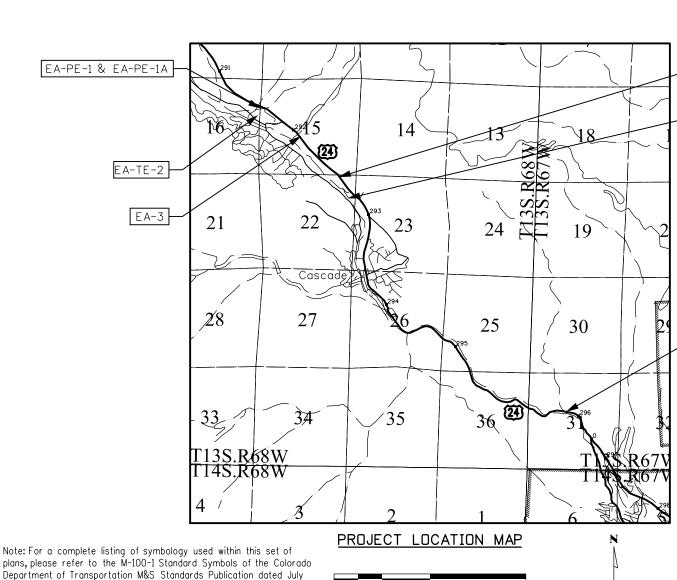

2006. Existing features are shown as screened weight (gray scale), except as noted with the word (existing). Proposed or new features

are shown as full weight without screening, except as noted with the

word (proposed).

SHEET NO. INDEX OF SHEETS

Title Sheet 1.01-1.02 (2) Exhibit EA-PE-1 & EA-PE-1A 2.01-2.02 (2) Exhibit EA-TE-2 3.01-3.02 (2) Exhibit EA-3 4.01-4.02 (2) Exhibit EA-4 5.01-5.02 (2) Exhibit EA-5 6.01-6.02 (2) Exhibit EA-PE-6 & EA-TE-6

(13) Total Sheets

Scales of Original 11x17 Drawings Plan Sheets 1"=100" Ownership Map 1"=1000"

Basis of Bearings: Bearings are Colorado State Plane, Central Zone, NAD 83/92, based on a line between NGS station "CONYERS" PID - JK1354, a steelrod encased in PVC with NGS logo cap set in 1.6' concrete post near mile post 290.2, and NGS station "QUILLEN" PID - JK1385, a drill hole in sandstone near mile post 298.15. Said line bears S45°08'14"E per CDOT control diagram for project number 14173.See www.ngs.noaa.gov for data sheets containing detailed location information

- 1. This Right-of-Way Plan is not a boundary survey of the adjoining property and is prepared for the Colorado Department of Transportation purposes only.
- 2. For title information, The Colorado Department of Transportation relied on Title Commitments prepared by H. C. Peck & Associates.
- 3. This plan set is subject to change and may not be the most current set. It is the user's responsibility to verify with CDOT that this set is the most current. The information contained on the attached drawing is not valid unless this copy bears an original signature of the Professional Land Surveyor hereon named.

NOTICE: According to Colorado law you must commence any legal action based upon any defect in this survey within three years after you first discover such defect. In no event may any action based upon any defect in this survey be commenced more than ten years from the date of the certification shown hereon.



SURVEYOR STATEMENT (R.O.W. MONUMENTS)

Fredrick L. Easton , a professional land surveyor licensed in the State of Colorado, do hereby state to the Colorado Department of Transportation that based upon my knowledge, information and belief, adequate research, calculations and evaluation of survey evidence were performed and the Right-of-Way monuments depicted on this Right-of-Way Plan were set under my responsible charge in accordance with applicable standards of practice defined by Colorado Department of Transportation publications. This statement is not a guaranty or warranty, either expressed or implied.

PLS No. 37948

EA-PE-6 & EA-TE-6

ORADO LICENS 1 PROPERTY ON ALL LANDS

DAY OF . . . 20_____ OF THE COUNTY LAND SI______ . RECEPTION NU FILING CERTIFICATION:
DEPOSITED THIS _____
IN BOOK _______ C
SURVEYS AT PAGE _____

_	nom
	DOT

P.O. Box 536 905 Erie Avenue Pueblo, CO 81002 Phone: 719-546-5438 FAX: 719-546-5702

Sheet Revisions			Sheet Revisions
Description	Initials	Date	Description

Sheet Revisions			
Description	Initials	Farnsworth	
		Farnsworth GROUP	F
		4755 FORGE ROAD, SUITE 150	F
		COLORADO SPRINGS, COLORADO 80907 (719) 590-9194 / (719) 590-9111 Fax	Г

RIGHT OF WAY

EXHIBIT EA-PE-1 & EA-PE-1A


Project Number: NH 0242-056

Project Location: U.S. 24 Fire Mitigation - Cascade

EL PASO COUNTY, COLORADO

Project Code: Last Mod. Date Subset Sheet No. Sheet Total

Region 2

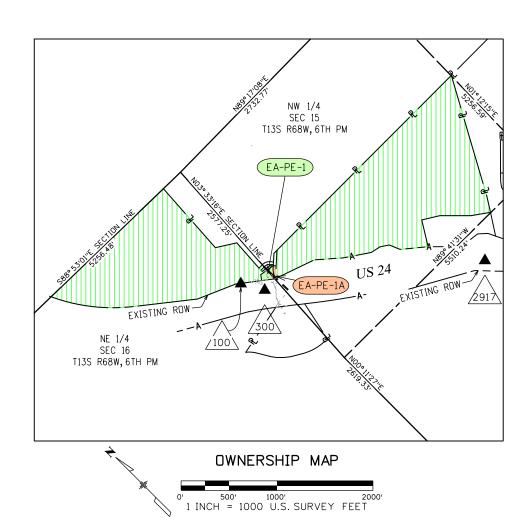

	PROJECT CONTROL TABLE											
Point No. Project Coordinates		Elev(ft)										
Point No.	Northing(ft)	Easting(ft)	(NAVD88)	Description								
100	397916.25	145713.32	7654.78	18" #5 REBAR W/RPC "FARNSWORTH CONTROL POINT"								
300	397692.95	145841.94	7650.50	MAG. NAIL IN ASPHALT SHOULDER OF HWY 24								
2917	147683.17	396289.12	7477.22	C.D.O.H. C.M. M.P. 291.7								
CONYERS	401915.89	141761.70	7924.85	SMOOTH STEEL ROD IN LOGO BOX 'CONYERS 1991'								
QUILLEN	374992.80	168814.07	6438.85	3 25IN DIA BRASS CAP IN STONE OURCROPING 'QUILLEN 1992'								

SECTIONS 15 & 16 T13S, R68W, 6TH PM EL PASO COUNTY, CO

General Notes:

- 1. This Right-of-Way Exhibit is not a complete boundary survey of all adjoining owners and is prepared for the Colorado Department of Transportation purposes only.
- 2. Notice: According to Colorado law, you must commence any legal action based upon any defect in this survey within three years after you first discover such defect. In no event may any action based upon such defect in this survey be commenced more than ten years from the date of certification hereon.
- 3. Existing right-of-way lines were established using CDDT Project No. F024-2(1) Sec. 1 Right-of-Way Plans. Aliquot section corners and lines are per CDDT Control Diagram Sheet for Project CX 04-0024-45.
- 4. For title information Farnsworth Group, Inc. relied on title commitments prepared by H. C. Peck and Associates.

CODRDINATE DATUM: Project coordinates are modified Colorado State Plane Central Zone NAD '83/(92) coordinates. The combined elevation/scale factor used to modify the coordinates from state plane to project coordinates is 1.0003911506. The resulting project coordinates are truncated by 3,000,000sft in the Northing and 1,000,000sft in the Easting after converting from state plane coordinates to project coordinates. The CHARN is based on the NAD '83(92) datum.

Project Coordinates Northing US Survey Feet = (State Plane Coordinate Northing * 1.0003911506 - 3,000,000) * (3937/1200).

Project Coordinates Easting US Survey Feet = (State Plane Coordinate Easting * 1.0003911506 - 1,000,000) * (3937/1200).

Basis of Elevations: Project elevations are based on NAVD 88 values published on the CDDT Control Diagram Sheet, Project No. 141173, dated Feb 19, 2003.

PROPERTY ONLL LAND SHE

	R.O.W. TABULATION OF PROPERTIES IN EL PASO COUNTY - U.S. NO. 24										
				The second	Area I	n Square Fee	et (Acres)		Book and Page No. And/Or	Title Commitment	Remarks
Parcel No.	Ownership Name and Mailing Address	Site Address	Location T-13-S R-68-W, 6TH PM	Area Of Parcel	Existing ROW	Net Area	Remainder Left	Remainder Right	Reception No.	No.	
EA-PE-1	TWIN ROCKS INVESTMENT GROUP, LLC,		SECTIONS 15 & 16	13,552 SQ FT				337,324 SQ FT		05490A2013	for the purpose of construction and
	A COLORADO LIMITED LIABILITY COMPANY			(0.311 AC)			-	(77.439 AC)	The state of		maintenance of drainage structures
EA-PE-1A	6225 WELLINGTON GULCH		SECTION 15	3,910 SQFT				346966 SQ FT	1	1	for ingress and egress
	CASCADE, CO 80809			(0.090 AC)				(77.660 AC)			

Region 2


P.O. Box 536 905 Erie Avenue Pueblo, CD 81002 Phone: 719-546-5438 FAX: 719-546-5702

	Sheet Revisions			Sheet Revisions			Sheet Revisions
е	Description	Initials	Date	Description	Initials	Date	Description
5-13	Revised Design References	SDP					

Farnsworth 55 FORGE ROAD, SUITE 150 DLORADO SPRINGS, COLORADO 80º

RIGHT OF WAY EXHIBIT EA-PE-1 & AE-PE-1A Project Number: NH 0242-056 Project Location: U.S. 24 Fire Mitigation - Cascade

EL PASO COUNTY, COLORADO 19) 590-9194 / (719) 590-9111 Fax

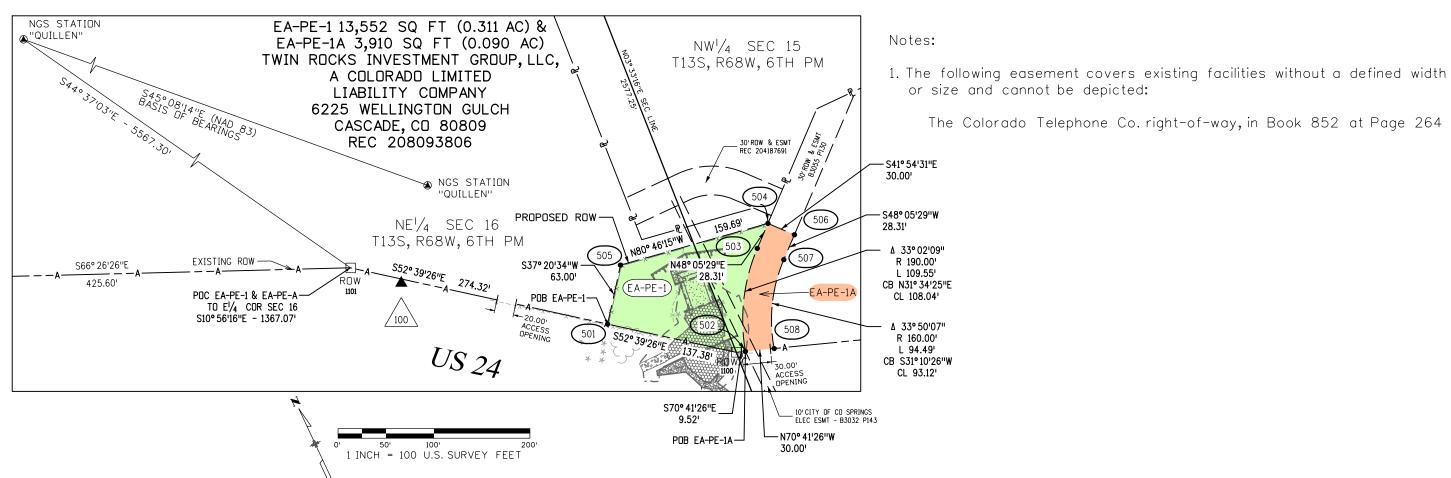

FOUND R.O.W. MONUMENT COORDINATE TABLE Easting(ft) Description

1.5" AL CAP - LS 12043

1.5" AL CAP - LS 12043

ROW

Point No.

1100

1101

Northing(ft)

397703.28

397952.90

TABULATION OF PERMANENT EASEMENT MONUMENTS TO BE SET					
Point No.	Northing(ft)	Easting(ft)	Description		
501	397786.62	145890.09	CDOT TYPE VI MONUMENT		
502	397700.14	146008.30	CDOT TYPE VI MONUMENT		
503	397792.18	146064.87	CDOT TYPE VI MONUMENT		
504	397811.09	146085.93	CDOT TYPE VI MONUMENT		
505	397836.70	145928.31	CDOT TYPE VI MONUMENT		
506	397788.77	146105.97	CDOT TYPE VI MONUMENT		
507	397769.86	146084.90	CDOT TYPE VI MONUMENT		
508	397690.18	146036.70	CDOT TYPE VI MONUMENT		

145999.32


145672.15

Basis of Bearings: Bearings are Colorado State Plane, Central Zone, NAD 83/92, based on a line between NGS station "CONYERS" PID - JK1354, a steelrod encased in PVC with NGS logo cap set in 1.6' concrete post near mile post 290.2, and NGS station "QUILLEN" PID - JK1385, a drill hole in sandstone near mile post 298.15. Said line bears \$45° 08'14"E per CDOT control diagram for project number 14173.

See www.ngs.noaa.gov for data sheets containing detailed location information.

SURVEYOR STATEMENT (R.O.W. MONUMENTS)

Fredrick L. Easton , a professional land surveyor licensed in the State of Colorado, do hereby state to the Colorado Department of Transportation that based upon my knowledge, information and belief, adequate research, calculations and evaluation of survey evidence were performed and the Right-of-Way monuments depicted on this Right-of-Way Plan were set under my responsible charge in accordance with applicable standards of practice defined by Colorado Department of Transportation publications. This statement is not a quaranty or warranty, either expressed or implied.

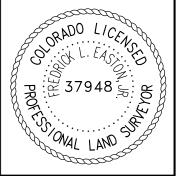

DOT

P.O. Box 536 905 Erie Avenue Pueblo, CO 81002 Phone: 719-546-5438 FAX: 719-546-5702

	Sheet Revisions			Sheet Revisions	
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Sheet Revisions

Description

Initials

Farnsworth

GROUP


COLORADO SPRINGS, COLORADO 80907

19) 590-9194 / (719) 590-9111 Fa

Project Code: Lost Mod. Date

Projec

Region 2

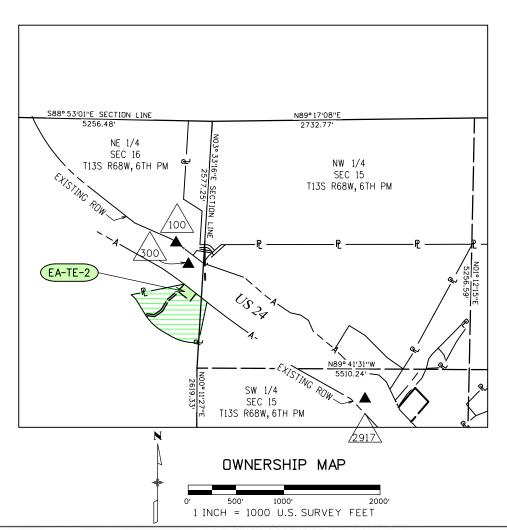

	PROJECT CONTROL TABLE						
Point No.	Project Coordinates		Elev(ft)				
	Northing(ft)	Easting(ft)	(NAVD88)	Description			
100	397916.25	145713.32	7654.78	18" #5 REBAR W/RPC "FARNSWORTH CONTROL POINT"			
300	397692.95	145841.94	7650.50	MAG. NAIL IN ASPHALT SHOULDER OF HWY 24			
2917	147683.17	396289.12	7477.22	C.D.O.H. C.M. M.P. 291.7			
CONYERS	401915.89	141761.70	7924.85	SMOOTH STEEL ROD IN LOGO BOX'CONYERS 1991'			
QUILLEN	374992.80	168814.07	6438.85	3.25IN DIA BRASS CAP IN STONE OURCROPING 'QUILLEN 1992'			

SECTION 16 T13S, R68W, 6TH PM EL PASO COUNTY, CO

General Notes:

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- 3. Existing right-of-way lines were established using CDOT Project No. F024-2(1) Sec. 1 Right-of-Way Plans. Aliquot section corners and lines are per CDOT Control Diagram Sheet for Project CX 04-0024-45.
- 4. For owner information Farnsworth Group, Inc. relied on documents provided by H. C. Peck and Associates.

CODRDINATE DATUM: Project coordinates are modified Colorado State Plane Central Zone NAD '83/(92) coordinates. The combined elevation/scale factor used to modify the coordinates from state plane to project coordinates is 1.0003911506. The resulting project coordinates are truncated by 3,000,000sft in the Northing and 1,000,000sft in the Easting after converting from state plane coordinates to project coordinates. The CHARN is based on the NAD '83(92) datum.

Project Coordinates Northing US Survey Feet = (State Plane Coordinate Northing * 1.0003911506 - 3,000,000) * (3937/1200).

Project Coordinates Easting US Survey Feet = (State Plane Coordinate Easting * 1.0003911506 - 1,000,000) * (3937/1200).

Basis of Elevations: Project elevations are based on NAVD 88 values published on the CDOT Control Diagram Sheet, Project No. 141173, dated Feb 19, 2003.

R.O.W. TABULATION OF PROPERTIES IN EL PASO COUNTY - U.S. NO. 24 **Book and Page** Title Area In Square Feet (Acres) No. And/Or Commitment Remarks Ownership Name and Mailing Location Parcel No. Site Address Reception No. No. T-13-S R-68-W, 6TH PM Existing Remainder Remainder Address Net Area Area Of Parcel ROW Right Left SCHOOL DISTRICT NO 14 9230 CHIPITA PARK RD 25,163 SQ FT AE-TE-2 **SECTION 16** FOR CONSTRUCTION OF OUTLET PROTECTION 405 EL MONTE PL (05.578 AC) FOR EXISTING BOX CULVERT MANITOU SPRINGS, CO 80829-2502

3/6/2013 sparker 12:20:36 PM P:\2012\01214

P.O. Box 536 905 Erie Avenue Pueblo, CO 81002 Phone: 719-546-5438 FAX: 719-546-5702

	Sheet Revisions			Sheet Revisions		
)ate	Description	Initials	Date	Description	Initials	Г
-06-13	Revised Design Reference	SDP				

Sheet Revisions

Description

Initials

Sheets

GROUP


4755 FORGE ROAD, SUITE 150

COLORADO SPRINGS, COLORADO 80907
(7/19) 590-9194 / (7/19) 590-9111 Fox

Project Code: Last Mod. Date Subset Sheet No. Sheet Total

Region 2

	POI E!/4 C S08° 39'46"E	A 0° 21'32" R 5604.1' L 35.09' CB S52° 45'43"E CL 35.09' OR SEC 16 - 884.55' N40° 14'32"E 41.80' R 615	
N53° 32'35"E 24.09'	NE 1/4 SEC 16 T13S, R68W, 6TH PM N55° 23'24"E 87.98' 12'06'E 69.66'	605	602 602 8 AC)
A 2°14'41" R 511.15' L 20.02' CB N33° 40'48"W CL 20.02'	611 612 606 606 606 607 N81° 12′06″W 69.28″	405 EL MONTE P MANITOU SPRINGS, CO 808 REC 493165	

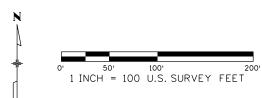

Basis of Bearings: Bearings are Colorado State Plane, Central Zone, NAD 83/92, based on a line between NGS station "CONYERS" PID - JK1354, a steelrod encased in PVC with NGS logo cap set in 1.6' concrete post near mile post 290.2, and NGS station "QUILLEN" PID - JK1385, a drill hole in sandstone near mile post 298.15. Said line bears S45° 08'14"E per CDOT control diagram for project number 14173. See www.ngs.noaa.gov for data sheets containing detailed location information.

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XXX	


Point No.	Northing(ft)	Easting(ft)	Description
601	397485.24	145798.17	
602	397388.69	145922.20	
603	397309.98	145860.52	
604	397402.57	145742.37	
605	397314.40	145638.71	
606	397203.03	145571.00	
607	397146.11	145488.53	
608	397156.71	145420.06	
609	397146.77	145406.61	
610	397163.43	145395.50	
611	397177.75	145414.88	
612	397167.09	145483.72	
613	397217.06	145556.13	
614	397327.54	145623.30	
615	397453.33	145771.17	

⊙ XXX

TABULATION OF Calculated Points						
Point No.	Northing(ft)	Easting(ft)	Description			
905	397464.00	145826.11				

SURVEYOR STATEMENT (R.O.W. MONUMENTS)

I, Fredrick L. Easton, a professional land surveyor licensed in the State of Colorado, do hereby state to the Colorado Department of Transportation that based upon my knowledge, information and belief, adequate research, calculations and evaluation of survey evidence were performed and the Right-of-Way monuments depicted on this Right-of-Way Plan were set under my responsible charge in accordance with applicable standards of practice defined by Colorado Department of Transportation publications. This statement is not a guaranty or warranty, either expressed or implied.

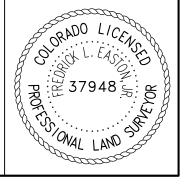

PLS No. 37948

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DOT

P.O. Box 536 905 Erie Avenue Pueblo, CO 81002 Phone: 719-546-5438 FAX: 719-546-5702

ı		Sheet Revisions			Sheet Revisions	
Date	Initials	Description	Date	Initials	Description	:
	-					

Sheet Revisions			
Description	Initials	BOOMERS Farncy Orth	
		Farnsworth SCENISS GROUP	Pro
		4755 FORGE ROAD, SUITE 150 COLORADO SPRINGS, COLORADO 80907	Pro
	l	(719) 590-9194 / (719) 590-9111 Fax	

RIGHT OF WAY

EXHIBIT EA-3

Project Number: NH 0242-056


Project Location: U.S. 24 Fire Mitigation - Cascade

EL PASO COUNTY, COLORADO

Project Code: Last Mod. Date Subset Sheet No. Sheet Total

Region 2

SECTION 15 T13S, R68W, 6TH PM EL PASO COUNTY, CO

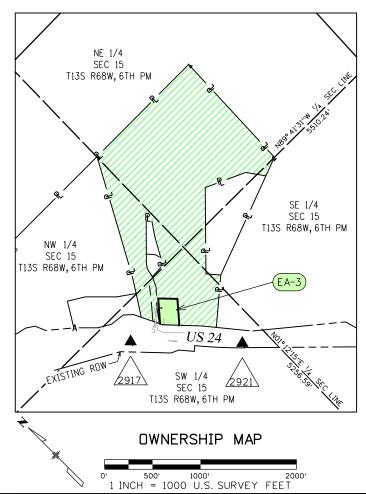

	PROJECT CONTROL TABLE							
Point No.	Project Coordinates		⊟ev(ft)	Description				
Point No.	Northing(ft)	Easting(ft)	(NAVD88)	Description				
2917	396289.12	147683.17	7477.22	C.D.O.H. C.M. M.P. 291.7				
2921	395454.64	148495.48	7468.19	C.D.O.H. C.M. M.P. 292.1				
CONYERS	401915.89	141761.70	7924.85	SMOOTH STEEL ROD IN LOGO BOX'CONYERS 1991'				
QUILLEN	374992.80	168814.07	6438.85	3.25IN DIA BRASS CAP IN STONE OURCROPING QUILLEN 1992				

General Notes:

- 1. This Right-of-Way Exhibit is not a complete boundary survey of all adjoining owners and is prepared for the Colorado Department of Transportation purposes only.
- 2. Notice: According to Colorado law, you must commence any legal action based upon any defect in this survey within three years after you first discover such defect. In no event may any action based upon such defect in this survey be commenced more than ten years from the date of certification hereon.
- 3. Existing right-of-way lines were established using CDOT Project No. F024-2(1) Sec. 1 Right-of-Way Plans. Aliquot section corners and lines are per CDOT Control Diagram Sheet for Project CX 04-0024-45.
- 4. For title information Farnsworth Group, Inc. relied on title commitments prepared by H. C. Peck and Associates.

COURDINATE DATUM: Project coordinates are modified Colorado State Plane Central Zone NAD '83/(92) coordinates. The combined elevation/scale factor used to modify the coordinates from state plane to project coordinates is 1.0003911506. The resulting project coordinates are truncated by 3,000,000sft in the Northing and 1,000,000sft in the Easting after converting from state plane coordinates to project coordinates. The CHARN is based on the NAD '83(92) datum.

Project Coordinates Northing US Survey Feet = (State Plane Coordinate Northing * 1.0003911506 - 3,000,000) * (3937/1200).

Project Coordinates Easting US Survey Feet = (State Plane Coordinate Easting * 1.0003911506 - 1,000,000) * (3937/1200).

Basis of Elevations: Project elevations are based on NAVD 88 values published on the CDOT Control Diagram Sheet, Project No. 141173, dated Feb 19, 2003.

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3/6/2013	

	R.O.W. TABULATION OF PROPERTIES IN EL PASO COUNTY - U.S. NO. 24						L. 100.244	2.00			
Used	Ownership Name and Mailing		Location T-13-S R-68-W, 6TH PM	Area In Square Feet (Acres)					Book and Page No. And/Or	Title Commitment	Remarks
Parcel No.	Address	Site Address		Area Of Parcel	Existing ROW	Net Area	Remainder Left	Remainder Right	Reception No.	No.	
EA-3	KAHLM, LLC, A COLORADO										
	LIMITED LIABILITY COMPANY		SECTION 15	54,839 SQ FT				2,525,483 SQ FT		05489A2013	
1	5975 WELLINGTON RD			(1.259 AC)				(57.977 AC)			
	CASCADE, CO 80809-1025										

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P.O. Box 536 905 Erie Avenue Pueblo, CO 81002 Phone: 719-546-5438 FAX: 719-546-5702

	Sheet Revisions			Sheet Revisions		
te	Description	Initials	Date	Description	Initials	
6-13	Revised Design References	SDP				
6-13	Added Water WellLocation	SDP				
						ıL


Project Location: U.S. 24 Fire Mitigation - Cascade

EL PASO COUNTY, COLORADO

Project Code: Last Mod. Date Subset Sheet No. Sheet Total

RIGHT OF WAY

Region 2

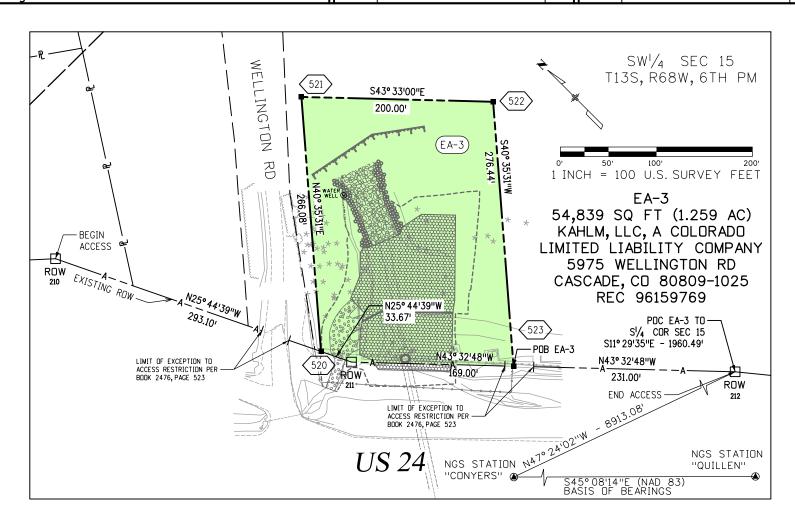

	\cdot
R	nw

	FOUND R.O.W. MONUMENT COORDINATE TABLE							
Point No.	Northing(ft)	Easting(ft)	Description					
210 147905.17		396467.07	FND. CDOT ROW MON W/ 3 1/4" ALUM. CAP					
211	148047.07	396172.82	FND. CDOT ROW MON W/ 3 1/4" ALUM. CAP					
212	148322.66	395882.87	FND. CDOT ROW MON W/ 3 1/4" ALUM. CAP					



	TABULATION OF R.O.W. MONUMENTS TO BE SET								
Point No.	Northing(ft)	Easting(ft)	Description						
520	396203.15	148032.44	CDOT TYPE I MONUMENT						
521	396405.20	148205.57	CDOT TYPE I MONUMENT						
522	396260.25	148343.37	CDOT TYPE I MONUMENT						
523	396050.32	148163.50	CDOT TYPE I MONUMENT						

Notes:

Sheet Revisions


- 1. The exact location and type of right-of-way of Wellington Road is unknown at this time. Vesting deeds reference Book 601, Page 457 which is illegible in many areas and Book 123, Page 65 which does not exist according to the Title Commitment. The approximate right-of-way line based on fences and utilities is shown.
- 2. Easement for waterline in Book 3534, Page 225 adjacent to Wellington Road cannot be depicted as no width has been designated.
- 3. Easement for Plateau Natural Gas Company in Book 1994, Page 289 along the northerly side of Highway 24 cannot be depicted as no width has been designated.
- 4. Easement for Colorado Telephone Co. in Book 358, Page 577 cannot be depicted as no specific location has been noted.

Basis of Bearings: Bearings are Colorado State Plane, Central Zone, NAD 83/92, based on a line between NGS station "CONYERS" PID - JK1354, a steel rod encased in PVC with NGS logo cap set in 1.6' concrete post near mile post 290.2, and NGS station "QUILLEN" PID - JK1385, a drill hole in sandstone near mile post 298.15. Said line bears S45° 08'14"E per CDOT control diagram for project number 14173.

See www.ngs.noaa.gov for data sheets containing detailed location information.

SURVEYOR STATEMENT (R.O.W. MONUMENTS)

I, Fredrick L. Easton , a professional land surveyor licensed in the State of Colorado, do hereby state to the Colorado Department of Transportation that based upon my knowledge, information and belief, adequate research, calculations and evaluation of survey evidence were performed and the Right-of-Way monuments depicted on this Right-of-Way Plan were set under my responsible charge in accordance with applicable standards of practice defined by Colorado Department of Transportation publications. This statement is not a guaranty or warranty, either expressed or implied.

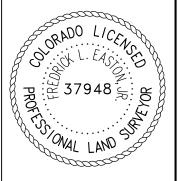



P.O. Box 536 905 Erie Avenue Pueblo, CO 81002 Phone: 719-546-5438 FAX: 719-546-5702

	Sheet Revisions			Sheet Revisions		
9	Description	Initials	Date	Description	Initials	Dat
						-

Initials	Farnsworth	
	SCIENTISS GROUP	Pr
	4755 FORGE ROAD, SUITE 150 COLORADO SPRINGS, COLORADO 80907	Pr
	(719) 590-9194 / (719) 590-9111 Fax	

RIGHT OF WAY
EXHIBIT EA-4


Project Number: NH 0242-056

Project Location: U.S. 24 Fire Mitigation - Cascade
EL PASO COUNTY, COLORADO

Project Code: Last Mod. Date Subset Sheet No. Sheet Total

Region 2

SECTION 15 T13S, R68W, 6TH PM EL PASO COUNTY, CO

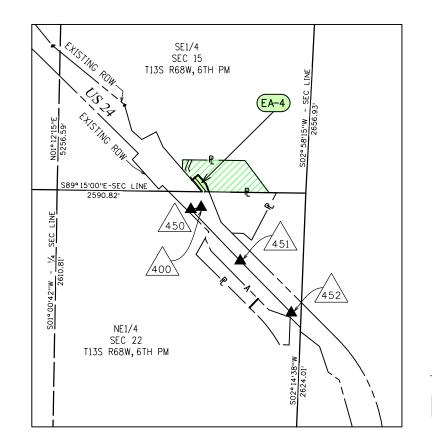



	PROJECT CONTROL TABLE									
Point No.	Project Co	oordinates	⊟ev(ft)	Description						
POINT NO.	Northing(ft)	Easting(ft)	(NAVD88)	Description						
400	393870.32	150213.02	7519.56	MAG NAIL						
450	393758.48	150106.52	7523.40	MAG NAIL IN ASPHALT SHOULDER OF HWY 24						
451	393221.94	150621.04	7482.85	18" #5 REBAR W/RPC "FARNSWORTH CONTROL POINT"						
452	392679.37	151152.33	7479.74	18" #5 REBAR W/RPC "FARNSWORTH CONTROL POINT"						
CONYERS	401915.89	141761.70	7924.85	SMOOTH STEEL ROD IN LOGO BOX'CONYERS 1991'						
QUILLEN	374992.80	168814.07	6438.85	3.25IN DIA BRASS CAP IN STONE OURCROPING 'QUILLEN 1992'						

General Notes:

Sheet Revisions


- 1. This Right-of-Way Exhibit is not a complete boundary survey of all adjoining owners and is prepared for the Colorado Department of Transportation purposes only.
- 2. Notice: According to Colorado law, you must commence any legal action based upon any defect in this survey within three years after you first discover such defect. In no event may any action based upon such defect in this survey be commenced more than ten years from the date of certification hereon.
- 3. Existing right-of-way lines were established using CDOT Project No. F024-2(1) Sec. 1 Right-of-Way Plans. Aliquot section corners and lines are per CDOT Control Diagram Sheet for Project CX 04-0024-45.
- 4. For title information Farnsworth Group, Inc. relied on title commitments provided by H. C. Peck and Associates.

CODRDINATE DATUM: Project coordinates are modified Colorado State Plane Central Zone NAD '83/(92) coordinates. The combined elevation/scale factor used to modify the coordinates from state plane to project coordinates is 1.0003911506. The resulting project coordinates are truncated by 3,000,000sft in the Northing and 1,000,000sft in the Easting after converting from state plane coordinates to project coordinates. The CHARN is based on the NAD '83(92) datum.

Project Coordinates Northing US Survey Feet = (State Plane Coordinate Northing * 1.0003911506 - 3,000,000) * (3937/1200).

Project Coordinates Easting US Survey Feet = (State Plane Coordinate Easting * 1.0003911506 - 1,000,000) * (3937/1200).

Basis of Elevations: Project elevations are based on NAVD 88 values published on the CDDT Control Diagram Sheet, Project No. 141173, dated Feb 19, 2003.

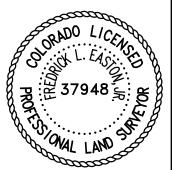

	R.O.W. TABULATION OF PROPERTIES IN EL PASO COUNTY - U.S. NO. 24								200000000000000000000000000000000000000		
3	Oursella Name and Mailing		1		Area I	n Square Fee	et (Acres)	Book and Page No. And/Or	Title Commitment	Remarks	
Parcel No.	Ownership Name and Mailing Address	Site Address	Location T-13-S R-68-W, 6TH PM	Area Of Parcel	Existing ROW	Net Area	Remainder Left	Remainder Right	Reception No.	No.	
EA-4	ANTONI POGERZELSKI &								1		
	LIDIA POGERZELSKI		SE1/4 SEC 15	15,086 SQ FT				218,553 SQ FT		05491A2013	
	8989 W BUSINESS 83			(0.346 AC)				(5.017 AC)			
	HARLINGEN, TX 78552-2283										

P.O. Box 536 905 Erie Avenue Pueblo, CO 81002 Phone: 719-546-5438 FAX: 719-546-5702

	Sheet Revisions			Sheet Revisions		l
ate	Description	Initials	Date	Description	Initials	П
06-13	Revised Design References	SDP				

Sheet Revisions

Description
Initials

Sheet Revisions

Farnsworth

GROUP

4755 FORGE ADD, SUITE 150

COLORADO SPRINGS, COLORADO 80907

(719) 590-9194 / (719) 590-9111 Fax

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h		Ε	XHIBIT EA-4	1		
Project Number: NH 0242-056						
30907	Project Lo	Cascade	9			
30907	EL PASO COUNTY, COLORADO					
	Project Code:	Last Mod. Date	Subset	Sheet No.	Sheet Total	
	19358	03-06-13	4 02 of 4 02	4.02	13	

Region 2

1 INCH = 100 U.S. SURVEY FEET SE1/4 SEC 15 T13S, R68W, 6TH PM NGS STATION "CONYERS" N46° 51'04"W - 11,316.51' 30' INGRESS, EGRESS, DRAINAGE AND UTILITY EASEMENT REC. NO. 202013814 EA-4 15,086 SQ FT (0.346 AC) ANTONI POGERZELSKI & LIDIA POGERZELSKI 8989 W BUSINESS 83 HARLINGEN, TX 78552-2283 REC 206105746, REC 206105747 & REC 20610548 PROPOSED ROW POB EA-4 TO SE COR SEC 15 S89° 15'00"E - 1008.18' S89°15'00"E - SEC LINE 74.821 2590.821 ROW 525 ACCESS OPENING SIGS STATION

ROW	

FOUND R.O.W. MONUMENT COORDINATE TABLE							
Point No.	Northing(ft)	Easting(ft)	Description				
1000	394176.58	150018.01	1.5" AL CAP - LS 12043				
1001	394008.78	149810.29	1.5" AL CAP - LS 15672				
1500	393949.65	149869.42	3.25" BRASS CAP IN CONC				

⊙ xxx

TABULATION OF Calculated Points							
Point No.	Northing(ft)	Easting(ft)	Description				
901	393941.98	150220.96					

Notes:

1. The following easements are either generally described or cover existing facilities without a defined width or size and cannot be depicted:

Plateau Natural Gas Company, in Book 1994 at Page 289

The Mountain States Telephone and Telegraph Co., in Book 852 at Page 264

Ute Pass Improvement Co., in Book 358 at Page 577

Basis of Bearings: Bearings are Colorado State Plane, Central Zone, NAD 83/92, based on a line between NGS station "CONYERS" PID - JK1354, a steel rod encased in PVC with NGS logo cap set in 1.6' concrete post near mile post 290.2, and NGS station "QUILLEN" PID - JK1385, a drill hole in sandstone near mile post 298.15. Said line bears S45° 08'14"E per CDOT control diagram for project number 14173.


See www.ngs.noaa.gov for data sheets containing detailed location information.



TABULATION OF R.O.W. MONUMENTS TO BE SET							
Point No.	Northing(ft)	Easting(ft)	Description				
525	393941.00	150295.77	CDOT TYPE I MONUMENT				
526	394061.76	150117.34	CDOT TYPE I MONUMENT				
527	394117.36	150181.60	CDOT TYPE I MONUMENT				
528	394022.82	150263.38	CDOT TYPE I MONUMENT				

SURVEYOR STATEMENT (R.O.W. MONUMENTS)

I, Fredrick L. Easton, a professional land surveyor licensed in the State of Colorado, do hereby state to the Colorado Department of Transportation that based upon my knowledge, information and belief, adequate research, calculations and evaluation of survey evidence were performed and the Right-of-Way monuments depicted on this Right-of-Way Plan were set under my responsible charge in accordance with applicable standards of practice defined by Colorado Department of Transportation publications. This statement is not a guaranty or warranty, either expressed or implied.

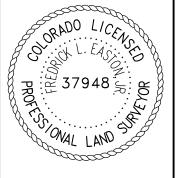

P.O. Box 536 905 Erie Avenue Pueblo, CO 81002 Phone: 719-546-5438 FAX: 719-546-5702

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Farnsworth	
GROUP	Pro
755 FORGE ROAD, SUITE 150 :OLORADO SPRINGS, COLORADO 80907	Pro
710) 500 0104 (710) 500 0111 5	

RIGHT OF WAY
EXHIBIT EA-5

Project Number: NH 0242-056

Project Location: U.S. 24 Fire Mitigation - Cascade

EL PASO COUNTY, COLORADO

Project Code: Last Mod. Date Subset Sheet No. Sheet Total

Region 2

SECTION 22 T13S, R68W, 6TH PM EL PASO COUNTY, CO





		PF	ROJECT CO	ONTROL TABLE
Point No.	Project Co	oordinates	Elev(ft)	Description
Politi No.	Northing(ft)	Easting(ft)	(NAVD88)	Description
400	393870.32	150213.02	7519.56	MAG NAIL
450	393758.48	150106.52	7523.40	MAG NAIL IN ASPHALT SHOULDER OF HWY 24
451	393221.94	150621.04	7482.85	18" #5 REBAR W/RPC "FARNSWORTH CONTROL POINT"
452	392679.37	151152.33	7479.74	18" #5 REBAR W/RPC "FARNSWORTH CONTROL POINT"
CONYERS	401915.89	141761.70	7924.85	SMOOTH STEEL ROD IN LOGO BOX'CONYERS 1991'
QUILLEN	374992.80	168814.07	6438.85	3.25IN DIA BRASS CAP IN STONE OURCROPING 'QUILLEN 1992'

General Notes:

Sheet Revisions


- 1. This Right-of-Way Exhibit is not a complete boundary survey of all adjoining owners and is prepared for the Colorado Department of Transportation purposes only.
- 2. Notice: According to Colorado law, you must commence any legal action based upon any defect in this survey within three years after you first discover such defect. In no event may any action based upon such defect in this survey be commenced more than ten years from the date of certification hereon.
- 3. Existing right-of-way lines were established using CDOT Project No. F024-2(1) Sec. 1 Right-of-Way Plans. Aliquot section corners and lines are per CDOT Control Diagram Sheet for Project CX 04-0024-45.
- 4. For title information Farnsworth Group, Inc. relied on title commitments provided by H. C. Peck and Associates.

COORDINATE DATUM: Project coordinates are modified Colorado State Plane Central Zone NAD '83/(92) coordinates. The combined elevation/scale factor used to modify the coordinates from state plane to project coordinates is 1.0003911506. The resulting project coordinates are truncated by 3,000,000sft in the Northing and 1,000,000sft in the Easting after converting from state plane coordinates to project coordinates. The CHARN is based on the NAD '83(92) datum.

Project Coordinates Northing US Survey Feet = (State Plane Coordinate Northing * 1.0003911506 - 3,000,000) * (3937/1200).

Project Coordinates Easting US Survey Feet = (State Plane Coordinate Easting * 1.0003911506 - 1,000,000) * (3937/1200).

Basis of Elevations: Project elevations are based on NAVD 88 values published on the CDOT Control Diagram Sheet, Project No. 141173, dated Feb 19, 2003.

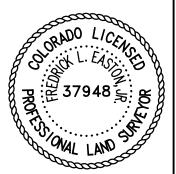

	R.O.W. TABULATION OF PROPERTIES IN EL PASO COUNTY - U.S. NO. 24								Book and Page					
Parcel No.	Ownership News and Mailing		Version 1	Area In Square Feet (Acres)			Area In Square Feet (Acres)			Area In Square Feet (Acres)			Title Commitment	Remarks
	Ownership Name and Mailing Address Site Address	Site Address	Location T-13-S R-68-W, 6TH PM	Area Of Parcel	Existing ROW	Net Area	Remainder Left	Remainder Right	No. And/Or Reception No.	No.				
EA-5	PATRICIA G ROBBINS		NE1/4 SEC 22	12,462 SQ FT			92,953 SQ FT			05493A2013				
	PO BOX 6			(0.286 AC)			(2.134 AC)							
	MANITOU SPRINGS, CO 80829-0006													


P.O. Box 536 905 Erie Avenue Pueblo, CD 81002 Phone: 719-546-5438 FAX: 719-546-5702

	Sheet Revisions			Sheet Revisions		
te	Description	Initials	Date	Description	Initials	D
6-13	Revised Design References	SDP				

Sheet Revisions			
Description	Initials	Farnsworth	
		SCIENTISS GROUP	Р
		4755 FORGE ROAD, SUITE 150 COLORADO SPRINGS, COLORADO 80907	Р
		(719) 590-9194 / (719) 590-9111 Fax	Г

	RIGHT OF WAY					
h	EXHIBIT EA-5					
	Project Nu	mber: NH 02	42-056			
0907	Project Location: U.S. 24 Fire Mitigation - Cascade					
0907	EL PASO COUNTY, COLORADO					
	Project Code:	Last Mod. Date	Subset	Sheet No.	Sheet Total	
	19358	03-06-13	5.02 of 5.02	5.02	13	

Region 2

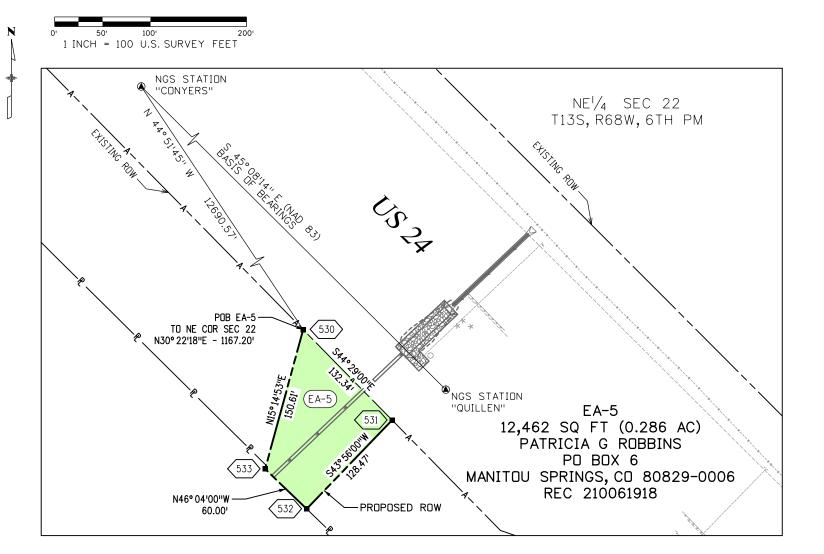

Notes:

1. The following easement covers existing facilities without a defined width or size and cannot be depicted:

The Mountain States Telephone and Telegraph Co., in Book 852 at Page 264

Basis of Bearings: Bearings are Colorado State Plane, Central Zone, NAD 83/92, based on a line between NGS station "CONYERS" PID - JK1354, a steel rod encased in PVC with NGS logo cap set in 1.6' concrete post near mile post 290.2, and NGS station "QUILLEN" PID - JK1385, a drill hole in sandstone near mile post 298.15. Said line bears S45° 08'14"E per CDOT control diagram for project number 14173.


See www.ngs.noaa.gov for data sheets containing detailed location information.

XXX ►

TABULATION OF R.O.W. MONUMENTS TO BE SET						
Point No.	Northing(ft)	Easting(ft)	Description			
530	392920.78	150713.72	CDOT TYPE I MONUMENT			
531	392826.36	150806.45	CDOT TYPE I MONUMENT			
532	392733.84	150717.32	CDOT TYPE I MONUMENT			
533	392775.47	150674.11	CDOT TYPE I MONUMENT			

SURVEYOR STATEMENT (R.O.W. MONUMENTS)

I, Fredrick L. Easton, a professional land surveyor licensed in the State of Colorado, do hereby state to the Colorado Department of Transportation that based upon my knowledge, information and belief, adequate research, calculations and evaluation of survey evidence were performed and the Right-of-Way monuments depicted on this Right-of-Way Plan were set under my responsible charge in accordance with applicable standards of practice defined by Colorado Department of Transportation publications. This statement is not a guaranty or warranty, either expressed or implied.

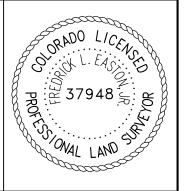

DOT P

P.O. Box 536 905 Erie Avenue Pueblo, CO 81002 Phone: 719-546-5438 FAX: 719-546-5702


	Sheet Revisions			Sheet Revisions		
ite	Description	Initials	Date	Description	Initials	Date
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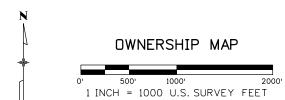
Sheet Revisions			
Description	Initials	ARCHIECIS Farneworth	
		Farnsworth GROUP	
		SCIENTISS GROUP	
		4755 FORGE ROAD, SUITE 150	
		COLORADO SPRINGS, COLORADO 80907	
		(719) 590-9194 / (719) 590-9111 Fax	

th			EA-PE-6 & I	EA-TE	-6
	Project Nu	mber: NH 02	42-056		
80907	Cascade	;			
EL PASO COUNTY, COLORADO					
	Project Code:	Last Mod. Date	Subset	Sheet No.	Sheet Tota

RIGHT OF WAY

Region 2



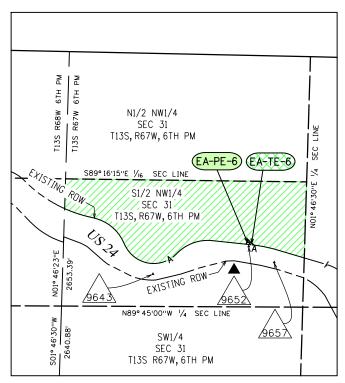

PROJECT CONTROL TABLE							
Daint No.	Project Co	oordinates	Elev(ft) (NAVD88)	Description			
Point No.	Northing(ft)	Easting(ft)		Description			
9643	380755.29	161775.03	6825.52	CDOT TYPE II 3.25" ALUM, CAP M.P. 296.43			
9652	381044.37	162773.78	6758.02	CDOT TYPE II 3.25" ALUM. CAP M.P. 296.52			
9657	380876.75	163038.92	6738.45	CDOT TYPE II 3.25" ALUM, CAP M.P. 296.57			
CONYERS	401915.89	141761.70	7924.85	SMOOTH STEEL ROD IN LOGO BOX'CONYERS 1991'			
QUILLEN	374992.80	168814.07	6438.85	3.25IN DIA BRASS CAP IN STONE OURCROPING 'QUILLEN 1992'			

SECTION 31 T13S, R67W, 6TH PM EL PASO COUNTY, CO

General Notes:

- 1. This Right-of-Way Exhibit is not a complete boundary survey of all adjoining owners and is prepared for the Colorado Department of Transportation purposes only.
- 2. Notice: According to Colorado law, you must commence any legal action based upon any defect in this survey within three years after you first discover such defect. In no event may any action based upon such defect in this survey be commenced more than ten years from the date of certification hereon.
- 3. Existing right-of-way lines were established using CDOT Project No. F017-1(2) Right-of-Way calculations and control monuments, provided by CDOT. Aliquot section corners and lines are per CDOT Control Diagram Sheet for Project CX 04-0024-45.
- 4. For title information Farnsworth Group, Inc. relied on title commitments provided by H. C. Peck and Associates.

CODRDINATE DATUM: Project coordinates are modified Colorado State Plane Central Zone NAD '83/(92) coordinates. The combined elevation/scale factor used to modify the coordinates from state plane to project coordinates is 1.0003911506. The resulting project coordinates are truncated by 3,000,000sft in the Northing and 1,000,000sft in the Easting after converting from state plane coordinates to project coordinates. The CHARN is based on the NAD '83(92) datum.

Project Coordinates Northing US Survey Feet = (State Plane Coordinate Northing * 1.0003911506 - 3,000,000) * (3937/1200).

Project Coordinates Easting US Survey Feet = (State Plane Coordinate Easting * 1.0003911506 - 1,000,000) * (3937/1200).

Basis of Elevations: Project elevations are based on NAVD 88 values published on the CDDT Control Diagram Sheet, Project No. 141173, dated Feb 19, 2003.



		LATION OF PRO		O COUNTY - U.S. NO. 24 Area In Square Feet (Acre				Book and Page No. And/Or	Title Commitment	Remarks	
Parcel No.	Ownership Name and Mailing Address	Site Address Location T-13-S R-67-W, 6TH PM	Area Of Parcel	Existing ROW	Net Area	Remainder Left	Remainder Right	Reception No.	No.		
EA-PE-6	AMERICAN CHRISTIAN COLLEGE, INC.,		S1/2 NW1/4 SEC 31	844 SQ FT				1,567,332 SQ FT		05526A2013	
	AN OKLAHOMA CORPORATION, DBA			(0.019 AC)				(35.981 AC)			
	SUMMIT YOUTH MINISTRIES, INC.										
EA-TE-6	PO BOX 207		SAME	1179 SQ FT							For construction and maintenance of headwalls
	MANITOU SPRINGS, CO 80829-0207			(0.027 AC)							and wingwalls for existing culvert


P.O. Box 536 905 Erie Avenue Pueblo, CD 81002 Phone: 719-546-5438 FAX: 719-546-5702

	Sheet Revisions			Sheet Revisions		
ate	Description	Initials	Date	Description	Initials	
06-13	Revised Design References	SDP				

Sheet Revisions Farnsworth 755 FORGE ROAD, SUITE 150 OLORADO SPRINGS, COLORADO 809 '19) 590-9194 / (719) 590-9111 Fax

RIGHT OF WAY EXHIBIT EA-PE-6 & EA-TE-6 Project Number: NH 0242-056 Project Location: U.S. 24 Fire Mitigation - Cascade EL PASO COUNTY, COLORADO

Region 2

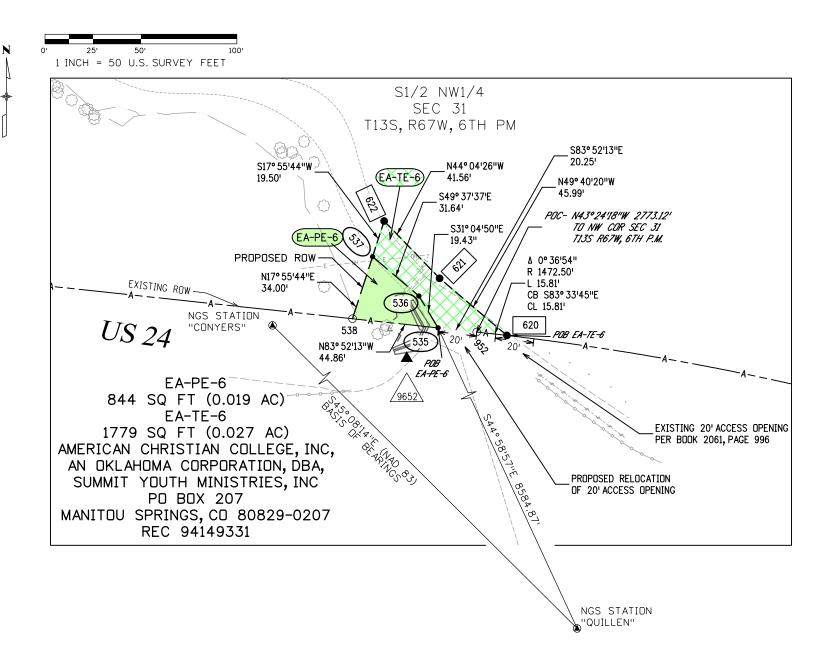

Notes:

1. Right-of-way for Waldo Canyon Creek is an exception to title; however, exact location and size of this right-of-way is unknown at this time, and can not be depicted.

XXX

TABULATION OF TEMPORARY EASEMENT POINTS TO BE STAKED						
Point No.	Northing(ft)	Easting(ft)	Description			
620	381056.34	162825.94				
621	381086.1	162790.88				
622	381115.96	162761.97				



TAB	ULATION OF PER	RMANENT EASEMEN	IT MONUMENTS TO BE SET
Point No.	Northing(ft)	Easting(ft)	Description
535	381060.27	162790.10	CDOT TYPE VI MONUMENT
536	381076.92	162780.07	CDOT TYPE VI MONUMENT
537	381097.41	162755.96	CDOT TYPE VI MONUMENT
538	381065.06	162745.50	CDOT TYPE VI MONUMENT

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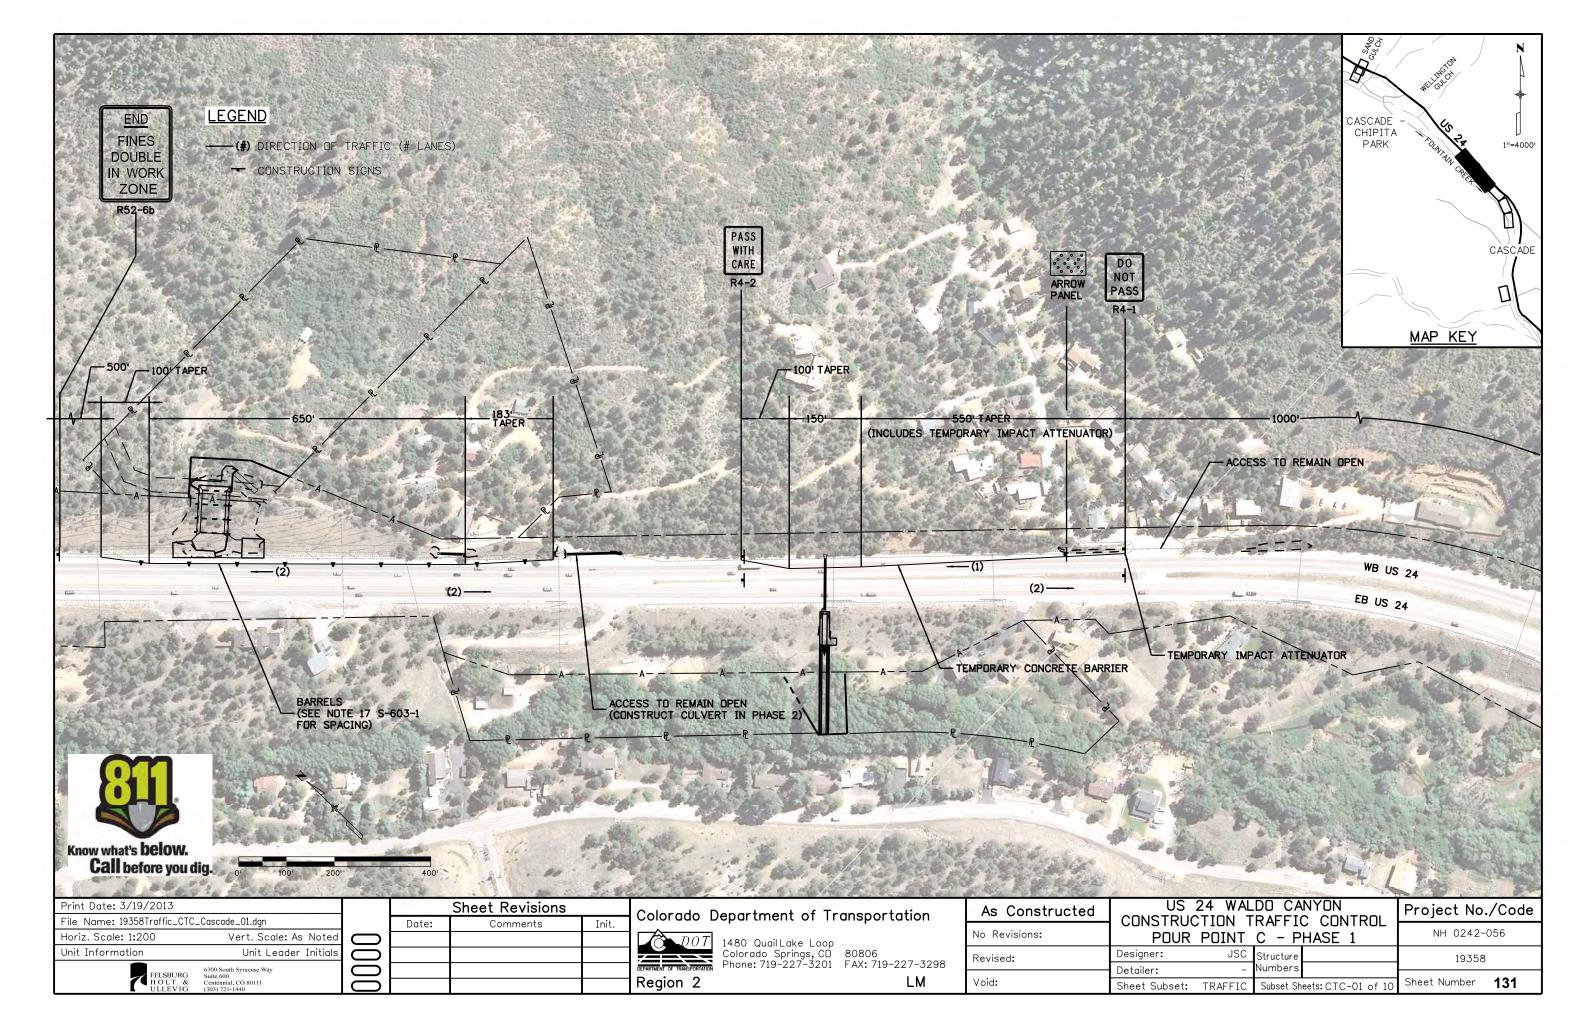
TABULATION OF CALCULATED POINTS						
Point No.	Northing(ft)	Easting(ft)	Description			
952	381058.11	162810.23				


Basis of Bearings: Bearings are Colorado State Plane, Central Zone, NAD 83/92, based on a line between NGS station "CONYERS" PID - JK1354, a steelrod encased in PVC with NGS logo cap set in 1.6' concrete post near mile post 290.2, and NGS station "QUILLEN" PID - JK1385, a drill hole in sandstone near mile post 298.15. Said line bears S45° 08'14"E per CDDT control diagram for project number 14173.


See www.ngs.noaa.gov for data sheets containing detailed location information.


SURVEYOR STATEMENT (R.O.W. MONUMENTS)


Fredrick L. Easton , a professional land surveyor licensed in the State of Colorado, do hereby state to the Colorado Department of Transportation that based upon my knowledge, information and belief, adequate research, calculations and evaluation of survey evidence were performed and the Right-of-Way monuments depicted on this Right-of-Way Plan were set under my responsible charge in accordance with applicable standards of practice defined by Colorado Department of Transportation publications. This statement is not a quaranty or warranty, either expressed or implied.




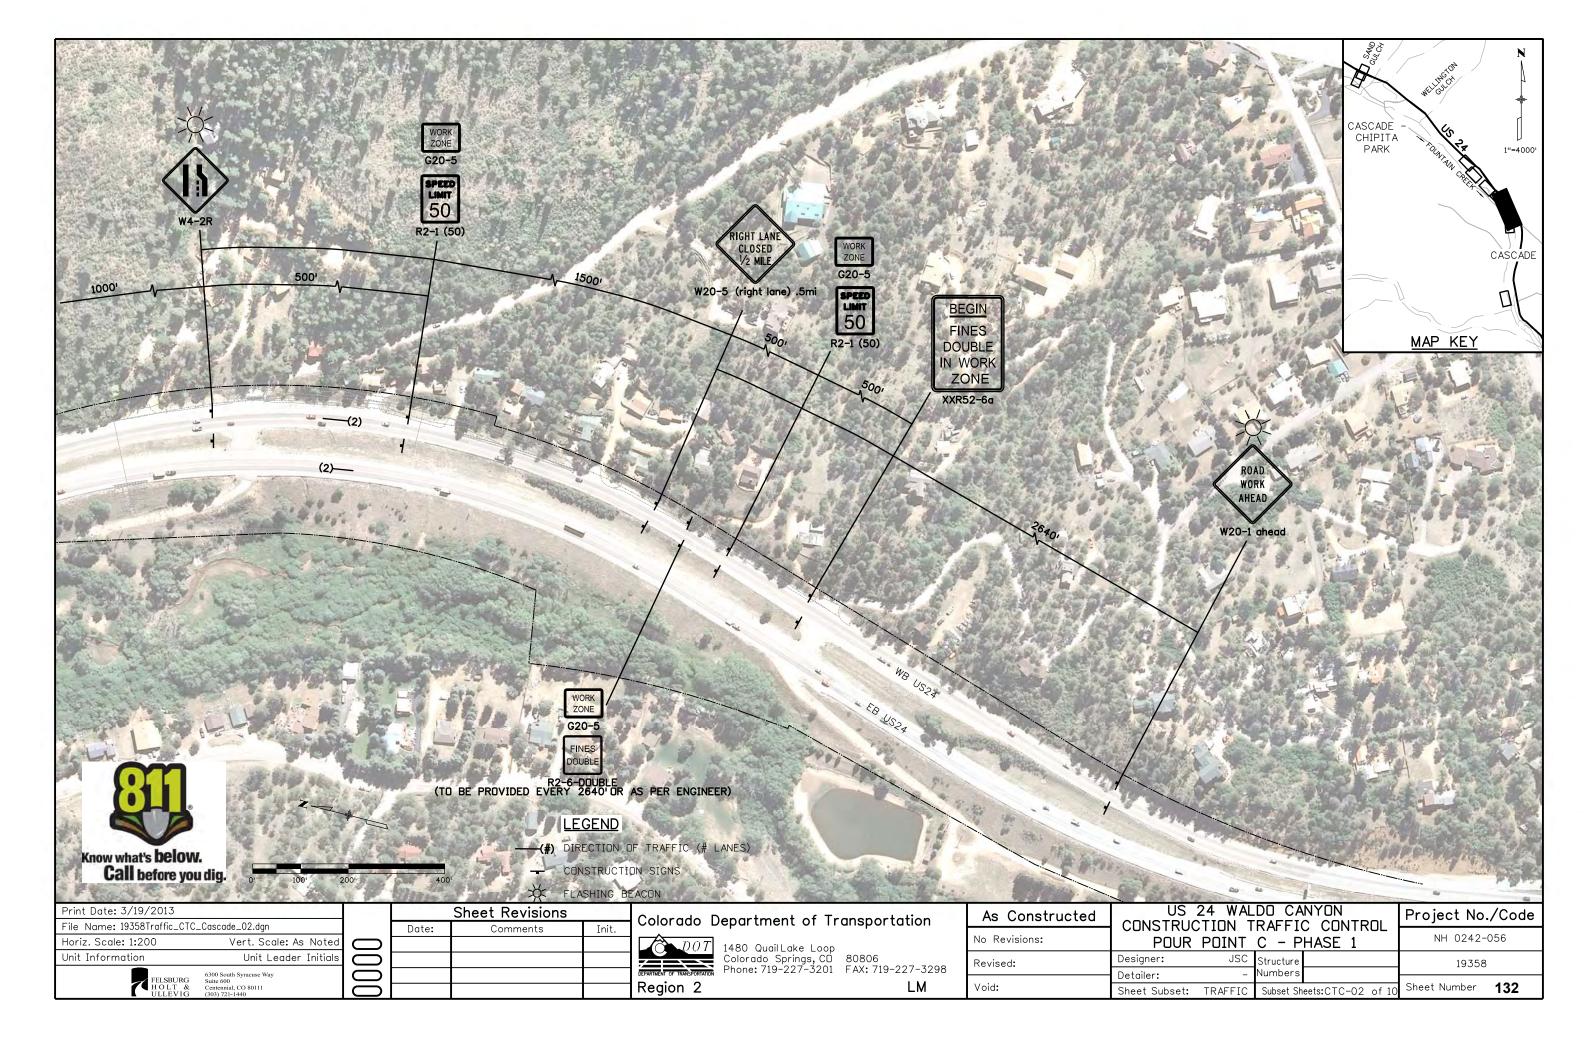


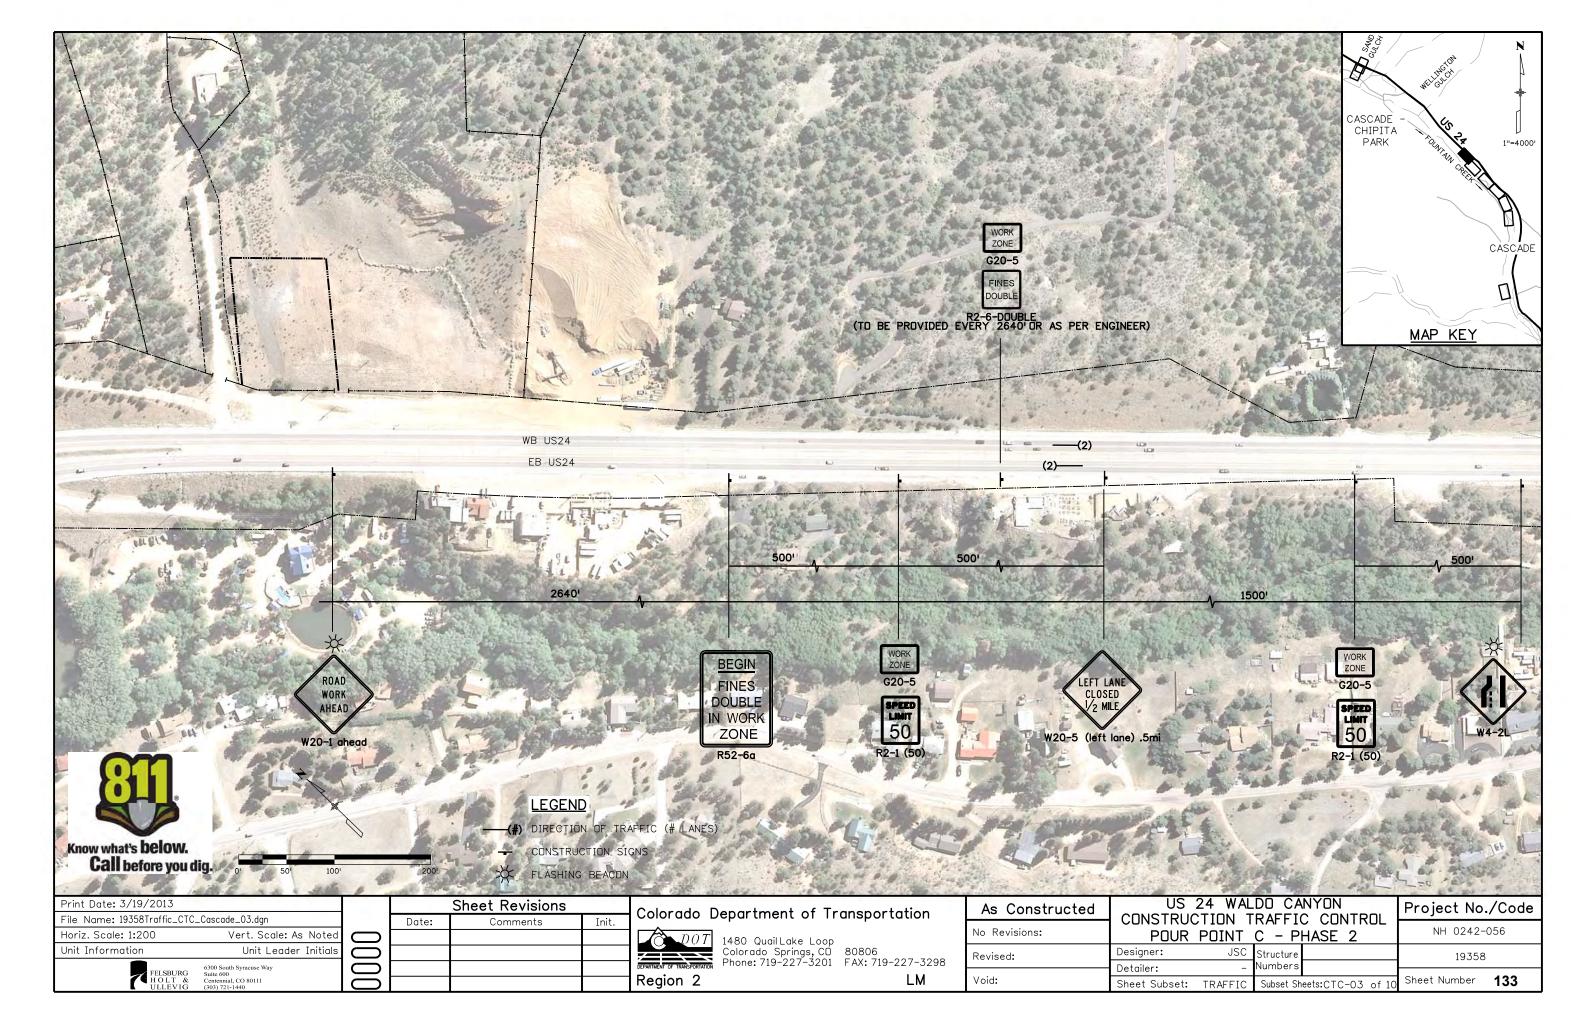


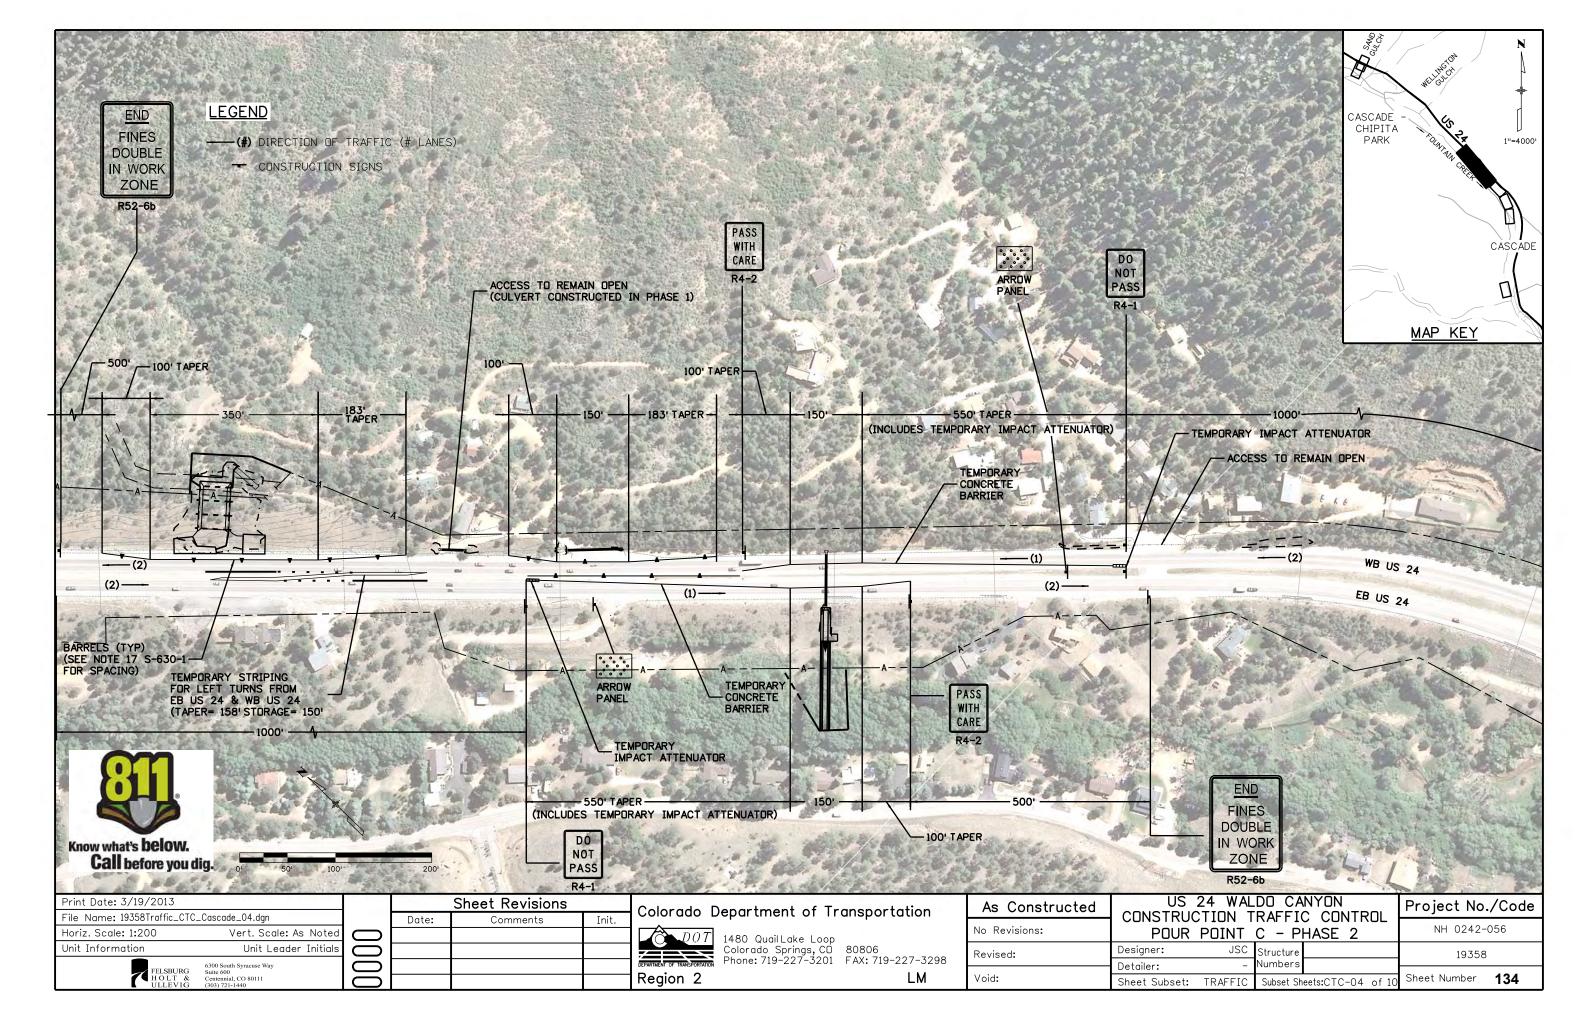

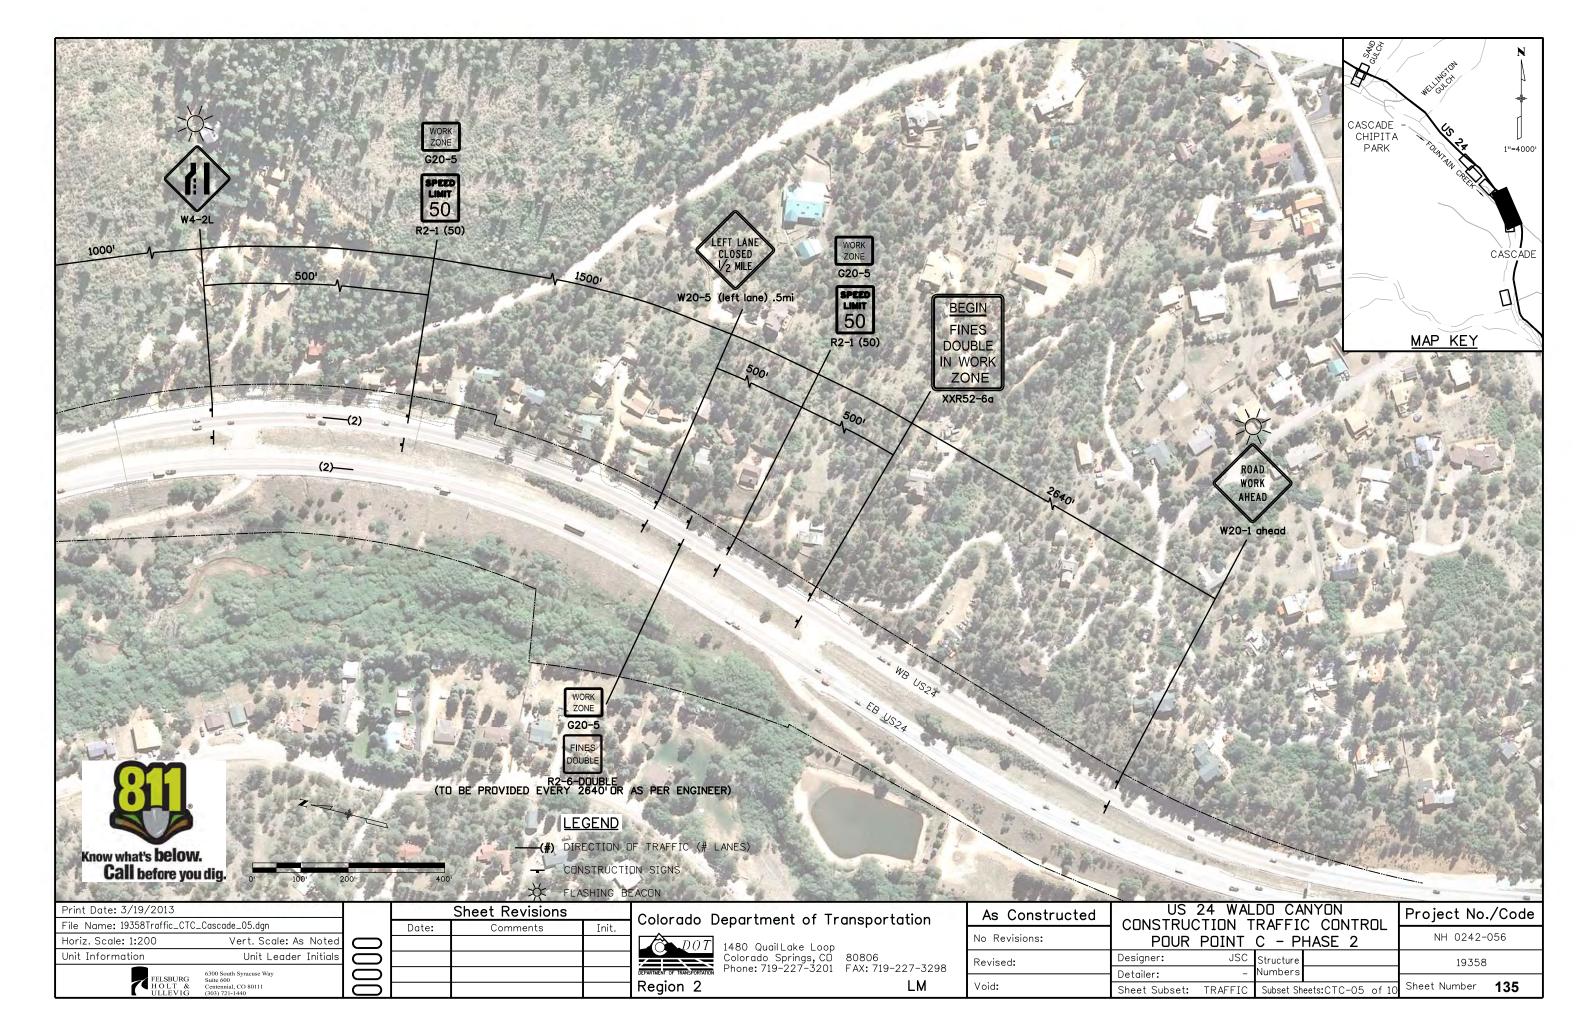

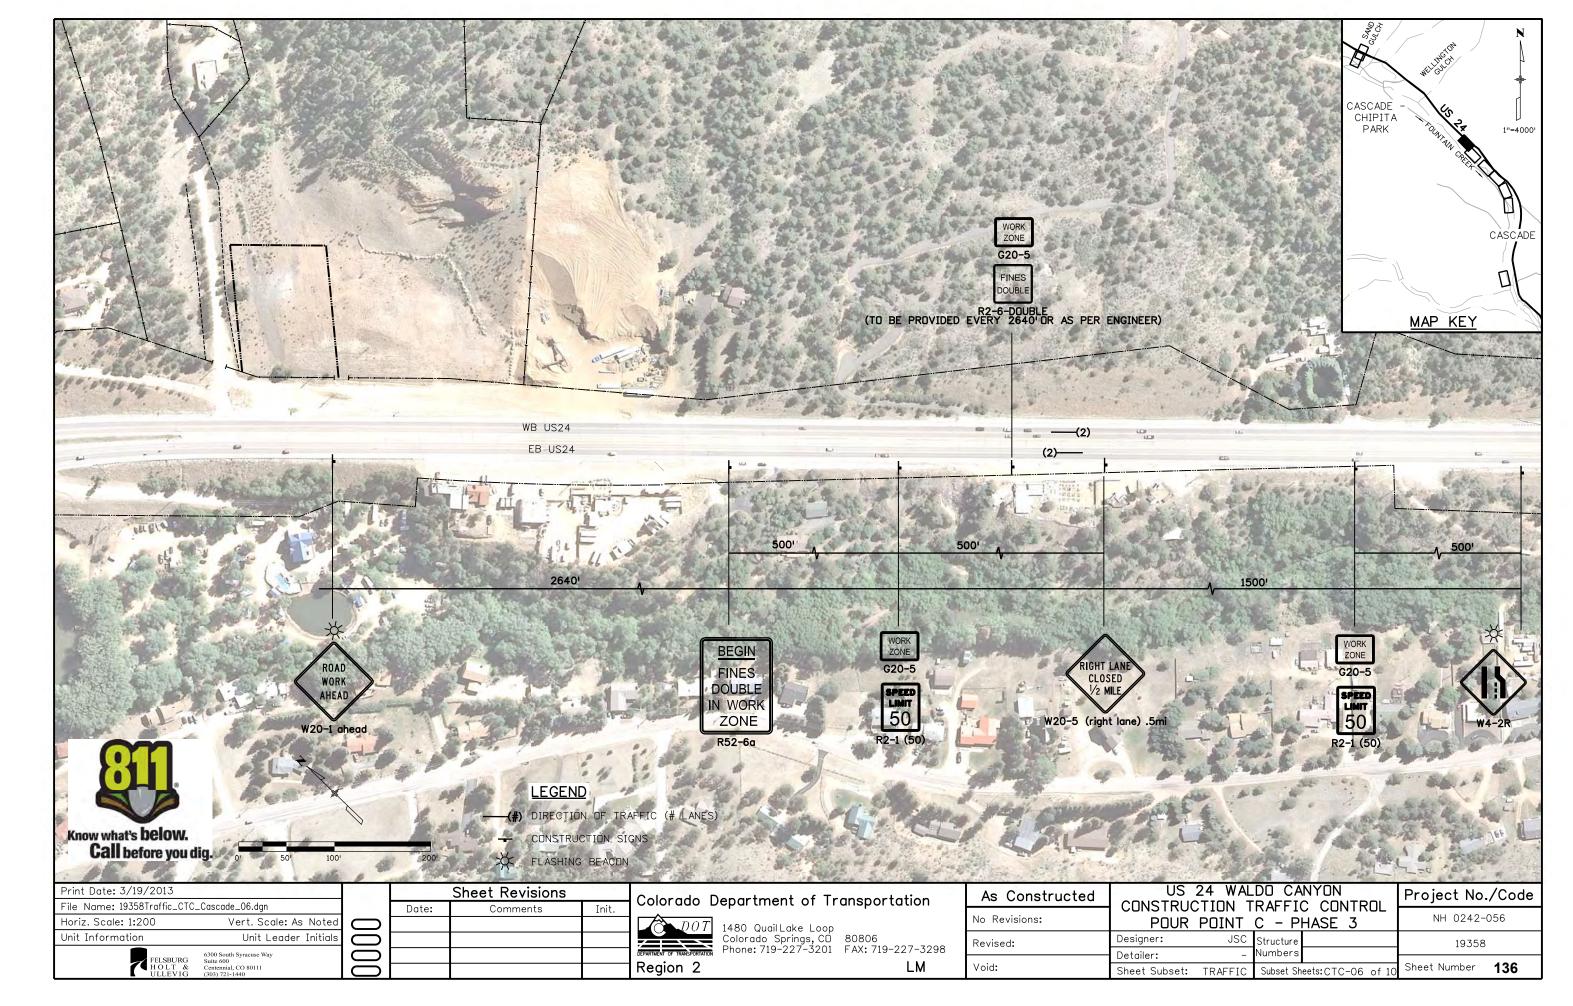


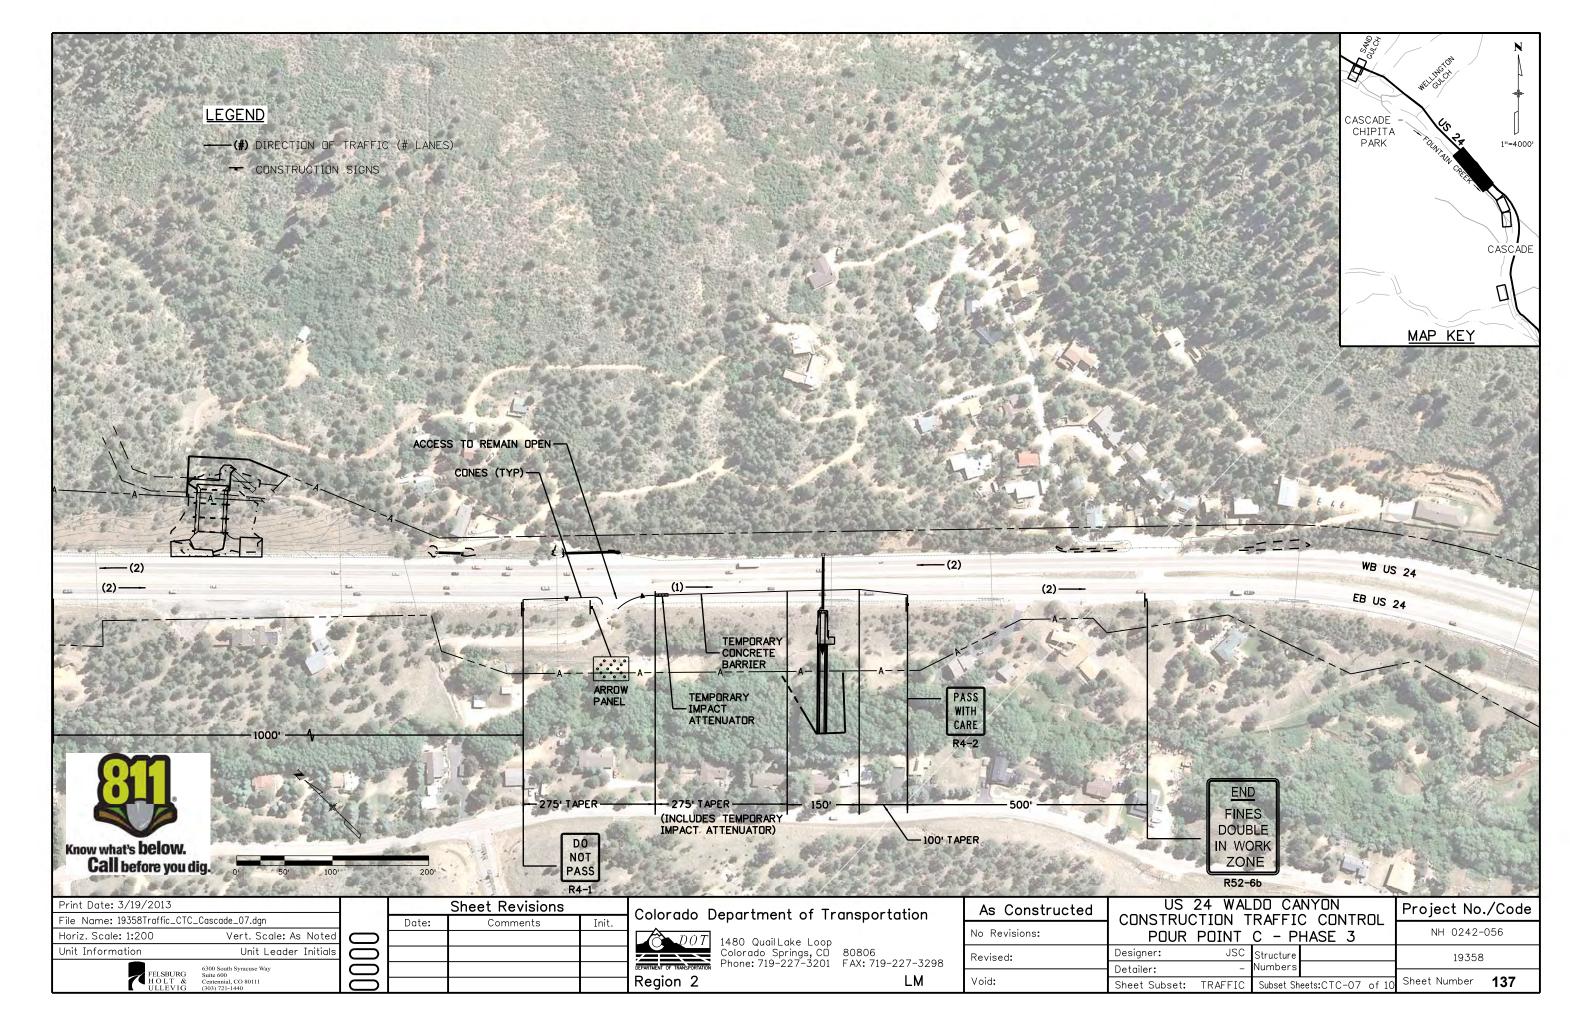


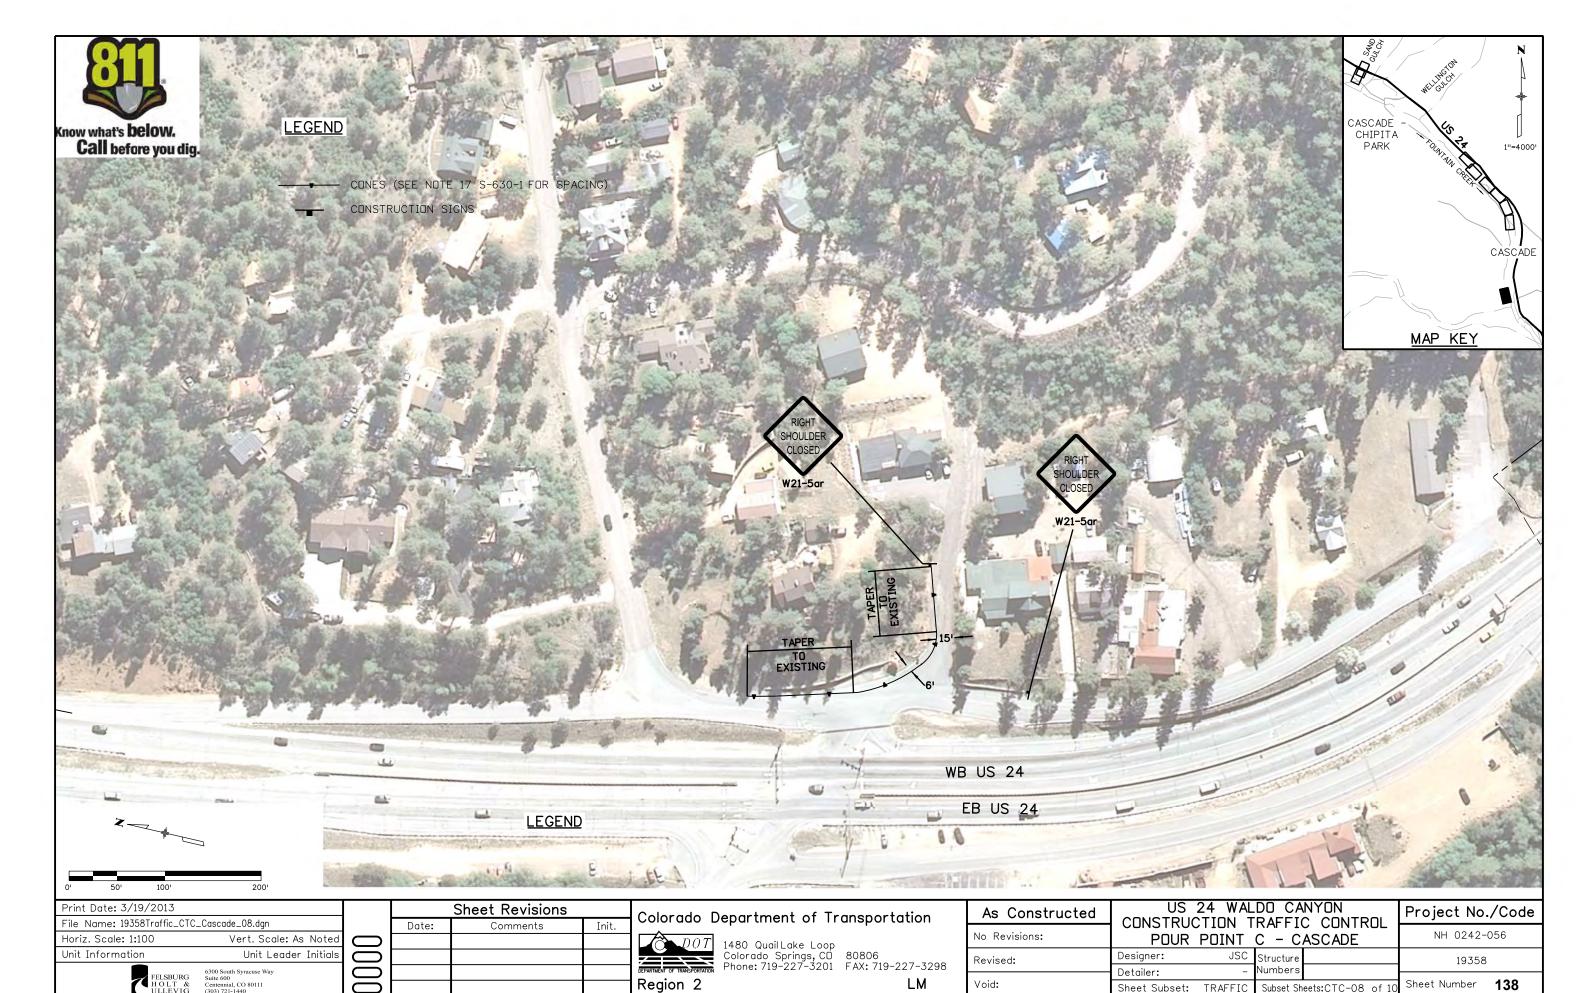

Sheet Subset: TRAFFIC

Subset Sheets:CTC-08 of 10

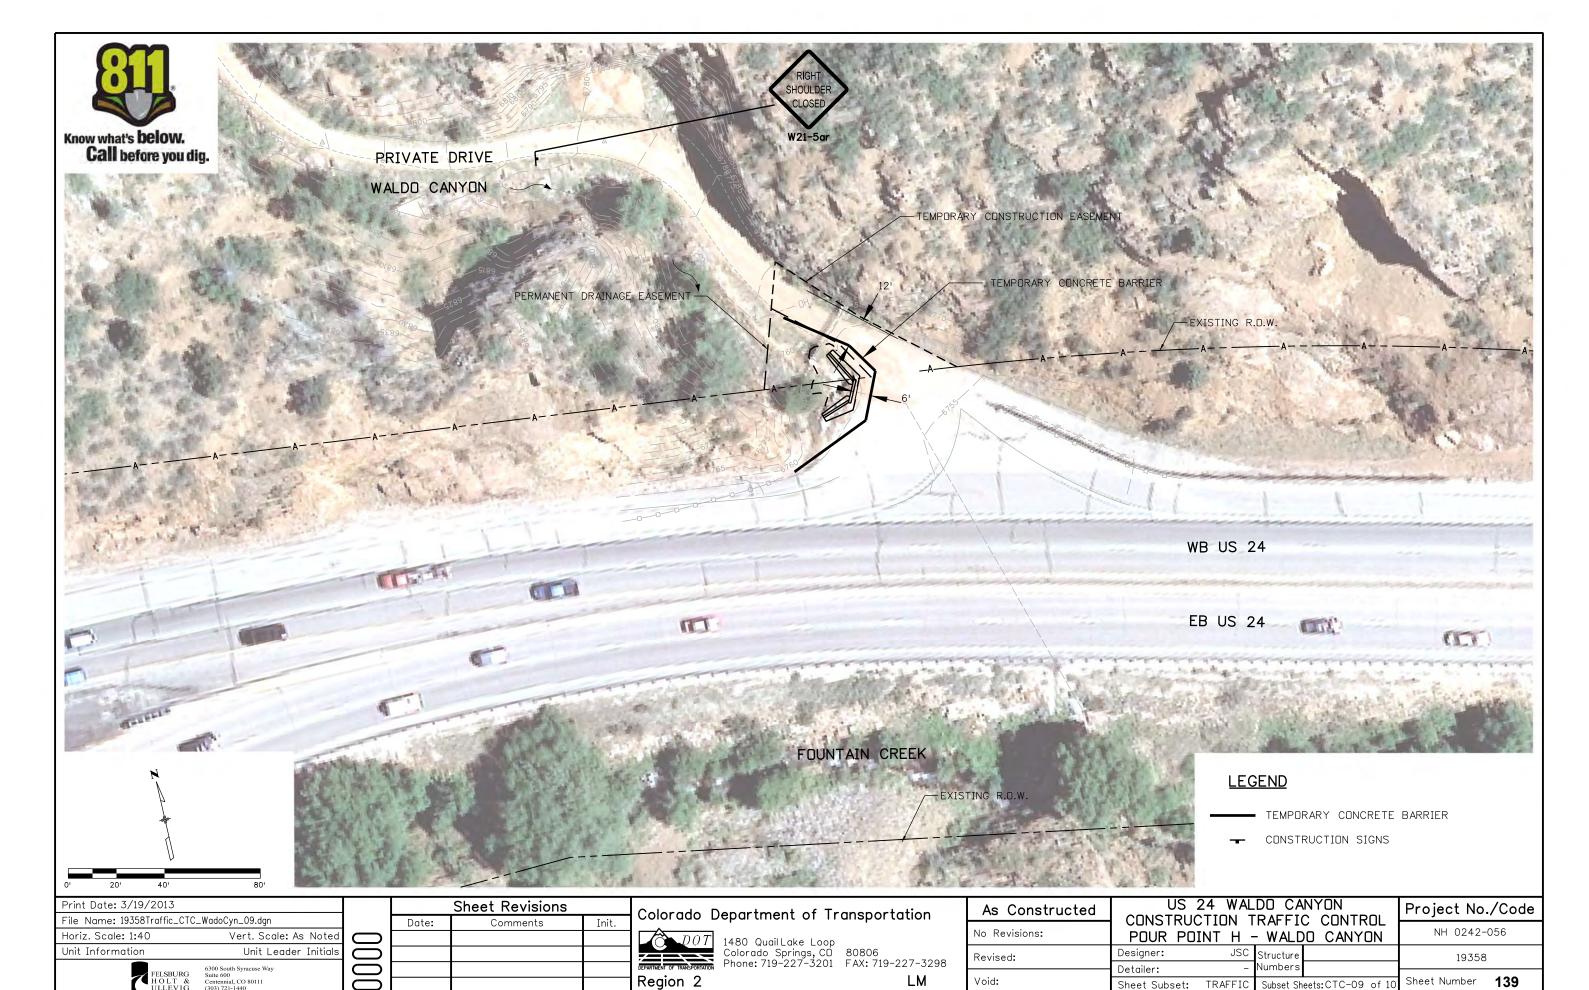

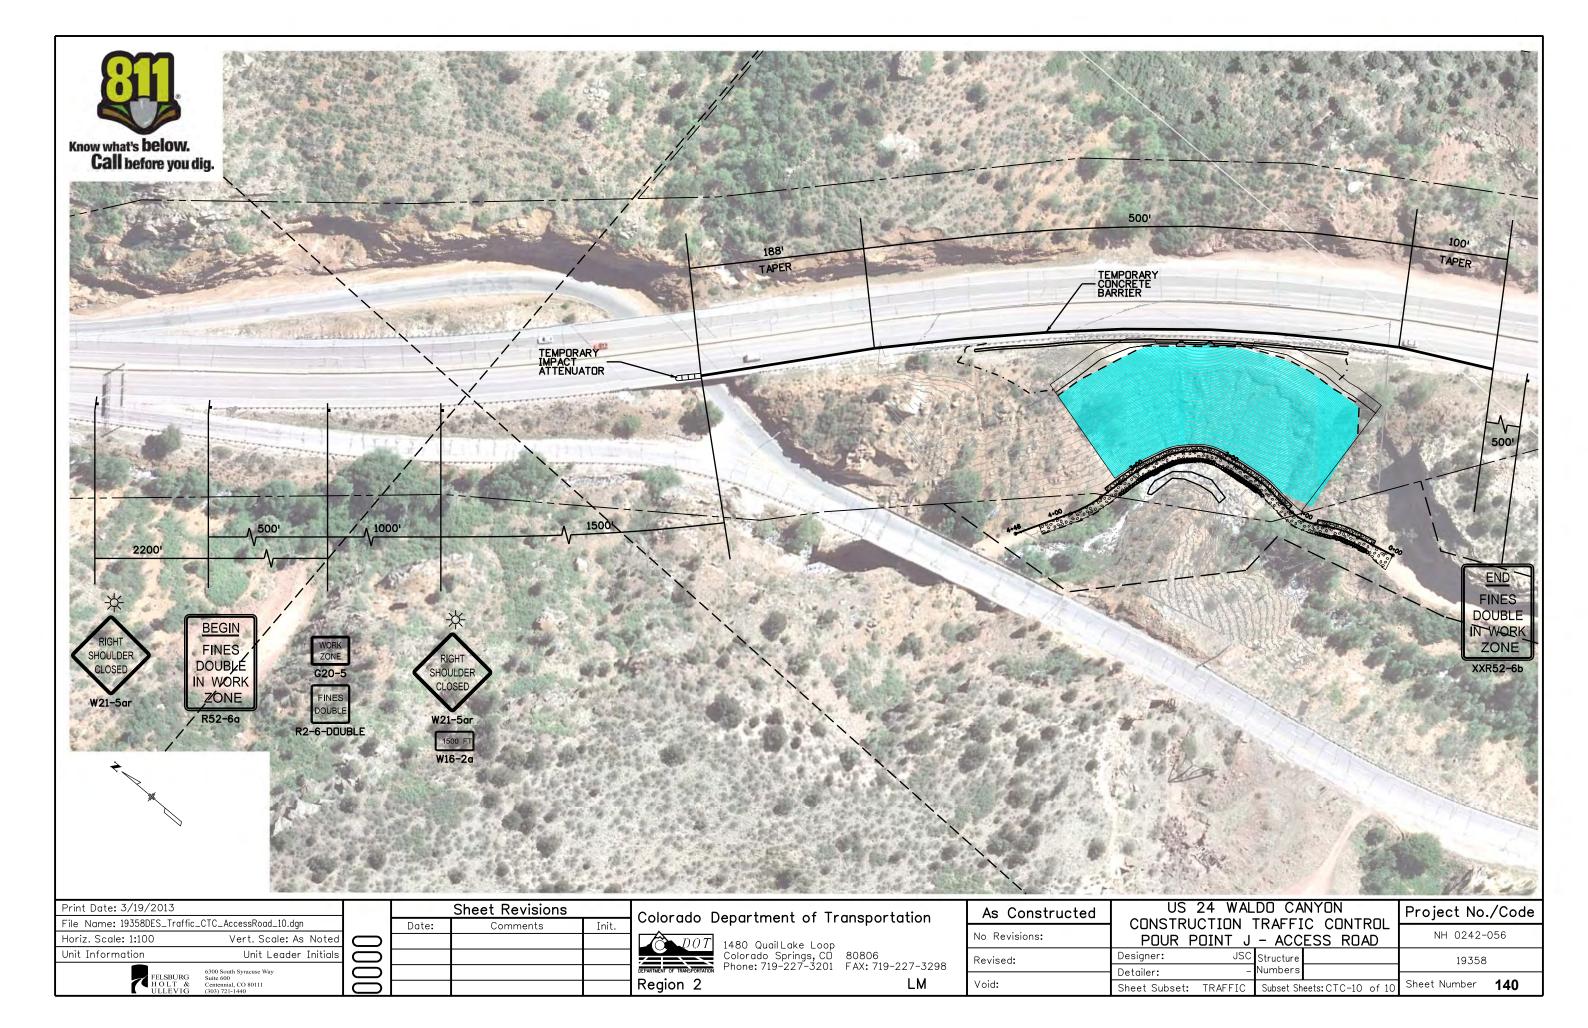

Oversight / NHS FHWA REGION VIII OVERSIGHT? ☑ NO □ YES NATIONAL HIGHWAY SYSTEM? □ NO ☑ YES

DEPARTMENT OF TRANSPORTATION STATE OF COLORADO

Related Projects:

P. E. UNDER PROJECT: Project Number Project Code:

XXXXXXXXX XXXXX

R.O.W. Projects:


R.O.W. Project Description

XXXXXXXXXXXXXX

CONSTRUCTION BID PLANS OF PROPOSED **PROJECT NO. NH 0242-056** US 24 - WALDO CANYON POST FIRE FLOOD MITIGATION **EL PASO COUNTY**

CONSTRUCTION PROJECT CODE NO. 19358

DWG NO.	SHEET NO.	INDEX OF SHEETS
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16 17-18 19-23 24-25 26-27 28-29	A-1 A-2 TO A-3 A-4 TO A-8 A-9 TO A-10 A-11 TO A-12 A-13 TO A-14	POUR POINT A TABULATION OF QUANTITIES REMOVALS / RESETS PLAN DRAINAGE DETAILS GRADING/INITIAL EROSION CONTROL PLANS GRADING/INTERIM EROSION CONTROL PLANS GRADING/FINAL EROSION CONTROL PLANS
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DWG NO.	SHEET NO.	INDEX OF SHEETS (CONT.)
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76A 77 78-79 80 81 82 83-84 85A 86 87-95 96-97 98-99 100A 101 102-116	J-1A J-2 J-3 T0 J-4 J-5 J-6 J-7 J-8 T0 J-9 J-10A J-11 J-12 T0 J-20 J-21 T0 J-20 J-21 T0 J-22 J-25 A J-26 J-27 T0 J-41	GRADING/FINAL EROSION CONTROL PLANS GRADING/FINAL EROSION CONTROL PLANS GRADING/FINAL EROSION CONTROL PLANS
131-140		CONSTRUCTION TRAFFIC CONTROL PLANS

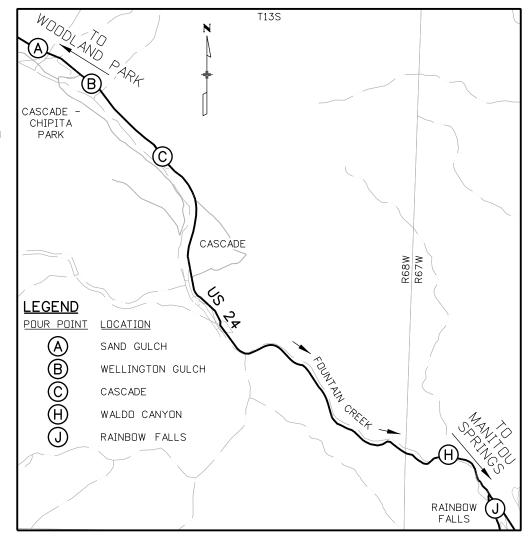PROJECT LOCATION MAP

4000'

Print Date: 4/22/2013		
File Name: 19358DES_TitleSht	tC.dgn	
Horiz. Scale: 1:4000	Vert. Scale: As Noted	a
Unit Information	Unit Leader Initials	Œ
FELSBURG	6300 South Syracuse Way Suite 600	Œ
■ HOLT & ULLEVIG	Centennial, CO 80111 (303) 721-1440	C

	Date:	Comments	Init.
\mathbb{R} -D	04-16-13	UPDATE SHEETS	CDT
R-2	04-19-13	UPDATE SHEET	CDT
R-3	04-22-13	REVISED SHEET NUMBER	CDT

Colorado	Department of	Transportation
D07	1480 QuailLake Lo	00p

Region 2

	I M
1480 Quail Lake Loop Colorado Springs, CD Phone: 719-227-3201	80806 FAX: 719-227-3298

As Constructed	Contract Information	Project No./Code	
	Contractor:		
No Revisions:	Resident Engineer: DAVE WATT	NH 0242-056	
Revised:	Project Engineer: LESLEY MACE	19358	
	PROJECT STARTED: / / ACCEPTED: / /		
Void:	Comments:	Sheet Number 1C	

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COLORADO DEPARTMENT OF TRANSPORTATION M&S STANDARDS PLANS LIST July 04, 2012

Revised on March 5, 2013

ALL OF THE M&S STANDARD PLANS, AS SUPPLEMENTED AND REVISED, APPLY TO THIS PROJECT WHEN USED BY DESIGNATED PAY ITEM OR SUBSIDIARY ITEM.

NEW OR REVISED STANDARD PLAN SHEETS APPLICABLE TO THIS PROJECT, INDICATED BY A MARKED BOX , WILL BE ATTACHED TO THE PLANS.

HOMIDEN	IVE VIC	<u> </u>	HOMBER
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S STANDARD

TITLE

PAGE

<u>NUMBER</u>

PLAN NEW OR

NUMBER REVISED

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File Name: 19358DES_StdPlanList.dgn			Date:	Comments	Г
Horiz. Scale: 1:1	Vert. Scale: As Noted				Г
Unit Information	Unit Leader Initials				Г
FELSBURG HOLT & ULLEVIG	6300 South Syracuse Way Suite 600 Centennial, CO 80111 (303) 721-1440	00			

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\Box				DEPARTMENT OF TRANSPORTATION
\Box				Region 2

Colorado D	epartment of Tr	ansportation
DOT	1480 QuailLake Loop Colorado Springs, CO Phone: 719-227-3201	80806 FAX: 719-227-3298

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LM	Vc

As Constructed	US 24 WALDO CANYON [Project No./Code		
No Revisions:	STA	ANDARD	PLANS	LIS	T	NH 0242-056	>	
Revised:	Designer:		CDT Structure			19358		
	Detailer:	KLT	Numbers					
Void:	Sheet Subset:	DRAINAGE	Subset Sheets: SPL-1 of 1		Sheet Number 2			

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SUMMARY OF APPROXIMATE QUANTITIES

Index		Contract Item No.	Contract Item Un		Pour Point A Sand Gulch		Pour Point B Wellington Gulch		Pour Point C Cascade					Point J ow Falls	Overall Project		Project Totals		
look	Page	Sheet				Plan	As Const.	Plan	As Const.	Plan	As Const	Plan	As Const.	Plan	As Const.	Plan	As Const.	Plan	As Co
			201-00001	CLEARING AND GRUBBING	LS	1		1		ð,		1		1	12.11		11.71	5	
			202-00010	REMOVAL OF TREE	EA	13		45		17				11.11		59		134	
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			202-05026	SAWING ASPHALT MATERIAL (6 INCH)	ĹĚ											200		200	
			203-00010	UNCLASSIFIED EXCAVATION (COMPLETE IN PLACE)	CY	893		2973		3000				12916				19782	
			203-00060	EMBANKMENT MATERIAL (COMPLETE IN PLACE)	CY									450				450	
			203-00598	ROCK SCALING	HR	hi — i		11 - 11						60				60	
			203-01500	BLADING	HR											200		200	
			203-01510	BACKHOE	HR											200		200	
			203-01550	DOZING	HR											200		200	
1	П		203-01590	FRONT END LOADER (RUBBER TIRE)	HR.											200		200	
			203-01594	POTHOLING	HR											50		50	
			203-01622	SWEEPING (WITH PICKUP BROOM)	HR	40		40		40		40		40				200	
			206-00000	STRUCTURE EXCAVATION	CY									450				450	
			206-00510	FILTER MATERIAL (CLASS A)	CY						100			200				200	

Print Date: 3/18/2013						
File Name: 19358DES_SAQ01.dgn						
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Unit Information	Unit Leader Initials					
FELSBURG HOLT & ULLEVIG	6300 South Syracuse Way Suite 600 Centennial, CO 80111 (303) 721-1440					

	Date:	Comments	Init.
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Sheet Revisions

1	Colorado D	epartment of Tr	ansportation
	DOT	1480 QuailLake Loop Colorado Springs, CO Phone: 719-227-3201	80806 FAX: 719-227-329

Region 2

3298	Revised:
/	Void:

As Constructed	SUMMARY OF APPROXIMATE					Project No./Cod			
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	Detailer:	KLT	Numbers					-	
	Sheet Subset:	TAB	Subset Sheets: SAQ-1 of 6		Sheet Number				
								_	

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SUMMARY OF APPROXIMATE QUANTITIES

	Index		Contract Item No.	Contract Item	Unit	Pour Point A Sand Gulch		Pour Point B Wellington Gulch			Point C scade		Point H Canyon	Pour Rainb	Point J ow Falls	Overall Project		Proje	ct Totals
Book	Page	Sheet				Plan	As Const.	Plan	As Const.	Plan	As Const.	Plan	As Const.	Plan	As Const.	Plan	As Const.	Plan	As Cons
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			208-00002	EROSION LOG (12 INCH)	ĻF	208		293		1300				455				2256	
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			208-00034	GRAVEL BAG	LF	40		60		486		150		490				1226	
			208-00041	ROCK CHECK DAM	EA									1				1	
			208-00045	CONCRETE WASHOUT STRUCTURE	EA	2		1		1		1		2				7	
			208-00070	VEHICLE TRACKING PAD	EA	2		ţ		4		1		2				7	
			208-00103	REMOVAL AND DISPOSAL OF SEDIMENT (LABOR)	HR	80		80		80		80		80				400	
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			208-00205	EROSION CONTROL SUPERVISOR	DAY	30		30		30		30		30				150	
			208-00301	TEMPORARY DIVERSION	LF									300				300	
			210-00475	RESET CLOSED CIRCUIT TELEVISION POLE	EA									1				1	
			210-00810	RESET GROUND SIGN	EA									1				1	
			210-01050	RESET CHAIN LINK FENCE	ĹF	12												12	
			210-01130	RESET GUARDRAIL TYPE 3	LF					43								43	
			210-02900	RELAY RIPRAP	CY							15						15	
			211-03005	DEWATERING	LS						-					ì		1 -	
			212-00006	SEEDING (NATIVE)	AC	0.3		0.7		0.4				0.25				1.65	
			212-00032	SOIL CONDITIONING	AC	0.3		0.7		0.4				0.25				1.65	

Print Date: 3/18/2013	
File Name: 19358DES_SAQ02.	dgn
Horiz. Scale: 1:1	Vert. Scale: As Noted
Unit Information	Unit Leader Initials
FELSBURG HOLT & ULLEVIG	6300 South Syracuse Way Suite 600 Centennial, CO 80111 (303) 721-1440

Date:	Comments	Init.

Sheet Revisions

l ,	ion
1480 QuailLake Loop Colorado Springs, CD 80806 Phone: 719-227-3201 FAX: 719-22	7-32

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LM	Vc

As Constructed	US 2 SUMMAR		DO CA		Project No.,	/Coc
No Revisions:	SUMIMAN		TITIES	VIMALE	NH 0242-0	56
Revised:	Designer:		Structure		19358	
	Detailer:	KLT	Numbers			
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SUMMARY OF APPROXIMATE QUANTITIES

	Index		Contract Item No.	Contract Item	Unit		Point A d Gulch		Point B ston Gulch		Point C scade		Point H Canyon		Point J ow Falls	Overall Project		Proje	ct Totals
Book	Page	Sheet	East of the	A 3 3 4 4 7 7 7 7 7 7 7 7 7 7 7 7 7 7 7 7	150	Plan	As Const.	Plan	As Const.	Plan	As Const.	Plan	As Const.	Plan	As Const.	Plan	As Const.	Plan	As Con
			213-00002	MULCHING (WEED FREE)	AC	0.3		0.7		0.4				0.25				1.65	
			-00000	a resolution for a store	100														
	-		214-00000	LANDSCAPE MAINTENANCE	LS		ļ								-	1		1	
			214-00215	DECIDUOUS TREE (1.5 INCH CALIPER)	EA			45										45	
			214-00450	EVERGREEN TREE (5 GALLON CONTAINER)	EA	13				17								30	
			216-00041	SOIL RETENTION BLANKET (STRAW/COCONUT)	SY	512		1165		2105				563				4345	
			217-00000	HERBICIDE TREATMENT	SY											2000		2000	
			250-00010	ENVIRONMENTAL HEALTH AND SAFETY MANAGEMENT	LS											1		1	
	Ш		304-06000	AGGREGATE BASE COURSE (CLASS 6)	СУ	11		63		23	-			79		50		226	
			403-00721	HOT MIX ASPHALT (PATCHING)	TON											500		500	
			411-10255	EMULSIFIED ASPHALT (SLOW-SETTING)	GAL											10		10	T
			420-00102	GEOTEXTILE (EROSION CONTROL) (CLASS 1)	sy	192		314		1171				540				2217	
			504-06315	GROUND NAIL (15 FOOT)	EA			-			l le district			60				60	
			506-00010	RIPRAP (SPECIAL)	CY									35				35	
			506-00030	GROUTED RIPRAP	CY	51				120								171	
			506-00036	GROUTED RIPRAP (36 INCH) (SPECIAL)	CY									275				275	
			506-00218	RIPRAP (18 INCH)	CY									275				275	
			506-00236	RIPRAP (36 INCH)	CY			90										90	
			506-00412	SOIL RIPRAP (12 INCH)	CY	94		118		423				81				716	
			506-01020	GEOGRID REINFORCEMENT	sy					1				856				856	
			507-00725	SLOPE AND DITCH PAVING (SPECIAL)	CY	22				120			4					142	

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Unit Information	Unit Leader Initials
FELSBURG HOLT & ULLEVIG	6300 South Syracuse Way Suite 600 Centennial, CO 80111 (303) 721-1440

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SUMMARY OF APPROXIMATE QUANTITIES

Index			Contract Item No.	Contract Item	Unit		Point A d Gulch		Point B ton Gulch		Point C scade		Point H Canyon		Point J ow Falls			Project Totals	
Book	Page	Sheet	20090000000			Plan	As Const.	Plan	As Const.	Plan	As Const.	Plan	As Const.	Plan	As Const.	Plan	As Const.	Plan	As Con
			601-01000	CONCRETE CLASS B	CY	43		22		103		15					-	183	
			601-03050	CONCRETE CLASS D (WALL)	CY							13						13	
			602-00000	REINFORCING STEEL	LB							750						750	
			603-01240	24 INCH REINFORCED CONCRETE PIPE (CIP)	LF					154								154	
			603-01420	42 INCH REINFORCED CONCRETE PIPE (CIP)	LF					108								108	
			603-05024	24 INCH REINFORCED CONCRETE END SECTION	EA					4								4	
			603-05042	42 INCH REINFORCED CONCRETE END SECTION	EA					2								2	
			604-50050	INLET GRATING AND FRAME SPECIAL	EA					1								1	
			607-01000	FENCE BARBED WIRE WITH METAL POSTS	LF	120												120	
			607-53172	FENCE CHAIN LINK (72 INCH)	LF									174		4000		4174	
			607-53173	FENCE CHAIN LINK (SPECIAL) (72 INCH)	LF			260										260	
			607-55100	WIRE MESH	SF									52330				52330	
			607-60212	12 FOOT GATE SINGLE (CHAIN LINK)	EA			2										2	
			607-60274	24 FOOT GATE DOUBLE (CHAIN LINK)	EA											Ť		1	
			608-00100	REINFORCED GRASS/CONCRETE POROUS PAVEMENT	SY	354		1598		491								2443	
			609-21020	CURB AND GUTTER TYPE 2 (SECTION II-B)	LF				101					390				390	
			615-00620	LOG DEFLECTOR	EA	-1		1		+								2	
			620-00002	FIELD OFFICE (CLASS 2)	EA											ă		*	
			620-00012	FIELD LABORATORY (CLASS 2)	EA			1								1		1	

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SUMMARY OF APPROXIMATE QUANTITIES

	Index		Contract Item No.	Contract Item	Unit		Point A		Point B ton Gulch		Point C scade		Point H Canyon		r Point J bow Falls	Overa	l Project	Proje	ect Totals
Book	Page	Sheet				Plan	As Const.	Plan	As Const.	Plan	As Const.	Plan	As Const.	Plan	As Const.	Plan	As Const.	Plan	As Cons
			620-00020	SANITARY FACILITY	EA											2		2	
					100														
			625-00000	CONSTRUCTION SURVEYING	LS											1		1	_
			626-00000	MOBILIZATION	LS											1		1	
			626-01000	PUBLIC INFORMATION SERVICES	LS											1		1	
			627-00001	PAVEMENT MARKING PAINT	GAL											5		5	
			630-00000	FLAGGING	HR											125		125	
			630-00007	TRAFFIC CONTROL INSPECTION	DAY											125		125	1
			630-00012	TRAFFIC CONTROL MANAGEMENT	DAY											50		50	
			630-80001	FLASHING BEACON (PORTABLE)	EA											8		8	
			630-80335	BARRICADE (TYPE 3 M-A)(TEMPORARY)	EA											3		3	
			630-80341	CONSTRUCTION TRAFFIC SIGN (PANEL SIZE A)	EA											28		28	
			630-80342	CONSTRUCTION TRAFFIC SIGN (PANEL SIZE B)	EA											50		50	
	Ħ		630-80344	CONSTRUCTION TRAFFIC SIGN (SPECIAL)	SF											64		64	
			630-80355	PORTABLE MESSAGE SIGN PANEL	EA											2		2	
			630-80357	ADVANCED WARNING OR SEQUENCING ARROW PANEL (A)	EA											2		2	
	П		630-80360	DRUM CHANNELIZING DEVICE	EA											250		250	1
			630-80370	CONCRETE BARRIER (TEMPORARY)	LF											3000		3000	
			630-80380	TRAFFIC CONE	EA											250		250	
			630-85000	IMPACT ATTENUATOR (TEMPORARY)	EA											5		5	
			641-10000	SHOTCRETE	SY									139				139	

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SUMMARY OF APPROXIMATE QUANTITIES

Contract Item No.	Contract Item	Unit	Pour Point A Sand Gulch		Pour Point B Wellington Gulch		Pour Point C Cascade		Pour Point H Waldo Canyon				Overal	l Project	Projec	ct Totals
			Plan	As Const.	Plan	As Const.	Plan	As Const.	Plan	As Const.	Plan	As Const.	Plan	As Const.	Plan	As Const.
700-70010	F/A MINOR CONTRACT REVISION	FA											1		1	
700-70016	F/A FUEL COST ADJUSTMENT	FA											1		1	+
700-70019	F/A ASPHALT CEMENT COST ADJUSTMENT	FA											1		1	
700-70034	F/A DOZING	FA											1		1	
700-70380	F/A EROSION CONTROL	FA											1		1	
700-70550	F/A BLADING SHOULDER	FA											1		1	
700-73352	F/A MISCELLANEOUS UTILITY RELOCATIONS	FA											1		1	
	700-70010 700-70016 700-70019 700-70034 700-70380 700-70550	700-70010 F/A MINOR CONTRACT REVISION 700-70016 F/A FUEL COST ADJUSTMENT 700-70019 F/A ASPHALT CEMENT COST ADJUSTMENT 700-70034 F/A DOZING 700-70380 F/A EROSION CONTROL 700-70550 F/A BLADING SHOULDER	700-70010 F/A MINOR CONTRACT REVISION FA 700-70016 F/A FUEL COST ADJUSTMENT FA 700-70019 F/A ASPHALT CEMENT COST ADJUSTMENT FA 700-70034 F/A DOZING FA 700-70380 F/A EROSION CONTROL FA 700-70550 F/A BLADING SHOULDER FA	Contract Item No. Contract Item Unit Sand Plan	Contract Item No. Contract Item Unit Sand Gulch	Contract Item No. Contract Item Unit Sand Gulch Welling	Contract Item No. Contract Item No. Contract Item Unit Sand Gulch Wellington Gulch	Contract Item No. Contract Item No. Contract Item Unit Sand Gulch Wellington Gulch Ca	Contract Item No. Contract Item Unit Sand Gulch Wellington Gulch Cascade	Contract Item No. Contract Item No. Contract Item Unit Sand Gulch Wellington Gulch Cascade Waldow Plan As Const. Plan Pl	Contract Item No. Plan As Const. Plan Plan	Contract Item No. Plan As Const. Plan As Const.	Contract Item No Plan As Const. Plan Pl	Contract Item No. Cont	Contract Item No. Con	Contract Item No. Cont

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1480 Quail Lake Loop
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SEE PROJECT CONTROL SHEET FOR HORIZONTAL CONTROL TO BE USED ON THIS PROJECT.

ALL CONSTRUCTION SHALL BE COMPLETED PER THE COLORADO DEPARTMENT OF TRANSPORTATION (CDOT) STANDARD PLANS AND SPECIFICATIONS, LATEST EDITION, OR AS SHOWN.

UTILITY LINES AS SHOWN ON THE PLAN SHEETS ARE PLOTTED FROM THE BEST AVAILABLE INFORMATION. THE CONTRACTORS ATTENTION IS DIRECTED TO SUBSECTION 105.11 DF THE STANDARD SPECIFICATIONS CONCERNING UTILITIES. THE CONTRACTOR SHALL COMPLY WITH ARTICLE 1.5 OF TITLE 9, CRS ("EXCAVATION REQUIREMENT") WHEN EXCAVATING OR GRADING IS PLANNED IN THE AREA OF UNDERGROUND UTILITIES. THE CONTRACTOR SHALL NOTIFY ALL AFFECTED UTILITIES AT LEAST 2 BUSINESS DAYS, NOT INCLUDING THE ACTUAL DAY OF NOTICE, PRIOR TO COMMENCING SUCH OPERATIONS. THE CONTRACTOR SHALL CONTACT UNCC AT 811 OR 1-800-922-1987 TO HAVE LOCATION OF UNCC REGISTERED LINES MARKED BY MEMBER COMPANIES. ALL OTHER UNDERGROUND FACILITIES SHALL BE LOCATED BY CONTACTING THE RESPECTIVE OWNER. UTILITY SERVICE LATERALS SHALL ALSO BE LOCATED PRIOR TO BEGINNING EXCAVATION OR GRADING.

THE CONTRACTOR SHALL BE RESPONSIBLE FOR THE CONTACTING AND COORDINATING WITH THE APPROPRIATE UTILITY REPRESENTATIVE TO BE ON-SITE DURING POTHOLING. THE CONTRACTOR SHALL REFER TO THE UTILITY SPECIFICATION FOR ADDITIONAL REQUIREMENTS.

ANY CURB AND GUTTER OR ASPHALT OR CONCRETE PAVEMENT, WHICH IS TO REMAIN AND IS DAMAGED AS THE RESULT OF THE CONTRACTOR'S OPERATION, SHALL BE REPLACED AT THE CONTRACTOR'S EXPENSE.

FOR PRELIMINARY PLAN QUANTITIES OF PAVEMENT MATERIALS, THE FOLLOWING RATES OF APPLICATION WERE USED:

A TACK COAT IS REQUIRED BETWEEN LAYERS OF BITUMINOUS PAVEMENT. DILUTED EMULSIFIED ASPHALT FOR TACK COAT SHALL CONSIST OF 1 PART EMULSIFIED ASPHALT AND 1 PART WATER.

WHERE NEW PAVEMENT IS TO ABUT EXISTING PAVEMENT, THE EXISTING PAVEMENT SHALL BE REMOVED TO A NEAT VERTICAL LINE USING A CUTTING SAW OR OTHER METHOD AS APPROVED BY THE ENGINEER. SAW CUTTING ASPHALT WILL NOT BE PAID FOR SEPARATELY, BUT SHALL BE INCLUDED IN THE WORK.

ANY LAYER OF BITUMINOUS PAVEMENT THAT IS TO HAVE A SUCCEEDING LAYER PLACED THEREON SHALL BE COMPLETED FULL WIDTH BEFORE A SUCCEEDING LAYER IS PLACED.

ASPHALT PATCHING SHALL BE TO THE DEPTH OF THE SURROUNDING EXISTING PAVEMENT AS DIRECTED BY THE ENGINEER. THICKNESS OF SUBSEQUENT LIFTS MUST BE EQUAL OR GREATER THAN THE LIFT DIRECTLY ABOVE. THE MINIMUM LIFT THICKNESS SHALL BE 2 AND 3 INCHES RESPECTIVELY.

PRIOR TO PLACING BITUMINOUS PAVEMENT, THE PAVED SURFACE SHALL BE SWEPT AND CLEANED. THIS WILL NOT BE PAID FOR SEPARATELY, BUT SHALL BE INCLUDED IN THE COST OF THE HOT MIX ASPHALT PAVEMENT ITEM.

WATER SHALL BE USED AS A DUST PALLIATIVE WHERE REQUIRED. LOCATIONS SHALL BE AS DIRECTED BY THE ENGINEER. WATER FOR DUST PALLIATIVE WILL NOT BE PAID FOR SEPARATELY, BUT SHALL BE INCLUDED IN THE WORK.

MOISTURE-DENSITY CONTROL WILL BE REQUIRED FOR THE FULL DEPTH OF THOSE EMBANKMENTS ON THIS PROJECT.

EXCAVATION REQUIRED FOR COMPACTION OF BASES OF CUTS AND FILLS WILL BE CONSIDERED AS SUBSIDIARY TO THAT OPERATION AND WILL NOT BE PAID FOR SEPARATELY.

TYPE OF COMPACTION FOR THIS PROJECT WILL BE AASHTO T-99 FOR COHESIVE SOILS AND T-180 FOR GRANULAR SOILS AS DESCRIBED IN SECTION 203.07 OF THE CDOT STANDARD SPECIFICATIONS.

THE MINIMUM THICKNESS OF TOPSOIL SHALL BE 6 INCHES. TOPSOIL SHALL BE OBTAINED FROM A CONTRACTOR SOURCE APPROVED BY THE ENGINEER. IF THE TOPSOIL IS NOT GENERATED WITHIN THE PROJECT LIMITS, IT SHALL BE TREATED WITH AN HERBICIDE APPLICATION AFTER PLACEMENT AND BEFORE NATIVE SEEDING.

TO PROVIDE FOR ADEQUATE SULFATE RESISTANCE IN ALL CONCRETE SUPPLIED FOR THIS PROJECT, SEVERITY OF POTENTIAL EXPOSURE IS CLASS 0. THE CONTRACTOR MAY AT HIS OWN EXPENSE HAVE A CERTIFIED LABORATORY TEST THE SUBGRADE AS PER THE FIELD MATERIALS MANUAL. TESTING SHALL BE THE SAME SCHEDULE AND FREQUENCY AS REQUIRED FOR A PRELIMINARY SOILS SURVEY. THE CONTRACTOR MAY PROPOSE A DIFFERENT CLASS OF EXPOSURE FOR THE PROJECT BASED ON THOSE TEST RESULTS.

THE CONTRACTOR SHALL PROTECT ALL EXISTING SURVEY MONUMENTATION DESIGNATED TO REMAIN FROM DAMAGE DURING CONSTRUCTION OPERATIONS. ANY MONUMENTS DISTURBED BY THE CONTRACTOR THAT ARE NOT DESIGNATED FOR RELOCATION, SHALL BE RESET AT THE CONTRACTOR'S EXPENSE. THE CONTRACTOR AND ENGINEER SHALL NOTE THOSE MONUMENTS IN THE FIELD PRIOR TO CONSTRUCTION. SEE TABULATION OF SURVEY FOR ADDITIONAL INFORMATION.

THIS PROJECT IS COVERED BY A COLORADO DISCHARGE PERMIT SYSTEM - STORMWATER CONSTRUCTION PERMIT (CDPS-SCP). ALL PERMIT REQUIREMENTS SHALL BE ADHERED TO BY THE CONTRACTOR. REFER TO STANDARD SPECIAL PROVISION REVISION OF SECTION 107 - TRANSFER OF STORMWATER PERMIT TO CONTRACTOR FOR ADDITIONAL INFORMATION.

THE CONTRACTOR WILL BE RESPONSIBLE FOR THE ACCEPTANCE AND CONTROL OF ALL SURFACE AND SUBSURFACE DRAINAGE AND GROUNDWATER ENTERING THE WORK AREA. THIS SHALL BE INCLUDED IN THE COST OF THE WORK.

UNLESS OTHERWISE DIRECTED BY THE ENGINEER, THE CONTRACTOR SHALL LIMIT CONSTURCTION ACTIVITIES TO THOSE AREAS WITHIN THE LIMITS OF DISTURBANCE AND/OR TOES OF SLOPE AS SHOWN ON THE PLANS. ANY DISTURBANCE BEYOND THESE LIMITS SHALL BE RESTORED TO ORIGINAL CONDITION BY THE CONTRACTOR AT THEIR OWN EXPENSE. CONSTRUCTION ACTIVITIES IN ADDITION TO NORMAL CONSTURCTION PROCEDURES SHALL INCLUDE THE PARKING OF VEHICLES OR EQUIPMENT, DISPOSAL OF LITTER AND ANY OTHER ACTION WHICH WOULD ALTER EXISTING CONDITIONS.

CONSTUCTION VEHICLES SHALL ACCESS THE PROJECT FROM PUBLIC PROPERTY, NOT FROM ADJACENT PRIVATE PROPERTIES UNLESS DIRECTED BY THE ENGINEER.

THE FIELD OFFICE, LABORATORY AND ASSOCIATED PARKING (MINIMIMUM 8 SPACES) SHALL BE SECURELY FENCED WITH FENCE CHAIN LINK (72-INCH) AND A LOCKING GATE. FIVE SETS OF KEYS FOR LOCKING THE GATE SHALL BE PROVIDED TO THE ENGINEER. THE OFFICE AND LABRATORY SHALL BE LOCATED IN THE RAINBOW FALLS PARKING LOT OFF OF SERPENTINE DRIVE.

THE CONTRACTOR SHALL BE RESPONSIBLE FOR RESTORING THE FIELD FACILITY AND PARKING AREA TO ITS INITIAL CONDITION AT THE CONCLUSION OF THE PROJECT.

THE CONTRACTOR SHALL POST SIGNS INDICATING THE RAINBOW FALLS PARKING AREA AND TRAIL ARE CLOSED TO CARS AND PEDESTRIANS. THE CONTRACTOR WILL BE RESPONSIBLE FOR SECURITY OF THE STAGING AREA.

Print Date: 3/18/2013	Sheet Revisions			Colorado Department of Transportation	As Constructed	US 24 WALDO CANYON GENERAL NOTES				Project No./Code	
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Site Description

Additional information for permitted projects. For information only to fulfill the CDPS-SCP (Colorado Discharge Permit – Stormwater Construction Permit)

- A. <u>Project Site Description</u>: Work includes US24 erosion control mitigation that is required due to results of the 2012 Waldo Canyon fire. Five principal areas adjacent to US24 have been identified by CDOT as requiring erosion and post-fire stormwater mitigation. They are:
 - a. Pour Point A- Sand Gulch- Work includes stabilizing the eroded area at the inlet and outlet ends of an existing box culvert under US24. Maintenance access, a debris rack, and a debris settling area will be constructed.
 - b. Pour Point B- Wellington Gulch- Work includes improving the entrance to an existing corrugated metal pipe. Maintenance access, a debris rack and a debris settling area will be constructed.
 - c. Pour Point C- Cascade- Work includes installing a concrete rundown at the north bank of US24. A debris settling area will also be constructed. A series of existing culverts under US24 will be cleaned and their entrances will be improved. One new US24 culvert will be added.
 - d. Pour Point H- Waldo Canyon- Work includes improving the entrance to an existing corrugated metal pipe. Re-grading and access will be improved.
 - e. Pour Point J- Rainbow Falls Access Road- Fountain Creek bank erosion has occurred due to increased flows since the 2012 fire. Work includes construction of boulder toe wall at the creek and a 450 feet length of adjacent access road. The access road will connect to the existing access located north of Serpentine Drive and end south of Manitou Street. The steep slope between the access and US 24 will be re-graded to a more stable 1 % to 1 slope with a wire mesh cover. A soil nail retaining wall will be constructed at the top of the slope (adjacent to US24). Riprap erosion protection will extend up from the access road to one foot above the 100-year flood elevation.
- B. Proposed Sequencing For Major Activities: Work will include initial stabilization of the site perimeters, diversion of drainages as needed, clearing and grubbing, embankment placement, excavation, boulder or concrete placement, wall construction, grading, slope treatment and final stabilization of the site. Erosion control will be required throughout the construction period. Erosion control devices will be added as listed under section 4C of this document, repaired, modified and maintained as required in order to limit erosion and sedimentation within the project site.
- C. Acres Of Disturbance:

Total area of construction site: 16.66 acres Total area of disturbance: 3.35 acres Acreage of seeding: 2.74 acres

- D. <u>Existing Soil Data</u>: Pendant-Rock outcrop complex, Sphinx, warm-Rock outcrop complex, very slow infiltration rate with high runoff potential when thoroughly wet. The soils consist chiefly of clays that have a high shrink-swell potential, soils that have a high water table, soils that have a claypan or clay layer at or near the surface and soils that shallow over nearly impervious material. These soils have a very slow rate of water transmission.
- E. <u>Existing Vegetation</u>, <u>Including Percent Cover</u>: Existing vegetation consists of native grasses, weeds, sparse trees and shrubs. The estimated percent of ground cover averages about 50 percent cover over the project site.
 Date of survey: November 2012.
- F. <u>Potential Pollutants Sources</u>: See First Construction Activities under Potential Pollutant Sources. The ECS shall prepare a list of all potential pollutants and their locations in accordance with subsection 107.25.
- G. Receiving Water:
 - Outfall locations: The plan sheets show the outfall locations. The ultimate outfall is to Fountain Creek via existing tributary culverts, swales and sheet flows from the US 24 embankment adjacent to Fountain Creek.
 - 2. Names of receiving water(s) on site and the ultimate receiving water: Fountain Creek

- 3. Distance ultimate receiving water is from project: Varies between 0 and 1000 feet.
- 4. Does the receiving water have an approved TMDL: No
- H. Allowable Non-Stormwater Discharges: It is anticipated that dewatering may be required due to shallow ground water in areas of the Fountain Creek Access Road. There are no other anticipated allowable sources of non-stormwater components of the discharge, such as uncontaminated springs, landscape irrigation return flow, dust suppression and fire fighting. Dewatering shall be included in the cost of the work and will not be paid for separately. If encountered, that contractor shall take the following measures:
 - 1. Groundwater and stormwater dewatering: Discharge to the ground of water from construction dewatering activities may be authorized provided that:
 - a. The source is groundwater and/or groundwater combined with stormwater that does not contain pollutants.
 - b. The source and BMPs are identified in the SWMP.
 - c. Discharges do not leave the site as surface runoff or to surface waters.
 - If discharges do not meet the above criteria a separate permit from the Department of Health will be required. Contaminated groundwater requiring coverage under a separate permit may include groundwater contaminated with pollutants from a landfill, mining activities, industrial pollutant plumes, underground storage tank, etc.

I. Environmental Impacts:

- 1. Wetland Impacts: Yes
- 2. Stream Impacts: Yes
- 3. Threatened and Endangered Species: No

Site Map Components

Pre-construction

- A. Construction Site Boundaries: See Grading and Erosion Control Plans.
- B. All Areas Of Ground Surface Disturbance: See Grading and Erosion Control Plans.
- C. Areas Of Cut And Fill: See Grading and Erosion Control Plans.
- D. Location Of All Structural BMPs Identified In The SWMP: See Grading and Erosion Control Plans.
- E. Location of Non-Structural BMPs As Applicable In The SWMP: See Grading and Erosion Control Plans.
- F. Springs, Stream, Wetlands And Other Surface Water: See Grading and Erosion Control Plans.
- G. Protection of Trees, Shrubs, Cultural Resources And Mature Vegetation: See Grading and Erosion Control Plans.
- 3. SWMP Administrator For Design: Edward L. Lind, P.E., Water Resources Engineer for Felsburg Holt & Ullevig, is responsible for developing the SWMP sheets during the design.

4. Stormwater Management Controls First Construction Activities

The Contractor Shall Perform The Following:

- A. <u>Designate A SWMP Administrator/Erosion Control Supervisor</u> (To be filled out at time of construction; designate the individual(s) responsible for implementing, maintaining and revising SWMP, including the title and contact information. The activities and responsibilities of the administrator shall address all aspects of the projects SWMP.)
- B. <u>Potential Pollutant Sources</u>: Evaluate, identify and describe all potential sources of pollutants at the site in accordance with subsection 107.25 and place in the SWMP notebook. All BMPs related to potential pollutants shall be shown on the SWMP site map by the contractor's ECS.
- C. <u>Best Management Practices</u> (BMPs) For Stormwater Pollution Prevention Phased BMP Implementation

During design: fields are marked when used in the SWMP. During construction: the ECS shall update the checked boxes to match site conditions. Clearly describe the relationship between the phases of construction and the implementation of BMP controls. Add a narrative to the table or to the site map describing why the BMPs are being used in specific locations.

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File Name: 19358DES_SWMP01.dgn		Date:	Comments	Init.	Color ado Depar tillent of Transportation		STORMWATER MANAGEMENT PLAN	NII 0010 050
Horiz. Scale: 1:1 Vert. Scale: As Noted					DOT 1480 QuailLake Loop	No Revisions:		NH 0242-056
Unit Information Unit Leader Initials					Colorado Springs, CD 80806	Revised:	Designer: CDT Structure	19358
FELSBURG South Syracuse Way					DEPARTMENT OF TRANSPORTATION Phone: 719-227-3201 FAX: 719-227-3298		Detailer: KLT Numbers	
HELSBURG Suite 600 HOLT & Centennial, CO 80111 ULLEVIG (303) 721–1440	0				Region 2 LM	Void:	Sheet Subset: EROSION Subset Sheets: SW-1 of	3 Sheet Number 10

Structural BMP practices for erosion and sediment control; practices may include, but are not limited to:

ВМР	TYPE OF CONTROL	BMP as Designed	on	FIRST CONSTRUCTI ON ACTIVITIES	DURING CONSTRUCTION	INTERIM/FINAL STABILIZATION
Earth Berm/Diversion	erosion	×		×	x	
Check Dams	sediment					
Silt Fence	sediment	×		×	x	
Erosion Logs	sediment	×		×	x	х
Temporary Sediment Trap/Basin	sediment	×		×	x	
Permanent Sediment Trap/Basin	sediment					
Embankment Protector	erosion					
Inlet Protection	erosion					
Outlet Protection	erosion					
Concrete Washouts	construction	x		×	x	
Stabilized Construction Entrance	construction	×		×	x	
Dewatering	sediment	×			x	
Temporary Stream Crossing	erosion	x		×	×	
Other		7				

NON-STRUCTURAL BMP practices for erosion and sediment control; practices may include, but are not limited to:

вмр	Type Of	BMP As Designed	In Use On Site	First Construction Activities	During Construction	Interim/Final Stabilization
Surface Roughening/Grading Techniques	Erosion	x		×	x	x
Seeding Permanent	Erosion	×				×
Seeding Temporary	Erosion	×			×	
Mulch/Mulch Tackifier	Erosion	×			×	×
Soil Binder	Erosion	×			x	
Soil Retention Blanket	Erosion	×			×	×
Vegetative Buffer Strips	Erosion	×		×	×	x
Protection Of Trees	Erosion	×		×	x	
Preservation Of Mature Vegetation	Erosion	×		×	×	х
Other						

- Erosion control devices are used to limit the amount of erosion on site.
- · Sediment control devices are designed to capture sediment on the project site,
- · Construction control are BMPs related to construction access and staging.
- BMP locations are indicated on the erosion control plans.
- BMP installation details and general narratives are in the SWMP notebook.

D. Offsite Drainage (Run On Water)

1. Describe and record BMPs on the SWMP site map that has been implemented to address runon water in accordance with subsection 208.03.

E. Stabilized Construction Entrance/Vehicle Tracking Control

1. BMPs shall be implemented in accordance with subsection 208.04.

F. Perimeter Control

- 1. Perimeter control shall be established as the first item on the SWMP to prevent the potential for pollutants leaving the construction site boundaries, entering the stormwater drainage system, or discharging to state waters.
- 2. Perimeter control may consist of vegetation buffers, berms, silt fence, erosion logs, existing landforms, or other BMPs as approved.
- 3. Perimeter control shall be in accordance with subsection 208.04.

During Construction

Responsibilities of the SWMP administrator/erosion control supervisor during construction.

The SWMP should be considered a "living document" that is continuously reviewed and modified. During construction, the following items shall be added, updated, or amended as needed by the SWMP Administrator/Erosion Control Supervisor (ECS) in accordance with section 208.

- A. Materials Handling and Spill Prevention
- B. Stockpile Management
- C. Grading and Slope Stabilization
- D. Surface Roughening
- E. Vehicle Tracking
- F. Temporary Stabilization
- G. Concrete Washout- Concrete washout water or waste from field laboratories and paving equipment shall be contained in accordance with subsection 208.05.
- H. Saw Cutting
- I. New Inlet/Culvert Protection
- J. Street Cleaning

Inspections

A. Inspections shall be in accordance with subsection 208.03 (c).

BMP Maintenance

A. Maintenance shall be in accordance with subsection 208.04 (e).

Record Keeping

A. Records shall be in accordance with subsection 208.03 (c).

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Unit Information	Unit Leader Initials			
FELSBUR				
HOLT				

Colorado Department of Transportation 1480 QuailLake Loop

Colorado Springs, CD 80806 Phone: 719-227-3201 FAX: 719-227-3298 Region 2

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As Constructed		24 WAL		NYUN FNT PLAN	Project No.	/Code
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9. Interim And Final Stabilization

A. Seeding Plan

Soil preparation, soil conditioning or topsoil, seeding (native), mulching (weed free), and mulch tackifier will be required for the area of disturbed area within the right-of-way limits which are not surfaced. The following types and rates shall be used:

COMMON NAME	BOTANICAL NAME	LBS, PLS PER ACRE
Blue grama	Bouteloua gracilis 'Hachita'	0.5
Arizona fescue	Festuca arizonica 'Redondo'	1.0
Sheep fescue	Festuca ovina	0.6
Canada wildrye	Elymus canadensis	6.2
Sandberg bluegrass	Poa sandbergii	0.2
Western wheatgrass	Pascopyrum smithii 'Rosanna'	6.5
Mountain brome	Bromus marginatus 'Bromar'	4.0
Prairie junegrass	Koeleria macrantha	0.1
Slender wheatgrass	Elymus trachycaulus ssp. trachycaulus 'Pryor'	1.0
Oats	Avena sativa	3.0
TOTAL		23.1

- A. Seeding Application: Drill seed 0.25 inch to 0.5 inch into the soil. In small areas not accessible to a drill, hand broadcast at double the rate and rake 0.25 inch to 0.5 inch into the soil. In areas as directed by Engineer, hydro-seed shall be applied at double the rate, in a single slurry which contains seed, mulch tackifier, humate and fertilizer. Slurry shall be applied from top of slope downward, in 50' vertical lifts unless otherwise approved by the Engineer.
- B. Mulching Application: Apply a minimum of 1 % tons of certified weed free native hay per acre and in accordance with Section 212, and mechanically crimp it into the soil in combination with an organic mulch tackifier.
- C. Soil Conditioning and Fertilizer Requirements: [Minimum requirements for all disturbances to receive seeding (native).

Soil conditioner pa	id for as Item 212- Soil	Conditioning (Acre)
Biological nutrient organi based fertilizer (lbs/acre)*	c Humate (lbs/acre)	
699	200	

*Biological nutrient shall not exceed 8-8-8 (N-P-K). Humate based material shall be in accordance to Section 212.

- F. <u>Blanket Application</u>: On slopes and ditches requiring a blanket, the blanket shall be placed in lieu of mulch and mulch tackifier. See SWMP for blanket locations.
- G. Reseeding Operations/Corrective Stabilization:

Prior to Final Acceptance:

- Seeded areas shall be reviewed during the 14 day inspections by the Erosion Control Supervisor for bare soils caused by surface or wind erosion. Bare areas caused by surface or gully erosion, blown away mulch, etc. shall be regraded, seeded, mulched and have mulch tackifier (or blanket) applied as necessary.
- Areas where seed has not germinated after one season shall be evaluated by the Engineer and CDOT Landscape Architect. Areas that have not germinated shall have seed, mulch and mulch tackifier (or blanket) applied. Work shall be paid for by the appropriate bid item.
- The Contractor shall maintain seeding/mulch/tackifier, mow to control weeds or apply herbicide to control weeds in the seeded areas until final acceptance.

10. Prior To Final Acceptance

A. Final acceptance shall be in accordance with subsection 208.061.

Print Date: 3/18/2013		Sheet Revisions			Colorado Department	of Transportation	As Constructed	1	24 WAL			Project No.,	./Code
File Name: 19358DES_SWMP03.dgn Horiz. Scale: 1:1 Vert. Scale: As Noted		Date:	Comments	Init.		·	No Revisions:	STURMWA	ILK MA	ANAGEN	MENT PLAN	NH 0242-0	056
Unit Information Unit Leader					C DOT 1480 Quail Lal Colorado Spri	ngs, CD 80806	Revised:	Designer:	CDT	Structure		19358	
FELSBURG 6300 South Syracuse Way Suite 600 HOLT & Centennial, CO 80111					DEPARTMENT OF TRANSPORTATION Phone: 719-22	7-3201 FAX: 719-227-3298		Detailer:		Numbers			
HOLT & Centennial, CO 80111 ULLEVIG (303) 721-1440		1			Region 2	LM	Void:	Sheet Subset:	EROSION	Subset Sh	heets: SW-3 of 3	Sheet Number	12

TO ESTABLISH GEOMETRIC CONTROL FOR PROJECT, THE DEPARTMENT HAS PROVIDE						Pavements — ■ HMA - Hot Mix Asphalt (Section 403)	Grid S (Y/N) In	pecial Special terval Offset	_	Pavement Marking (Section Striping (Temp)	n 627)	
Horizontal Control Vertical Control Roadway Alignment Original Terrain Data Other:		_				— Concrete (Section 412) — Heating & Scarifying Treatment — Prime Coat, Tack Coat & Rejuvenating (Section 407) — Seal Coat or Chip Seal (Section 409) — Other:	Agent		_	🗀 Light pole locat	itions and elevations (Temp)	es (Section 630)
 Specify the information format, ie., plan she The information marked is either contained of 						■ Roadway Elements	ကြည်း Interval In	Curve Special terval Offset		— □ Sign Locations □ □ Other: □ □ Easements (Temp Staking	<u>'</u>	
TYPE OF PROJECT Landscaping	Major Recor	actruction			_	Curb and Gutter (Section 609) Drop inlets -	Cur		_	— ■ Right of Way (Temp Sta	, ,	
Signalization Safety Improvement Asphalt Overlay Concrete Overlay	New Roadwa Bridge Repla Bridge Wider New Bridge	ay Constructio acement ning				alignment and grades (Section 60 Retaining Walls Guard Rail (Section 606) Sidewalk (Section 608) Overlay Stationing Other: Cutoff Walls	p Left (Center Right terval Interval		PERFORMED BY THE CON Monumentation (Section 6 Control Right of Way		NDER SECTION 629:
•		Š	Š			Riprap (Perm) (Section 506)				□ Land corners, , □ Easements	'	
SURVEY WORK TO BE PERFORMED BY OTHERS:						■ Slope and Ditch Paving (Section 507) ■ Minor Structures				Replace the sp	specified existing monuments:** - ecified existing monuments: ** - nts. It is estimated hours o	
WORK PERFORMED BY THE CONTRACTOR'S — Establish and Maintain Project Centerline	or Engineer	Approved Of			_	Structure Excavation limits (Section 206 Culverts (Section 603) Culverts w/ Headwalls and Wingwalls (Se				NOTE: All 629 items shall i of evidence for m	nclude adequate research, calculat onuments to be set.	ions, and evaluations
 Verification and Maintenance of Horizont Verify or Determine existing grades and Verify or Determine existing topography 	alignments	cal Control				Concrete Box Culverts w/ Headwalls an			GENERAI	** A Tabulation of Surve L NOTES:	ey Monuments may be provided (on the plans.
— Clearing and Grubbing Limits (Section 20 — Removal Limits (Section 202))1)					Sanitary Sewer Storm Sewer Water			1. Unless	indicated otherwise on this Survey ne in accordance with the latest edit		d staking intervals shall
— Reset Items (Section 210) — Excavation and Embankment (Section 20 — Excavation)3) Slop	oe Staking (Y/N) (Grade Special Stakes Interval		☐ ☐ Irrigation ☐ ☐ Miscellaneous ☐ ☐ Manholes (Section 604)			on the	ate information for establishing lines, plans. Any additional information req intractor's surveyor.	grades, and locations for all work it uired to stake the item or elemen	ems have been specified t shallbe generated by
— Unclassified	Excavation	- - - -	- - -			☐ ☐ Inlets (Section 604) ☐ ☐ Other: ☐ ☐ Other: ☐ ☐ ☐ ☐ ☐ ☐ ☐ ☐ ☐ ☐ ☐ ☐ ☐ ☐ ☐ ☐ ☐ ☐ ☐			3. The Col items i blank li	ntractor's surveyor shall provide an indicated on this sheet. A copy of the to the left of the specified itemer7 days prior to the Presurv	nis sheet, with the estimated man-h s, shall be submitted with the Surve	ours written on the y Schedule to the
— □ Other: — Potholing		-	-			and all other structures assig Structure Excavation limits (Section 200 Concrete Box Culverts (Section 603) w	6)			and Monuments which are damaged ed by the Contractor at no addition		construction shall be
	Embankment	- - -	- - -			 Piling locations and cut off elevations (Sectic Caisson locations and elevations (Sectic Footing locations, alignment, and elevati Abutment/Pier locations, alignment, and Wingwall skew angles/offsets 	Section 502) on 503) ons	ins (Section 66)	twenty copy o	ntractor shall furnish an As Staked e percent (20%) of the planned earth of the As Staked earthwork data an Engineer. The Contractor shall field ils.	work in any phase as per the CDOT d a computer disk in the specified	Survey Manual. A printed format shall be submitted
(See General Notes)						 Structural concrete form locations Substructure As-constructed survey required for Bridges (Subsection 	601 .12) and Overhead	sians (S-614-50)	6. Prior to Contra	o beginning work on any subsequent ctor shall certify in writing to the Er	operation, such as placing base congineer that the final grade is within	urse or paving, the specified tolerance.
L Landscaping T Top Soil (Section 207) Seeding (Section 212)						□ Bridge expansion joint(s) alignment and □ Deck grades at Girder 10th or "n" th □ Slope and Ditch Paving (Section 507)	grade (longitudinal and	transverse)	into fie	ntractor's surveyor shall perform al eld grades.	, ,	, , ,
Mulching (Section 213) Planting (Section 214) Herbicide (Section 217) Other: Section 208) Seeding (Temp) Silt Fence Frosion Bales					_	 Other: Ground Nailed Wall, Geogrid Rei Fencing (Section 607) Temporary Permanent Sound Barrier Other: 	nforcement, Wire Mesh		9. Fieldbo shall co informo copy f linear s measur	ntractor shall coordinate construction obes shall contain daily records of prontain: date, crew members' names, pation is collected electronically, inforformat that is intuitive, clear and relative, such as slope stakes and the red information. Non-linear surveys station, such as point numbers, to the	oints set and or measurements obsection too., description, staking information recorded shall be provided the steed to the supplemental information libe tops, shall have the station and such as structures staking shall have	erved. The information recorded tion, and sketches. If the survey o the Project Engineer in a hard recorded in the field books. All offset information related to the
■ Erosion Logs □ Riprop (Temp)						☐ Delineators (Section 612) ☐ ☐ Temporary ☐ ☐ Permanent				intractor's surveyor shall submit the	,	:
Other: Rock Check Dam, Tem Roadway Bases Untreated Subgrade Treated Subgrade	porary Divers		Grade (Y/N)	Special Special Interval Offset	_	☐ Lighting (Section 613) and Traffic Control Devices ☐ ☐ Signal pole locations and elevations ☐ ☐ Light pole locations and elevations	(Permanent) (Section	614)	■ V ■ P ■ H	lorizontal Control (Primary & Secon /ertical Control (i.e. Benchmarks) Property Pin Ties lorizontal Alignment	aary)	
—	녉		- - -			Sign locations Field verify sign post locations, elevation Other:	ons, and lengths before	fabrication.	S M M	Grading Blope Staking Minor Structures Major Structures		
	_	<u>'</u>	'							One fieldbook for each work catego Other Fieldbook(s):	ry shown on this sheet	
Print Date: 4/22/2013	I		She	et Revisions		Colorado Department of Trans	portation	As Constr	ucted		DO CANYON	Project No./Code
File Name: 19358SURV_TabC.dgn Horiz. Scale: 1:1 Vert. Scale: As Note	ed (R=3)	Date: 04-22-13	REVIS	Comments SED SHEET NUMBER	Init.	-l '	por tation	No Revisions:			ABULATION EET	NH 0242-056
Unit Information Unit Leader Initial						1480 QuailLake Loop Colorado Springs, CD 808 Phone: 719-227-3201 FAX	306 (: 719-227-3298	Revised:		Designer:	Structure Numbers	19358
FELSBURG Sittle 600 H O L T & Centennial, CO 80111 ULLEVIG (303) 721-1440	00					Region 2	LM	Void:		Detailer: Sheet Subset: SURVEY	Subset Sheets: SRV 1C of 1	Sheet Number 13C

SUMMARY OF CONSTRUCTION TRAFFIC CONTROL ITEMS

	CONSTRUCTION TRAFFIC SIGNS (FOR INFORMATION	ONLY)	8-		
SIGN CODE	LEGEND	DIMENSIONS	OVERALL PROJECT		
			EACH	PANEL SIZE	
G20-5P	WORK ZONE	36" X 24"	10	Α	
R2-1(45)	SPEED LIMIT	36" X 48"	8	Α	
R2-1(50)	SPEED LIMIT	36" X 48"	5	Α	
R2-6P	FINES DOUBLE	36" X 24"	5	В	
R4-1	DO NOT PASS	36" X 48"	5	В	
R4-2	PASS WITH CARE	36" X 48"	3	A	
R52-6A	BEGIN FINES DOUBLE	36" x 48"	4	В	
R52-6B	END FINES DOUBLE	36" x 48"	4	В	
W4-2(R)	RIGHT LANE CLOSED SYMBOL	48" X 48"	3	В	
W21-5(R)	RIGHT SHOULDER CLOSED	48" X 48"	5	В	
W4-2(L)	LEFT LANE CLOSED SYMBOL	48" X 48"	3	В	
W20-1	ROAD WORK/ (DISTANCE/AHEAD)	48" X 48"	2	В	
W20-5(R)	RIGHT LANE CLOSED	48" X 48"	3	В	
W20-5(L)	LEFT LANE CLOSED	48" X 48"	3	В	
W20-7a	FLAGGER AHEAD (SYMBOL)	48" X 48"	4	В	
W21-1	WORKER (SYMBOL)	48" X 48"	4	В	
W16-2A	1500 FEET	24" X 36"	1	Α	
SPECIAL	PARKING LOT CLOSED	48" X 48"	2	В	
SPECIAL	TRAIL CLOSED	48" X 48"	2	В	
		SIGN TOTALS	76		

GENERAL CONSTRUCTION TRAFFIC CONTROL NOTES

- 1. THE CONTRACTOR SHALL BE RESPONSIBLE FOR ALL TRAFFIC CONTROL REQUIRED ON THE PROJECT. ALL TRAFFIC CONTROL DEVICES, TEMPORARY CONSTRUCTION SIGNS, PAVEMENT MARKINGS AND CHANNELIZING DEVICES SHALL CONFORM WITH THE LATEST MUTCD AND THE COOT M & S STANDARDS. THE PROJECT TRAFFIC CONTROL SUPERVISOR SHALL COORDINATE CONSTRUCTION ZONE TRAFFIC CONTROL ACTIVITIES WITH ALL APPROPRIATE AGENCIES AND ANY OTHER NEARBY CONSTRUCTION PROJECTS.
- 2. THE CONTRACTOR SHALL MAINTAIN MINIMUM 11 FOOT LANES DURING CONSTRUCTION, UNLESS OTHERWISE DIRECTED BY THE ENGINEER.
- 3. FLASHING BEACON (PORTABLE) SHALL BE INSTALLED ON "ROADWORK 1 MILE", AND "LANE CLOSED 1/2 MILE" ADVANCE WARNING SIGNS.
- 4. PORTABLE MESSAGE SIGN PANELS SHALL BE USED AS NECESSARY, AND ONLY AS APPROVED BY THE
- 5. VEHICLE ACCESS SHALL BE MAINTAINED FOR ALL STREETS, BUSINESSES AND PROPERTIES WITHIN THE PROJECT LIMITS.
- 6. OPEN EXCAVATIONS SHALL NOT BE ALLOWED TO BE UNPROTECTED WHEN CONSTRUCTION WORK IS NOT IN PROGRESS (INCLUDING OVERNIGHT, WEEKENDS, AND HOLIDAYS). METHOD(S) OF PROTECTING PEDESTRIANS AND TRAFFIC FROM EXCAVATIONS, SUCH AS METAL PLATES OR CONCRETE BARRIER, SHALL BE APPROVED BY THE ENGINEER. THE COST FOR PROTECTING EXCAVATIONS WILL NOT BE MEASURED AND PAID FOR SEPARATELY BUT SHALL BE INCIDENTAL TO THE PROJECT.
- 7. NO VERTICAL FACES GREATER THAN 3 INCHES SHALL BE LEFT WITHIN 6 FEET OF ANY TRAVEL LANE DURING NON-WORKING HOURS. ANY WORK AND MATERIAL NECESSARY TO PLACE A TEMPORARY FILL SLOPE FOR DROP-OFFS GREATER THAN 3 INCHES SHALL BE CONSIDERED INCIDENTAL TO THE WORK. ANY TEMPORARY FILL SLOPES SHALL HAVE A SLOPE NO STEEPER THAN 3:1.
- 8. ANY EXISTING SIGNS THAT CONFLICT WITH TEMPORARY SIGNS SHALL BE MASKED OR REMOVED. THE COST FOR MAINTAINING, RELOCATING, OR MASKING EXISTING SIGNS DURING CONSTRUCTION IS INCLUDED IN THE PRICE OF WORK.
- 9. FLAGGER SYMBOL SIGNS SHALL BE INSTALLED AND FLAGGERS SHALL BE UTILIZED ONLY AS DEEMED NECESSARY, AND ONLY AS APPROVED BY THE ENGINEER.
- 10. CONSTRUCTION WORK ON THE PROJECT SHALL NOT BEGIN UNTIL ALL ADVANCE CONSTRUCTION SIGNS ARE IN PLACE AND APPROVED BY THE PROJECT ENGINEER.
- 11. THE CONTRACTOR SHALL MAINTAIN EXISTING TRAFFIC SIGNS AND PRIVATE BUSINESS SIGNS AS NECESSARY TO ACCOMMODATE NEW CONSTRUCTION AND TRAFFIC MOVEMENTS AS APPROVED BY THE PROJECT ENGINEER. THIS SHALL BE DONE FOR THE DURATION OF THE PROJECT.
- 12. THE CONTRACTOR SHALL BE RESPONSIBLE FOR MAINTAINING TRAFFIC DURING CONSTRUCTION. THE CONTRACTOR SHALL SUBMIT FOR APPROVAL, PRIOR TO COMMENCING WORK, A METHOD OF HANDLING TRAFFIC
- 13. ALL TRAFFIC SHALL BE AS PER THE TRAFFIC CONTROL PLANS DEVELOPED BY THE CONTRACTOR, OR AS APPROVED BY THE PROJECT ENGINEER.
- 14. SIGNS SHALL NOT BE MOUNTED, FASTENED, OR ATTACHED TO ANY CHANNELIZING DRUMS OR CONES.
- 15. THIS PROJECT IS CLASSIFIED AS NON-SIGNIFICANT. THE CONTRACTOR SHALL FOLLOW 630 SPECIFICATIONS. THE TRANSPORTATION MANAGEMENT PLAN (TMP) PREPARED BY THE CONTRACTOR SHALL CONSIST OF A TRAFFIC CONTROL PLAN (TCP).
- 16. CONSTRUCTION INFORMATION SIGNS SHALL BE PLACED AT BEGINNING AND END OF OVERALL PROJECT.
- 17. STANDARD PLAN S-630-1 SHALL BE USED FOR CONSTRUCTION TRAFFIC CONTROL AS FOLLOWS:
 - POUR POINTS A AND B, USE CONTRACTORS MHT.
 - POUR POINT C, USE TRAFFIC CONTROL PLANS AND CONTRACTORS MHT.
 - POUR POINT H, USE TRAFFIC CONTROL PLANS.
 - POUR POINT J, USE TRAFFIC CONTROL PLANS.
- 18. A VMS SIGN SHALL BE PLACED AT EACH END OF THE PROJECT GIVING PROJECT INFORMATION; MESSAGE SHALL BE AS DIRECTED BY THE ENGINEER.



THE CONTRACTOR SHALL MAINTAIN TWO LANES OF TRAFFIC DURING THE WEEKDAY FROM 7AM TO 9AM AND 4PM TO 6PM. NO LANE CLOSURES SHALL BE PERMITTED DURING MEMORIAL DAY WEEKEND, LABOR DAY WEEKEND, 4TH OF JULY OR ANY OTHER HOLIDAY TRAVEL.

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Unit Information	Unit Leader Initials
FELSBURG HOLT & ULLEVIG	6300 South Syracuse Way Suite 600 Centennial, CO 80111 (303) 721-1440

Date:	Comments	Init.
04-19-13	REVISE NOTES	CDT
04-22-13	REVISED SHEET NUMBER	CDT
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Colorado Department of Transportation

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480 QuailLake Loop olorado Springs, CD hone: 719-227-3201	80806 FAX: 719-227-3298

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TABULATION OF POTHOLES

PLAN SHEET	POTHOLE NUMBER	UTILITY USE	DIAMETER (INCHES)	DEPTH TO TOP (FT)	DEPTH TO BOTTOM (FT)	NORTHING (APPROXIMATE)	EASTING (APPROXIMATE)	GROUND ELEVATION	COMMENTS
A-3	PH1	TELEPHONE	0.5	2.8	2.9	397684.75	146000.36	7642.15	FOUND 1/2" DIRECT BURY TELE
B-2	PH3	TELEPHONE	2	2.8	3.0	396123.35	148056.41	7568.41	FOUND 2" GAS LINE
B-2	PH4	GAS	108	13.0	22.0	396132.79	148086.93	7566.33	TOP OF 108" CMP PLUNGING STEEPLY
B-2	TH1	- D		4.0	6.0	396178.47	148115.98	7466.80	FIRST 4' SANDY GRAVEL, CRUMBLY ERODED ROCK TO 6', SOLID ROCK AT 6'
C-2	PH5	STORM			9.0	393945.78	150109.30	7526.00	NOTHING FOUND
C-2	PH6	GAS			9.0	393934.62	150098.67	7527.94	NOTHING FOUND
C-2	PH6A	WATER			9.0	393924.29	150087.22	7529.79	NOTHING FOUND
C-2	PH7	WATER		5.9	8.0	393658.44	150345.43	7505.74	NOTHING FOUND, PROBED TO 8'
C-2	PH7A	WATER			10.0	393655.40	150338.61	7508.83	NOTHING FOUND, PROBED TO 10'
C-3	PH8	WATER	0.5	5.0	5.1	393606.92	150426.73	7509.13	FOUND 1/2" TELE CONDUIT
C-3	PH9	TELEPHONE	2	5.0	5.3	393600.41	150417.65	7507.61	2" HDPE LINE
C-3	PH10	GAS			10.0	393585.66	150405.32	7504.67	NOTHING FOUND
C-3	PH11	WATER			11.0	393024.52	150963.04	7474.97	NOTHING FOUND
C-4	PH12	WATER		7.5	11.0	393427.65	150568.64	7485.36	NOTHING FOUND, PROBED TO 11'
C-4	PH13	WATER		8.0	10.0	392779.87	151201.75	7476.77	NOTHING FOUND, PROBED TO 10'
C-5	PH14	WATER			10.0	392551.13	151429.38	7482.42	NOTHING FOUND
C-5	PH15	WATER	4	5.3	5.6	392324.49	151649.41	7484.96	4" CONDUT - PROBED TO 10'
C-6	PH16	WATER	8	7.5	8.2	391908.87	151929.95	7484.06	FOUND 8" WATER LINE

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File Name: 19358DES_Pothole	_Tab.dgn	Date:	Comments	Init.
Horiz. Scale: 1:1	Vert. Scale: As Noted			
Unit Information	Unit Leader Initials			
FELSBURG	6300 South Syracuse Way Suite 600			
HOLT & ULLEVIG	Centennial, CO 80111 (303) 721-1440			

Colorado D	epartment of Tr	ansportation
DOT	1480 QuailLake Loop Colorado Springs, CO Phone: 719-227-3201	80806 FAX: 719-227-329

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As Constructed	US 24 WALDO CANYON POTHOLE TABULATION			Project No./Code			
No Revisions:	US24		OUR P			NH 0242-0)56
Revised:	Designer:	CDT	Structure Numbers			19358	
	Detailer:	KLT	Number 5	ĺ			
Void:	Sheet Subset:	MISC	Subset Sh	eets:	PT-1 of 1	Sheet Number	15

POUR POINT A TABULATION

CONTRACT ITEM NO.	CONTRACTITEM	UNIT	QUANTITY
201-00001	CLEARING AND GRUBBING	LS	1
202-00010	REMOVAL OF TREE	EA	13
202-01000	REMOVAL OF FENCE	LF	99
202-04002	CLEAN CULVERT	EA	1.
203-00010	UNCLASSIFIED EXCAVATION (COMPLETE IN PLACE)	CY	893
203-01622	SWEEPING (WITH PICKUP BROOM)	HR	40
207-00205	TOPSOIL	CY	100
208-00002	EROSION LOG (12 INCH)	LF	208
208-00034	GRAVEL BAG	LF	40
208-00045	CONCRETE WASHOUT STRUCTURE	EA	2
208-00070	VEHICLE TRACKING PAD	EA	2
208-00103	REMOVAL AND DISPOSAL OF SEDIMENT (LABOR)	HR	80
208-00105	REMOVAL AND DISPOSAL OF SEDIMENT (EQUIPMENT)	HR	40
208-00205	EROSION CONTROL SUPERVISOR	DAY	30
210-01050	RESET CHAIN LINK FENCE	LF	12
212-00006	SEEDING (NATIVE)	AC	0.3
212-00032	SOIL CONDITIONING	AC	0.3
213-00002	MULCHING (WEED FREE)	AC	0.3
214-00450	EVERGREEN TREE (5 GALLON CONTAINER)	EA	13
216-00041	SOIL RETENTION BLANKET (STRAW/COCONUT)	SY	512
304-06000	AGGREGATE BASE COURSE (CLASS 6)	CY	11
420-00102	GEOTEXTILE (EROSION CONTROL) (CLASS 1)	SY	192
506-00030	GROUTED RIPRAP	CY	51
506-00412	SOIL RIPRAP (12 INCH)	CY	94
507-00725	SLOPE AND DITCH PAVING (SPECIAL)	CY	22
601-01000	CONCRETE CLASS B	CY	43
607-01000	FENCE BARBED WIRE WITH METAL POSTS	LF	120
608-00100	REINFORCED GRASS/CONCRETE POROUS PAVEMENT	SY	354
615-00620	LOG DEFLECTOR	EA	1

NOTE: TREES SHALL BE PLACED AS DIRECTED BY THE ENGINEER.

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воок	PAGE	SHEET	ITEM	PROJECT TOTALS
			EMBANKMENT MATERIAL (CIP) (FOR INFO. ONLY)	CU. YDS.
			SAND GULCH	143
			SUBTOTAL	143
			TOTAL	143
			UNCLASSIFIED EXCAVATION	CU. YDS.
			SAND GULCH	893
			OTHER EXCAVATION	0
			SUBTOTAL	893
			TOTAL FOR PAY QUANTITY	893

COMPACTION (FOR INFORMATION ONLY) (MOISTURE & DENSITY CONTROL) EMBANKMENT (NET)	143
TOTAL	143
WETTING QUANTITIES (FOR INFORMATION ONLY) COMPACTION	M. GAL.
(143 x 0.040 M. GAL./yd) TOTAL	6
ACCESS ROAD QUANTITIES BALANCE (FOR INFORMATION ONLY)	CU. YDS.
EMBANKMENT (NET)	143
EMBANKMENT X FACTOR (1.15)	164
BALANCE TOTAL	164
UNCLASSIFIED EXCAVATION TO BE EXPORTED BY THE CONTRACTOR BALANCE TOTAL	893 -729 164


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Horiz. Scale: 1:1	Vert. Scale: As Noted	
Unit Information	Unit Leader Initials	
FELSBURG	6300 South Syracuse Way Suite 600	(
HOLT & ULLEVIG	Centennial, CO 80111 (303) 721-1440	

Sheet Revisions					
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Colorado Department of Transportation 1480 Quail Lake Loop Colorado Springs, CO 80 Phone: 719-227-3201 FA

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	As Constructed	US 24 WALDO CANYON EARTHWORK QUANTITIES			Project No.	/Code		
	No Revisions:	POUR POINT A - SAND GULCH				NH 0242-0)56	
ſ	Revised:	Designer:		Structure			19358	
ŀ		Detailer:	KLT	Numbers				
⅃	Void:	Sheet Subset:	TAB	Subset She	ets:	A-1 OF 14	Sheet Number	16



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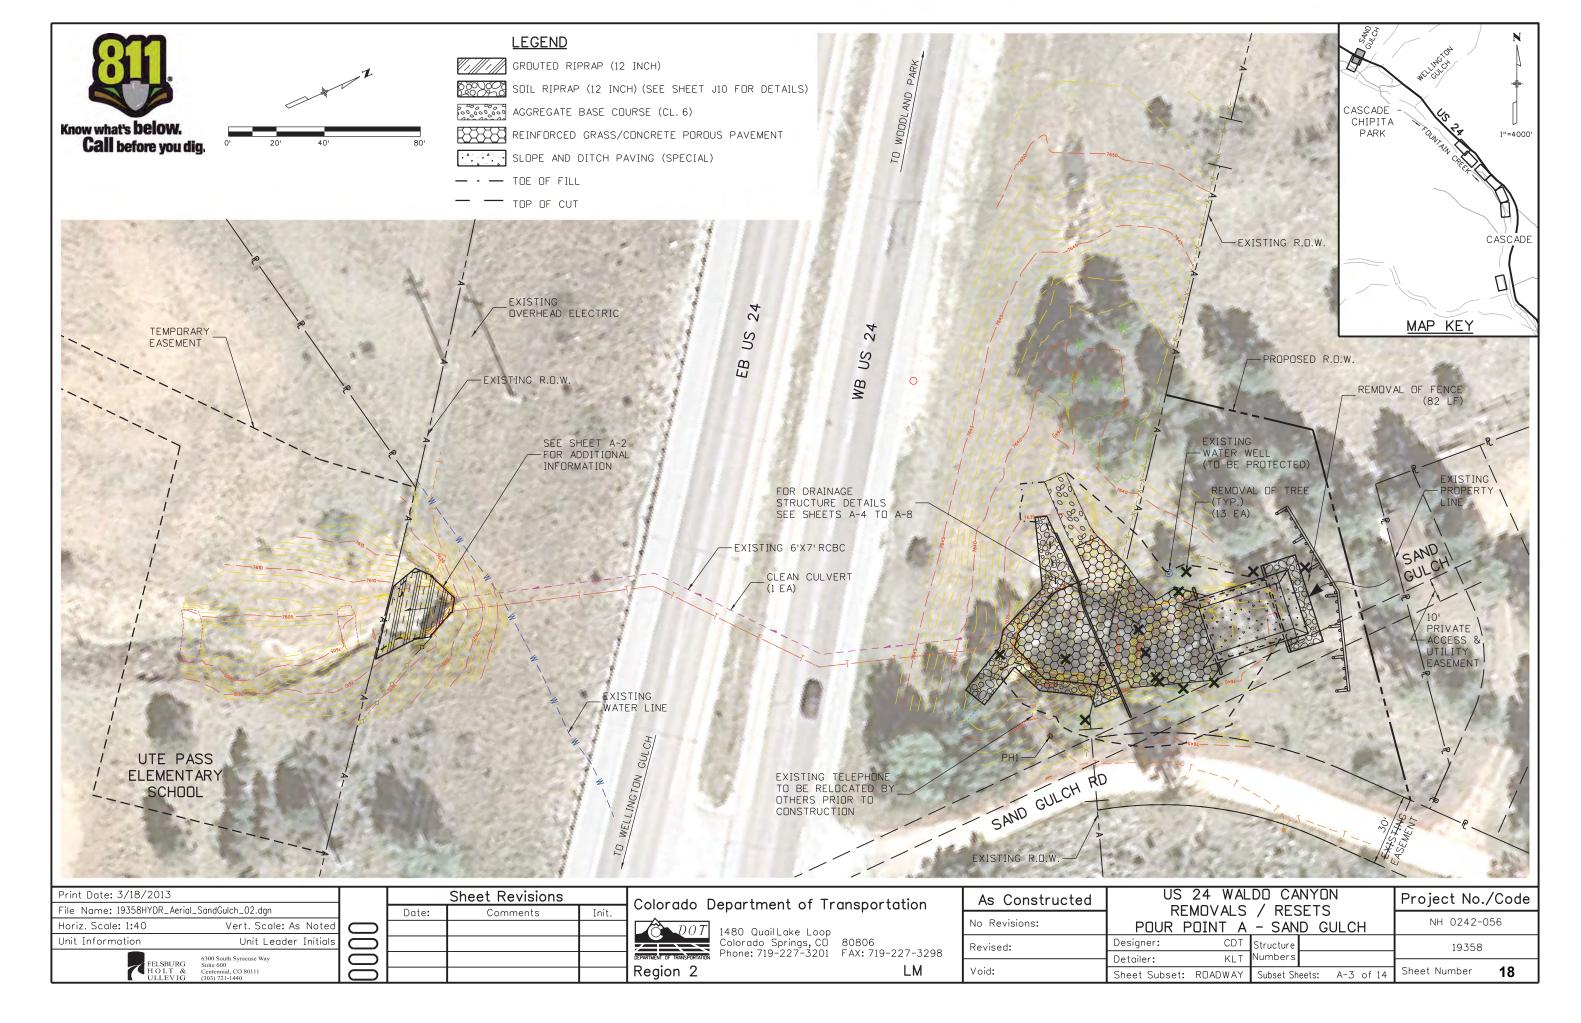
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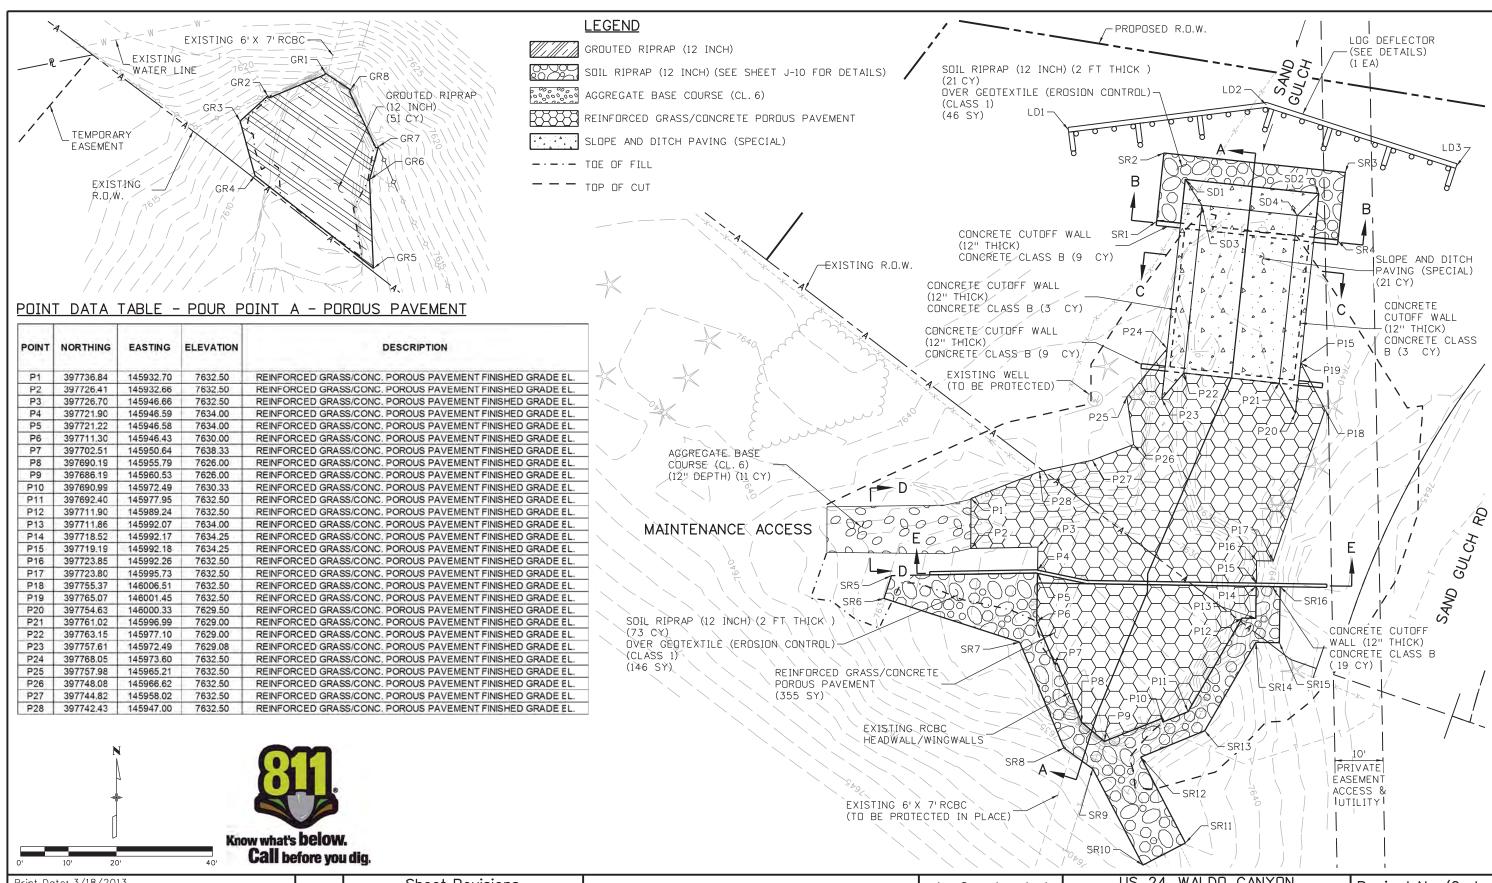
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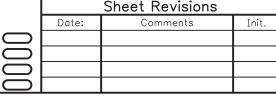
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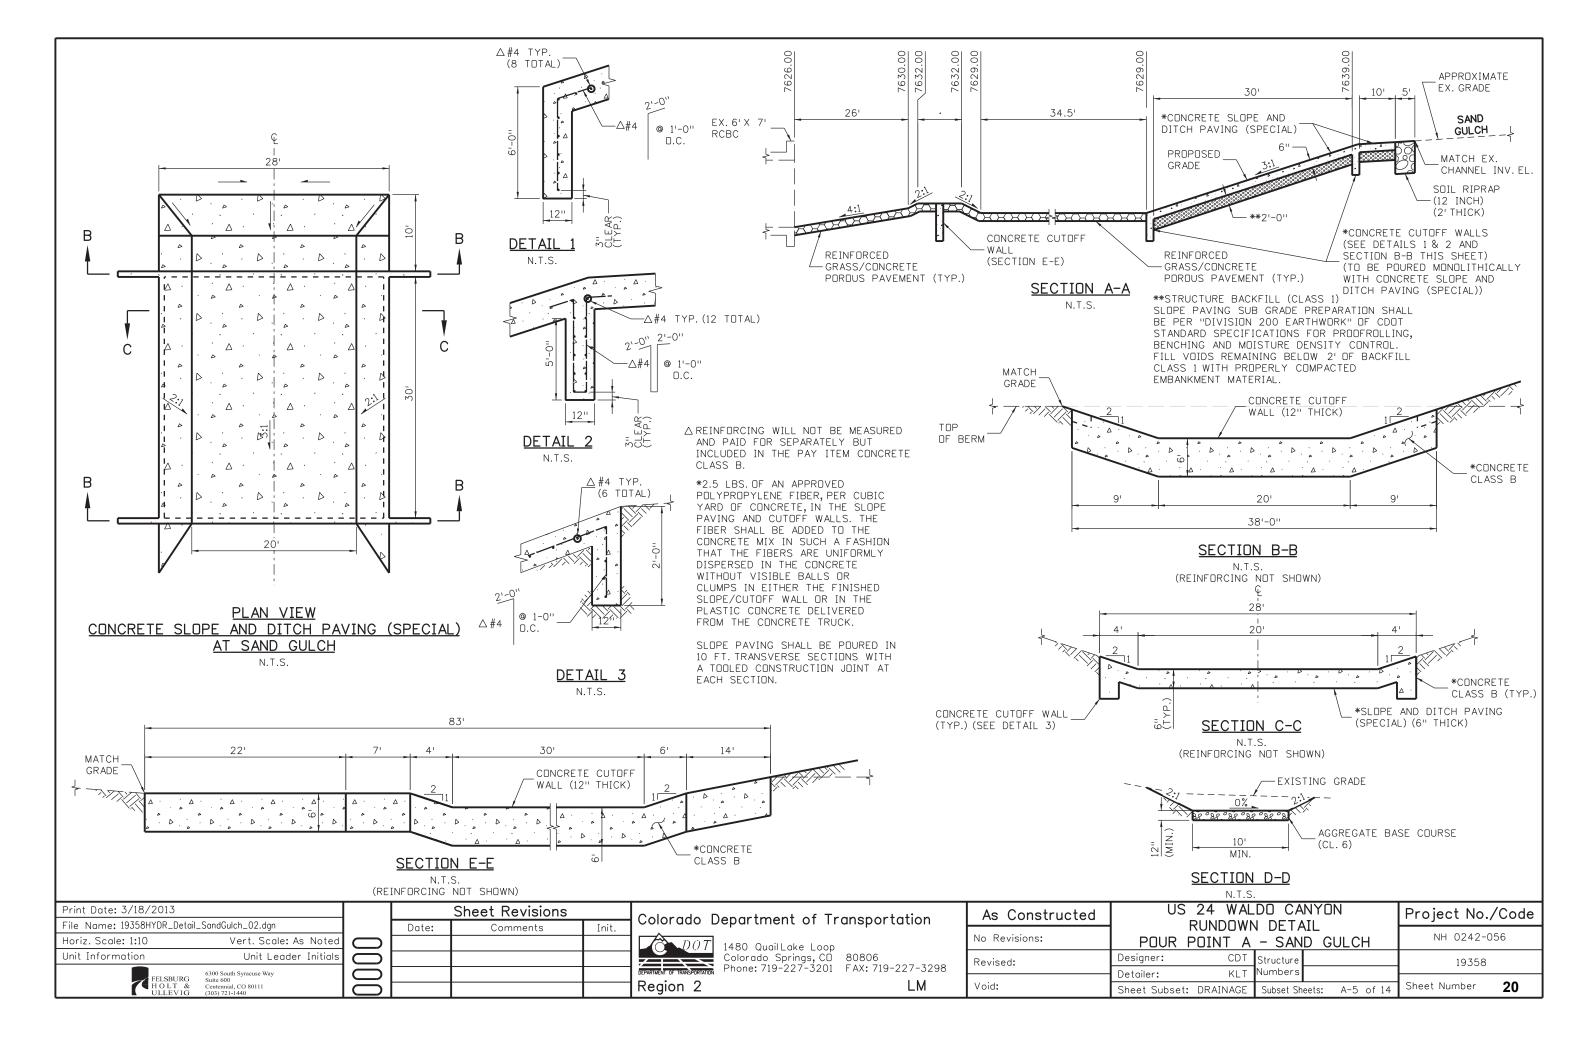


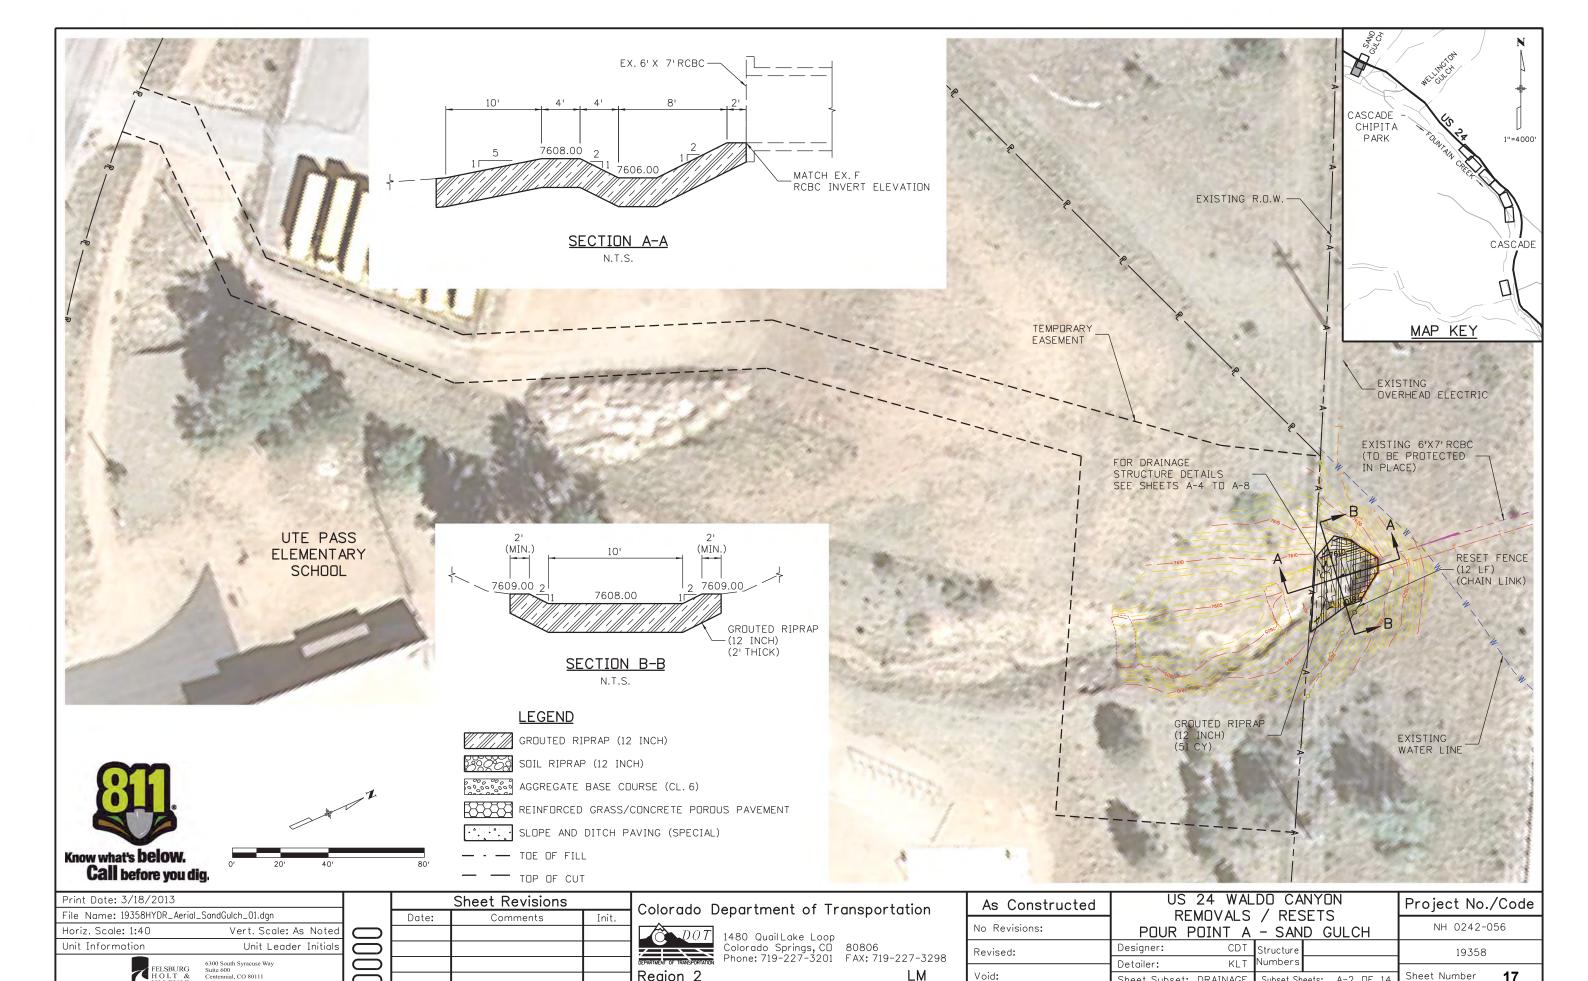

Colorado	Department of Tr	anspor	tatio	on
DOT	1480 QuailLake Loop Colorado Springs, CD	80806		
	Discrete 710, 007, 7001	E 4 V - 710	227	70

		LM
	Colorado Springs, CD Phone: 719-227-3201	
ı	1480 QuailLake Loop	

As Constructed	US 24 WAL	Project No./Code	
No Revisions:	POUR POINT A	NH 0242-056	
Revised:		Structure	19358
Void:	Detailer: KLT Sheet Subset: DRAINAGE		Sheet Number 19



POINT DATA TABLE - POUR POINT A - GRADING

POINT	NORTHING	EASTING	ELEVATION	DESCRIPTION
G1	397714.99	145904.51	7637.00	FINISHED GRADE
G2	397709.91	145913.38	7635.00	FINISHED GRADE
G3	397719.19	145921.74	7634.00	FINISHED GRADE
G4	397713.59	145941.38	7631.00	FINISHED GRADE
G5	397735.21	145912.69	7636.00	FINISHED GRADE
G6	397757.01	145972.42	7629.00	FINISHED GRADE
G7	397754.83	145954.55	7638.00	FINISHED GRADE
G8	397758.80	145953.99	7638.00	FINISHED GRADE
G9	397795.96	145980.61	7640.00	FINISHED GRADE
G10	397790.85	146000.18	7639.00	FINISHED GRADE
G11	397781.44	146006.98	7640.00	FINISHED GRADE
G12	397763.11	145977.50	7629.00	FINISHED GRADE
G13	397761.06	145996.59	7629.00	FINISHED GRADE
G14	397743.52	145974.34	7629.00	FINISHED GRADE
G15	397741.01	145967.72	7629.00	FINISHED GRADE
G16	397731.24	145967.68	7629.00	FINISHED GRADE
G17	397730.88	145990.75	7629.00	FINISHED GRADE
G18	397755.89	145999.29	7629.00	FINISHED GRADE
G19	397767.84	146015.96	7641.00	FINISHED GRADE
G20	397755.81	146026.74	7642.00	FINISHED GRADE
G21	397734.14	146025.68	7645.00	FINISHED GRADE
G22	397720.54	146021.03	7645.00	FINISHED GRADE
G23	397705.09	146011.88	7644.00	FINISHED GRADE
G24	397690.23	145996,34	7641.00	FINISHED GRADE
G25	397681,29	145984.23	7638.00	FINISHED GRADE
G26	397676.81	145967.36	7636.00	FINISHED GRADE
G27	397687.04	145969.53	7632.00	FINISHED GRADE
G28	397723.21	145922.64	7634.00	FINISHED GRADE
G29	397735.33	145922.69	7634.00	FINISHED GRADE
G30	397739.51	145947.71	7631.00	FINISHED GRADE
G31	397729.51	145947.67	7631.00	FINISHED GRADE
G32	397727.41	145956,80	7631.00	FINISHED GRADE
G33	397725.40	145957.00	7632.00	FINISHED GRADE
G34	397723.69	145946.23	7634.00	FINISHED GRADE
G35	397719.68	145945.81	7634.00	FINISHED GRADE
G36	397722.14	145952.95	7634.00	FINISHED GRADE
G37	397718.05	145952.89	7634.00	FINISHED GRADE
G38	397713.40	145956.82	7632.00	FINISHED GRADE
G39	397709.44	145954.62	7630.00	FINISHED GRADE
G40	397693.36	145959.28	7626.00	FINISHED GRADE
G41	397697.23	145968.03	7627.00	FINISHED GRADE
G42	397690.44	145973.35	7631.00	FINISHED GRADE
G43	397710.96	145985.23	7631.00	FINISHED GRADE
G44	397712.95	145986.09	7632.00	FINISHED GRADE
G45	397716.89	145990.15	7634.00	FINISHED GRADE
G46	397720.77	145997.87	7634.00	FINISHED GRADE
G47	397720.89	145990.21	7634.00	FINISHED GRADE
G48	397724.95	145986.27	7632.00	FINISHED GRADE
G49	397726.96	145985.22	7631.00	FINISHED GRADE

POINT	NORTHING	EASTING	ELEVATION	DESCRIPTION	
G75	397472.54	145831.20	7614.00	FINISHED GRADE	
G76	397476.72	145835.51	7614.00	FINISHED GRADE	
G77	397465.55	145832.28	7611.00	FINISHED GRADE	
G78	397462.85	145835.63	7609.00	FINISHED GRADE	
G79	397461.96	145838.47	7609.00	FINISHED GRADE	
G80	397466.66	145836.84	7609.00	FINISHED GRADE	
G81	397465.77	145839.67	7609.00	FINISHED GRADE	
G82	397461.36	145840.38	7608.00	FINISHED GRADE	
G83	397458.09	145837.43	7607.00	FINISHED GRADE	
G84	397458.06	145840.87	7607.00	FINISHED GRADE	
G85	397457.08	145840.64	7607.00	FINISHED GRADE	
G86	397455.54	145838.13	7606.00	FINISHED GRADE	
G87	397443.23	145854.23	7606.00	FINISHED GRADE	
G88	397455.15	145846.82	7607.00	FINISHED GRADE	
G89	397456.11	145847.12	7607.00	FINISHED GRADE	
G90	397453.36	145852.54	7607.00	FINISHED GRADE	
G91	397456.96	145854.43	7609.00	FINISHED GRADE	
G92	397458.75	145855.42	7610.00	FINISHED GRADE	
G93	397458.37	145849.92	7608.00	FINISHED GRADE	
G94	397464.10	145851.72	7608.00	FINISHED GRADE	
G95	397466.80	145856.75	7610.00	FINISHED GRADE	
G96	397469.11	145849.09	7606.00	FINISHED GRADE	
G97	397470.89	145843.41	7606.00	FINISHED GRADE	
G98	397477.59	145851.75	7606.00	FINISHED GRADE	
G99	397481.23	145846.64	7606.00	FINISHED GRADE	
G100	397479.12	145841.79	7608.00	FINISHED GRADE	

POINT DATA TABLE - POUR POINT A - SOIL RIPRAP (12 INCH)

POINT	NORTHING	EASTING	ELEVATION	DESCRIPTION
SR1	397794.60	145971.42		LIMITS OF SOIL RIPRAP (12 INCH) - MATCH EX. GRADE EL.
SR2	397808.85	145972.94		LIMITS OF SOIL RIPRAP (12 INCH) - MATCH EX. GRADE EL.
SR3	397804.81	146010.72	-	LIMITS OF SOIL RIPRAP (12 INCH) - MATCH EX. GRADE EL.
SR4	397790.56	146009.20		LIMITS OF SOIL RIPRAP (12 INCH) - MATCH EX. GRADE EL.
SR5	397720.76	145916.12	7634.92	LIMITS OF SOIL RIPRAP (12 INCH) - FINISHED GRADE EL.
SR6	397716.00	145914.58	7634.92	LIMITS OF SOIL RIPRAP (12 INCH) - FINISHED GRADE EL.
SR7	397706.88	145942.86	7631.08	LIMITS OF SOIL RIPRAP (12 INCH) - MATCH EX. GRADE EL.
SR8	397684.85	145952.07	7635.50	LIMITS OF SOIL RIPRAP (12 INCH) - MATCH EX. GRADE EL.
SR9	397680.48	145958.10	7636.08	LIMITS OF SOIL RIPRAP (12 INCH) - MATCH EX. GRADE EL.
SR10	397660.40	145968.53	7638.04	LIMITS OF SOIL RIPRAP (12 INCH) - MATCH EX. GRADE EL.
SR11	397665.01	145977.40	7637.92	LIMITS OF SOIL RIPRAP (12 INCH) - MATCH EX. GRADE EL.
SR12	397682.93	145968.09	7633.50	LIMITS OF SOIL RIPRAP (12 INCH) - FINISHED GRADE EL.
SR13	397688.42	145981.42	7635.00	LIMITS OF SOIL RIPRAP (12 INCH) - FINISHED GRADE EL.
SR14	397706.86	145992.10	7635.00	LIMITS OF SOIL RIPRAP (12 INCH) - FINISHED GRADE EL.
SR15	397706.78	145996.99	7637.04	LIMITS OF SOIL RIPRAP (12 INCH) - FINISHED GRADE EL.
SR16	397718.44	145997.17	7634.75	LIMITS OF SOIL RIPRAP (12 INCH) - FINISHED GRADE EL.

POINT DATA TABLE - POUR POINT A - SLOPE AND DITCH PAVING

POINT	NORTHING	EASTING	ELEVATION	DESCRIPTION
SD1	397803.35	145977.38		SLOPE AND DITCH PAVING MATCH EX. GRADE ELEVATION
SD2	397800.37	146005.22		SLOPE AND DITCH PAVING MATCH EX. GRADE ELEVATION
SD3	397797.95	145980.82	7640.50	SLOPE AND DITCH PAVING FINISHED GRADE ELEVATION
SD4	397795.82	146000.71	7640.50	SLOPE AND DITCH PAVING FINISHED GRADE ELEVATION

POINT DATA TABLE - POUR POINT A - AGGREGATE BASE COURSE (CL. 6)

POINT	POINT NORTHING EASTING		ELEVATION	DESCRIPTION		
BC1	397725.60	145902.65	7638,33	ABC (CL. 6) FINISHED GRADE EL.		
BC2	397735.08	145902.69	7639.04	ABC (CL. 6) FINISHED GRADE EL.		
BC3	397725.31	145927.65	7633.00	ABC (CL. 6) FINISHED GRADE EL.		
BC4	397735.46	145927.23	7633.25	ABC (CL. 6) FINISHED GRADE EL.		
BC5	397726.41	145932.66	7632.50	ABC (CL. 6) FINISHED GRADE EL.		
BC6	397736,66	145932.70	7632,50	ABC (CL. 6) FINISHED GRADE EL.		

POINT DATA TABLE - POUR POINT A - LOG DEFLECTOR

POINT	NORTHING	EASTING	ELEVATION	DESCRIPTION
LD1	397813.70	145953.01		LIMITS OF LOG DEFLECTOR (SEE DETAILS FOR VERTICAL INFORMATION)
LD2	397818.88	145994.29		LIMITS OF LOG DEFLECTOR (SEE DETAILS FOR VERTICAL INFORMATION)
LD3	397806.14	146033.90		LIMITS OF LOG DEFLECTOR (SEE DETAILS FOR VERTICAL INFORMATION)

POINT DATA TABLE - POUR POINT A - CUTOFF WALL

POINT	NORTHING	EASTING	ELEVATION	DESCRIPTION
W1	397794.27	145971.38		CONCRETE CUTOFF WALL - FINISHED GRADE EL.
W2	397790.23	146009.16		CONCRETE CUTOFF WALL - FINISHED GRADE EL.
W3	397764.44	145968.19	7633.50	CONCRETE CUTOFF WALL - FINISHED GRADE EL.
W4	397760.40	146005.97	7633.50	CONCRETE CUTOFF WALL - FINISHED GRADE EL.
W5	397721.24	145924.11	7634.00	CONCRETE CUTOFF WALL - FINISHED GRADE EL.
W6	397721.63	145946.26	7634.00	CONCRETE CUTOFF WALL - FINISHED GRADE EL.
W7	397720.24	145952.92	7634.00	CONCRETE CUTOFF WALL - FINISHED GRADE EL.
W8	397719.40	145956.91	7632.00	CONCRETE CUTOFF WALL - FINISHED GRADE EL.
W9	397718.95	145986.18	7632.00	CONCRETE CUTOFF WALL - FINISHED GRADE EL.
W10	397718.89	145990.18	7634.00	CONCRETE CUTOFF WALL - FINISHED GRADE EL.
W11	397718.63	146006.89	7638.50	CONCRETE CUTOFF WALL - FINISHED GRADE EL.

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Horiz. Scale: 1:10	Vert. Scale: As Noted	
Unit Information	Unit Leader Initials	$ \equiv$
FELSBURG HOLT &	6300 South Syracuse Way Suite 600 Centennial, CO 80111	

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Date:	Comments	Init.

Colorado D	epartment of Tr	ansportation
DOT	1480 QuailLake Loop Colorado Springs, CD Phone: 719-227-3201	80806 FAX: 719-227-32

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As Constructed	US 24 WALDO CANYON DETATI			Project No./Code		
No Revisions:	POUR POINT A - SAND GULCH			NH 0242-056		
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Void:	Detailer: Sheet Subset:	1,721		A-6 of 14	Sheet Number	21

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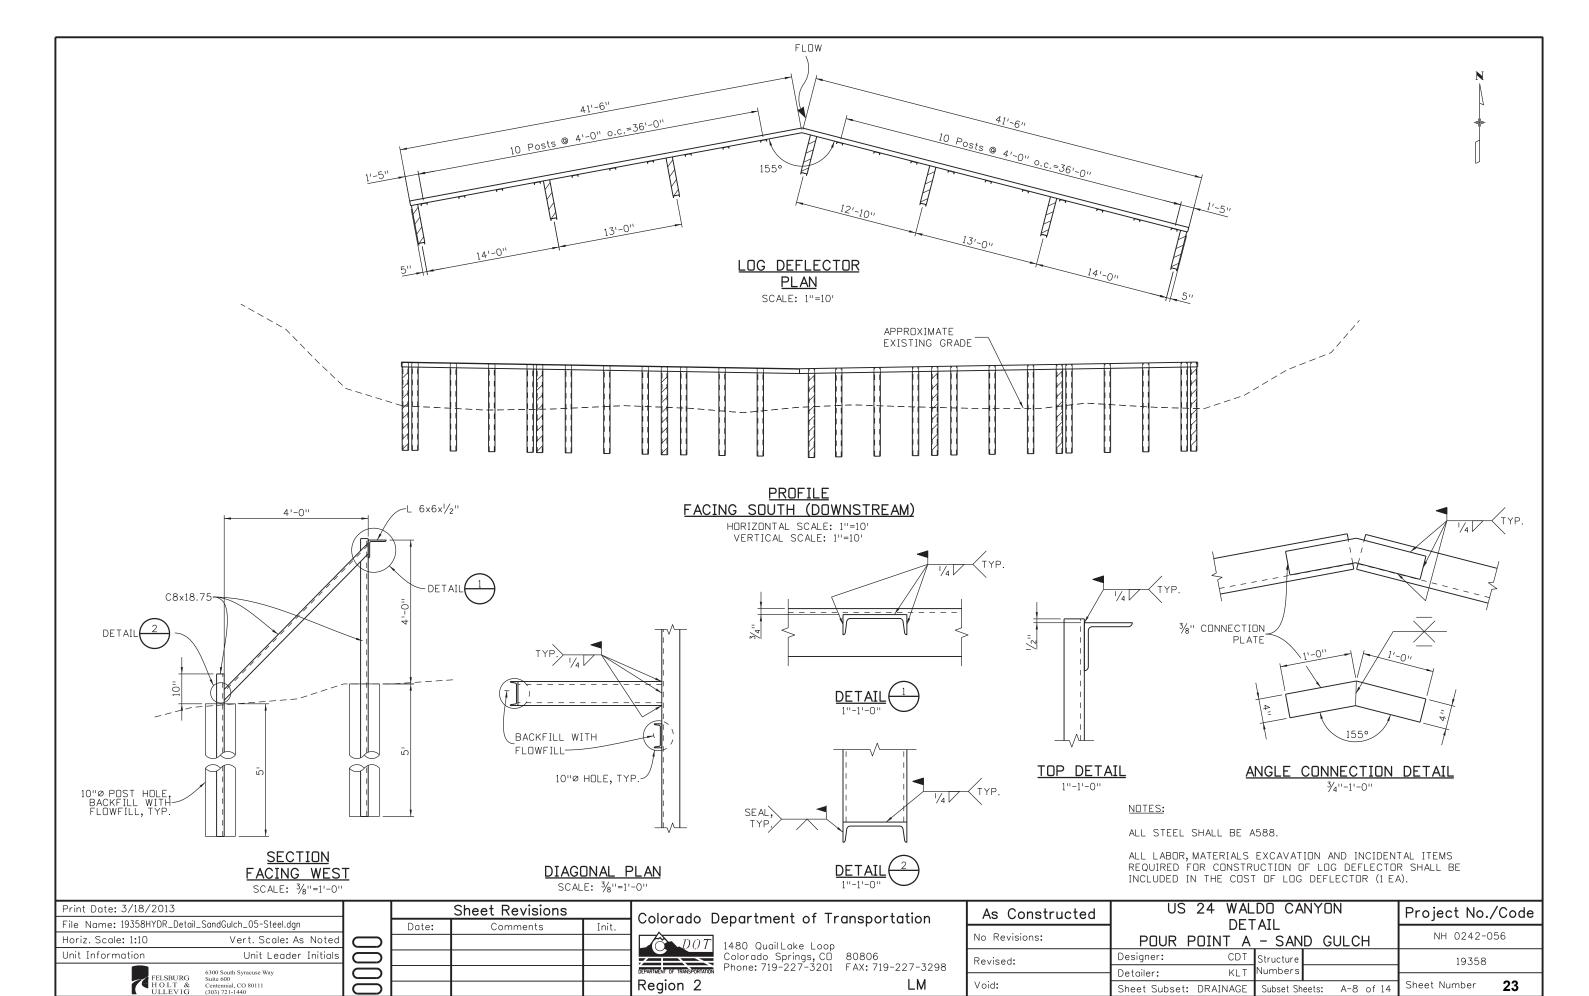
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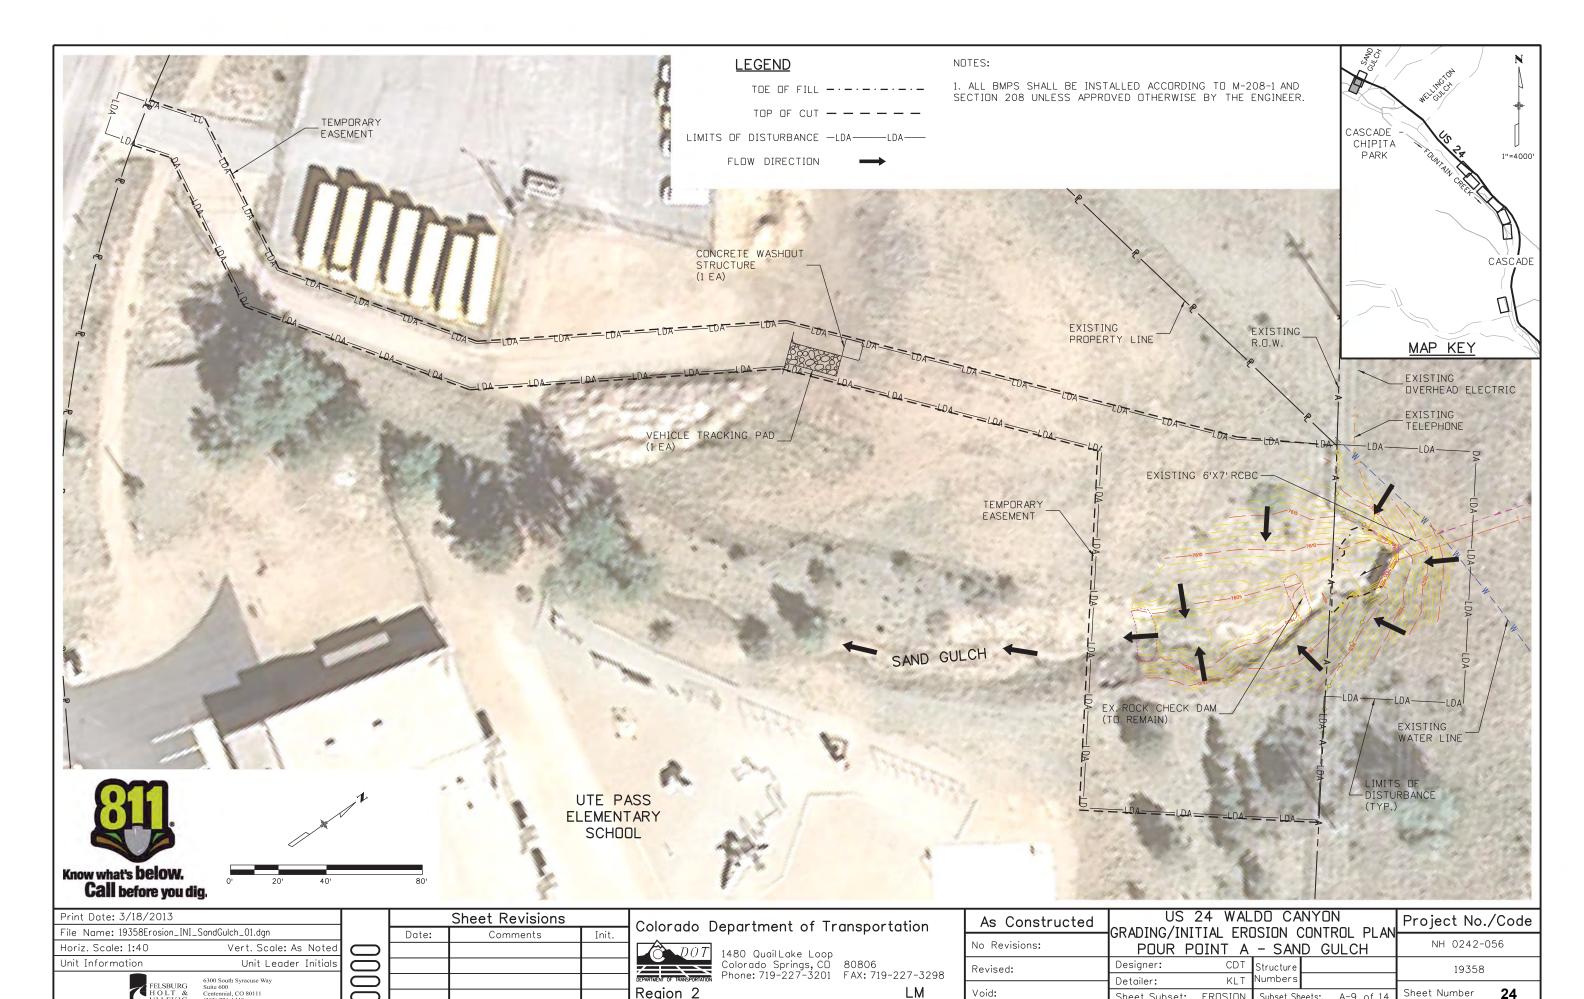
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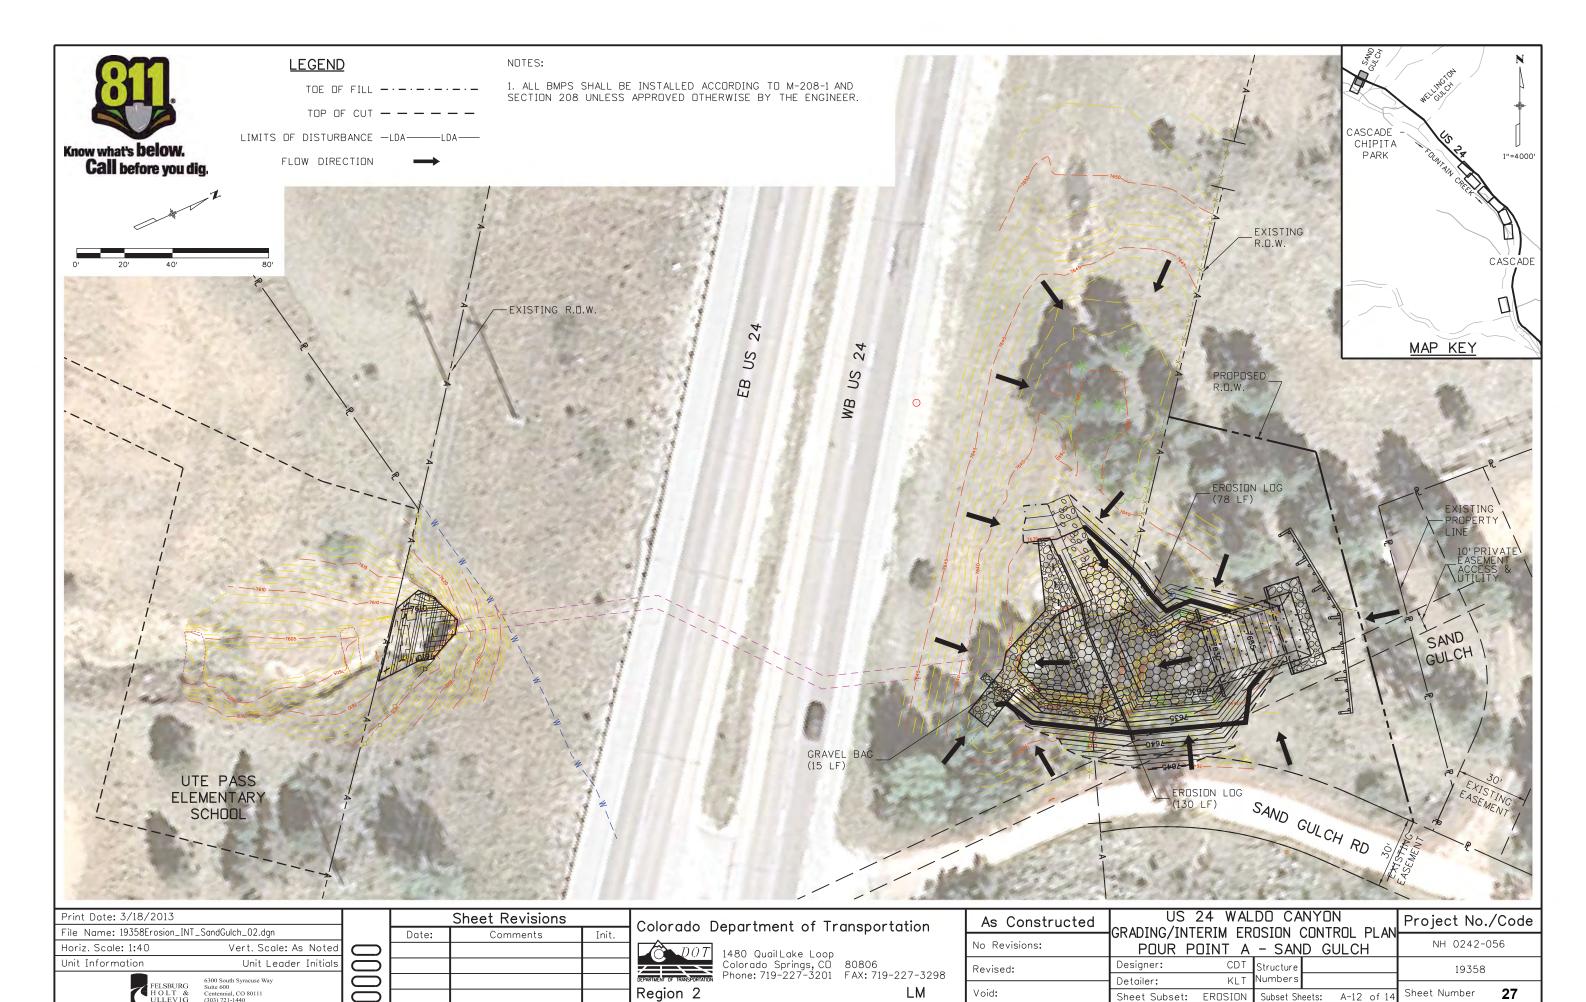
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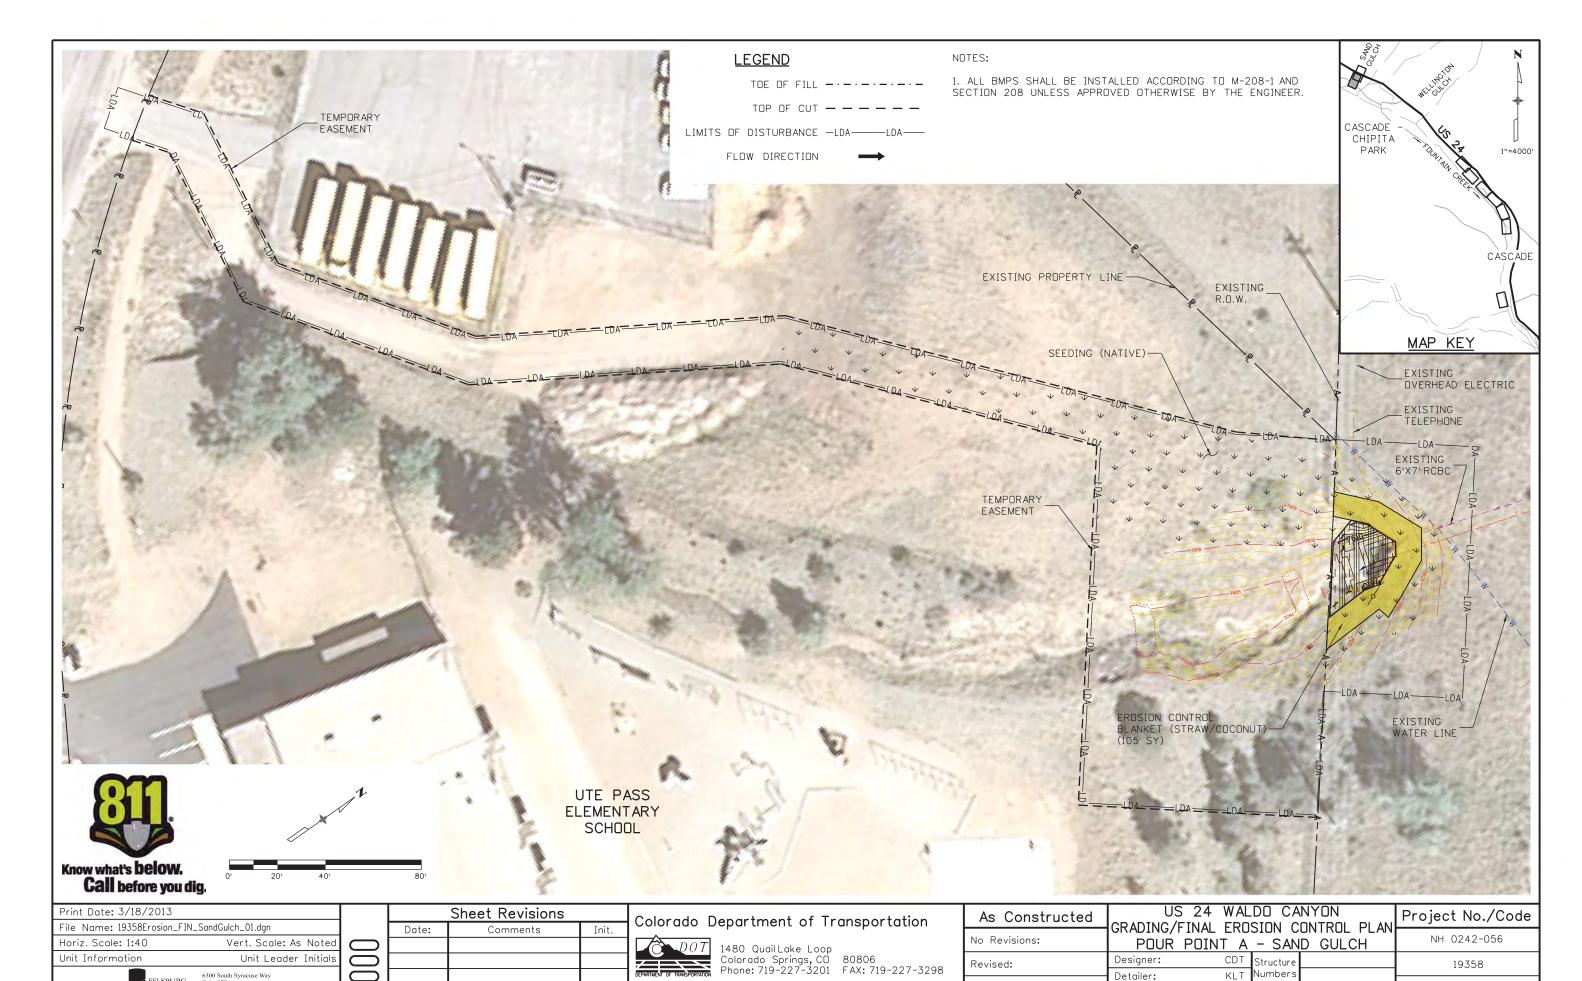
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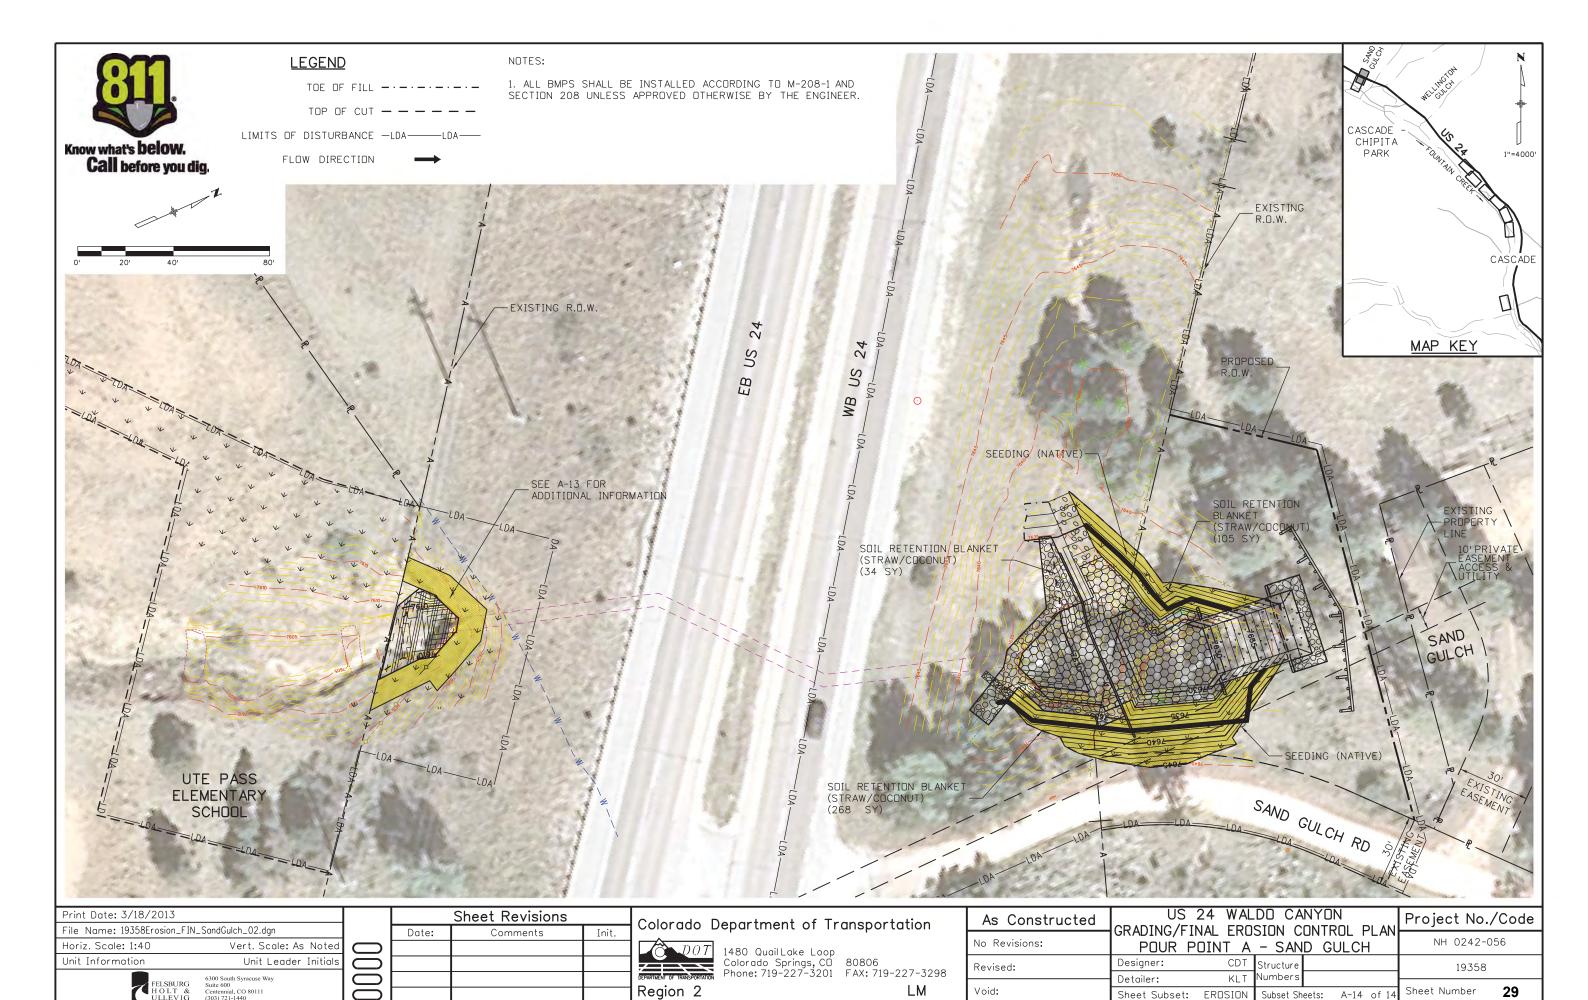


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POUR POINT B TABULATION

CONTRACT ITEM NO.	CONTRACTITEM	UNIT	QUANTITY
201-00001	CLEARING AND GRUBBING	LS	1
202-00010	REMOVAL OF TREE	EA	45
202-00035	REMOVAL OF PIPE	LF	3
202-01000	REMOVAL OF FENCE	LF	207
202-04002	CLEAN CULVERT	EA	1
203-00010	UNCLASSIFIED EXCAVATION (COMPLETE IN PLACE)	CY	2973
203-01622	SWEEPING (WITH PICKUP BROOM)	HR	40
207-00205	TOPSOIL	CY	217
208-00002	EROSION LOG (12 INCH)	LF	293
208-00034	GRAVEL BAG	LF	60
208-00045	CONCRETE WASHOUT STRUCTURE	EA	1
208-00070	VEHICLE TRACKING PAD	EA	1
208-00103	REMOVAL AND DISPOSAL OF SEDIMENT (LABOR)	HR	80
208-00105	REMOVAL AND DISPOSAL OF SEDIMENT (EQUIPMENT)	HR	40
208-00205	EROSION CONTROL SUPERVISOR	DAY	30
212-00006	SEEDING (NATIVE)	AC	0.7
212-00032	SOIL CONDITIONING	AC	0.7
213-00002	MULCHING (WEED FREE)	AC	0.7
214-00215	DECIDUOUS TREE (1.5 INCH CALIPER)	EA	45
216-00041	SOIL RETENTION BLANKET (STRAW/COCONUT)	SY	1165
304-06000	AGGREGATE BASE COURSE (CLASS 6)	CY	63
420-00102	GEOTEXTILE (EROSION CONTROL) (CLASS 1)	SY	314
506-00236	RIPRAP (36 INCH)	CY	90
506-00412	SOIL RIPRAP (12 INCH)	CY	118
601-01000	CONCRETE CLASS B	CY	22
607-53173	FENCE CHAIN LINK (SPECIAL) (72 INCH)	LF	260
607-60212	12 FOOT GATE SINGLE (CHAIN LINK)	EA	2
608-00100	REINFORCED GRASS/CONCRETE POROUS PAVEMENT	SY	1598
615-00620	LOG DEFLECTOR	EA	1

NOTE: TREES SHALL BE PLACED AS DIRECTED BY THE ENGINEER.

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воок	PAGE	SHEET	ITEM	PROJECT TOTALS
			EMBANKMENT MATERIAL (CIP) (FOR INFO. ONLY)	CU. YDS,
			WELLINGTON GULCH	34
			SUBTOTAL	34
			TOTAL	34
			UNCLASSIFIED EXCAVATION	CU. YDS.
			WELLINGTON GULCH	2,973
			OTHER EXCAVATION	0
			SUBTOTAL	2,973
			TOTAL FOR PAY QUANTITY	2,973

	COMPACTION (FOR INFORMATION ONLY) (MOISTURE & DENSITY CONTROL) EMBANKMENT (NET)	34
	TOTAL	34
	WETTING QUANTITIES (FOR INFORMATION ONLY) COMPACTION	M. GAL.
4	(34 x 0.040 M. GAL./yd) TOTAL	1
	ACCESS ROAD QUANTITIES BALANCE (FOR INFORMATION ONLY)	CU. YDS.
	EMBANKMENT (NET)	34
	EMBANKMENT X FACTOR (1.15)	39
	BALANCE TOTAL	39
	UNCLASSIFIED EXCAVATION TO BE EXPORTED BY THE CONTRACTOR BALANCE TOTAL	2,973 -2,934 39

Print Date: 3/18/2013					
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Unit Information	Unit Leader Initials	(
FELSBURG	6300 South Syracuse Way Suite 600	(
HOLT & ULLEVIG	Centennial, CO 80111 (303) 721-1440				

	Sheet Revisions	
Date:	Comments	Init.


Colorado Department of Transportation


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Colorado Springs, CD 80806
Phone: 719-227-3201 FAX: 719-227-3298


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As Constructed	US 24 WALDO CANYON TABULATION			Project No./Cod			
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Revised:	Designer:	_	Structure Numbers			19358	
Void:	Detailer: Sheet Subset:	TAB	Subset She	ets:	B-1 of 10	Sheet Number	30





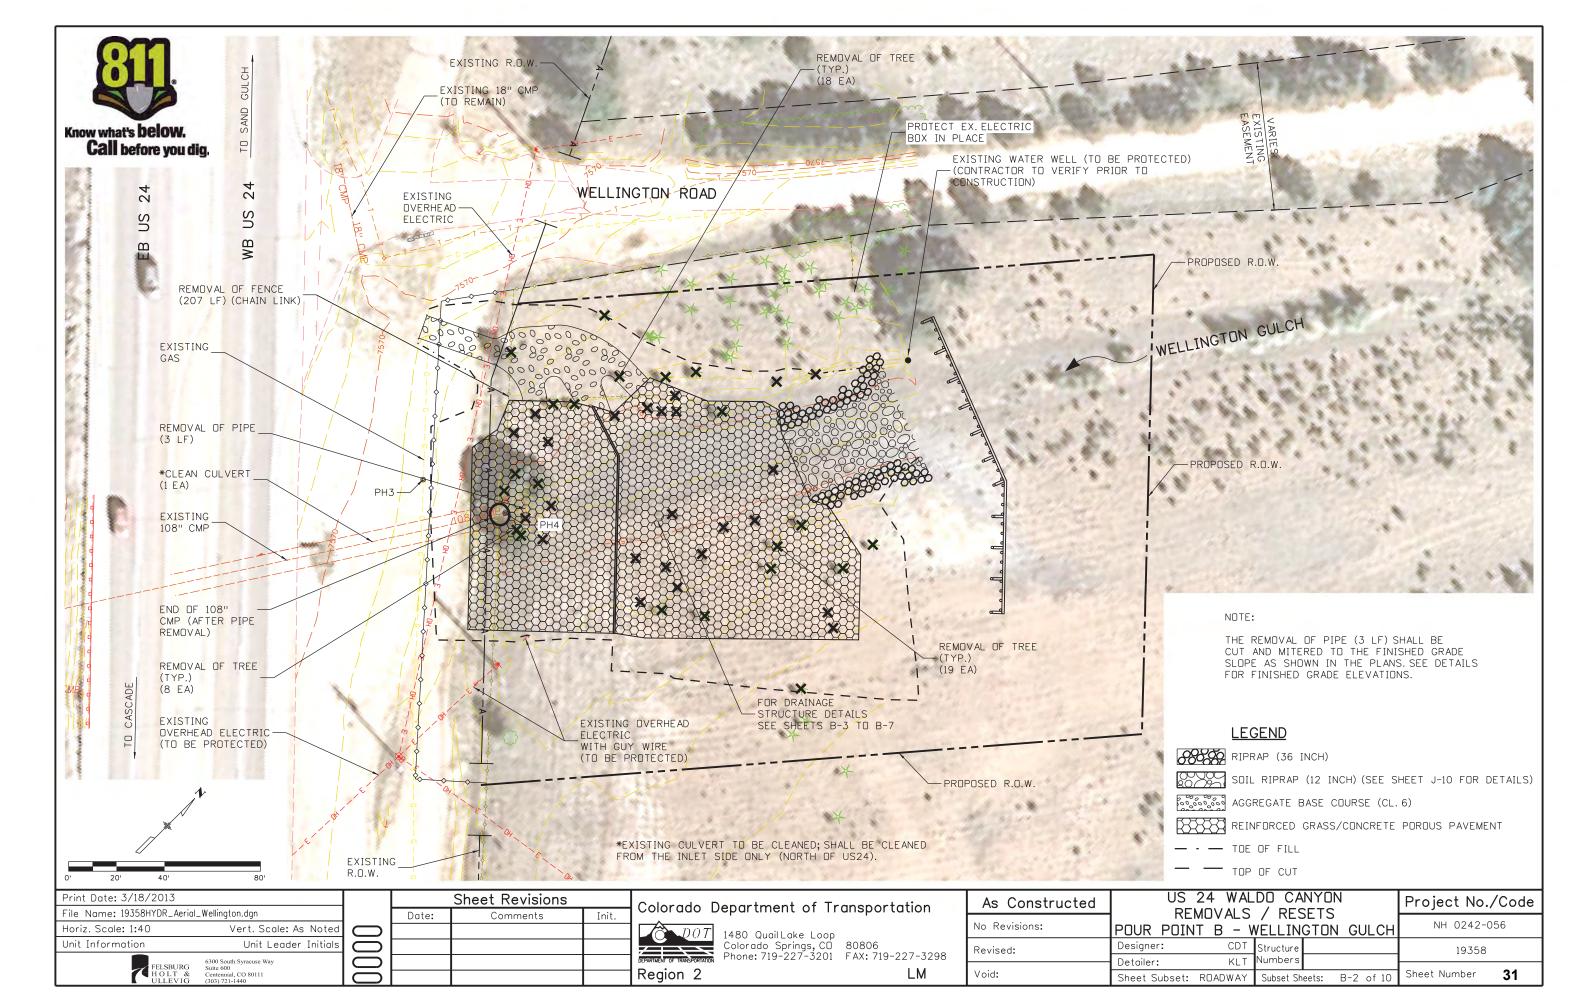
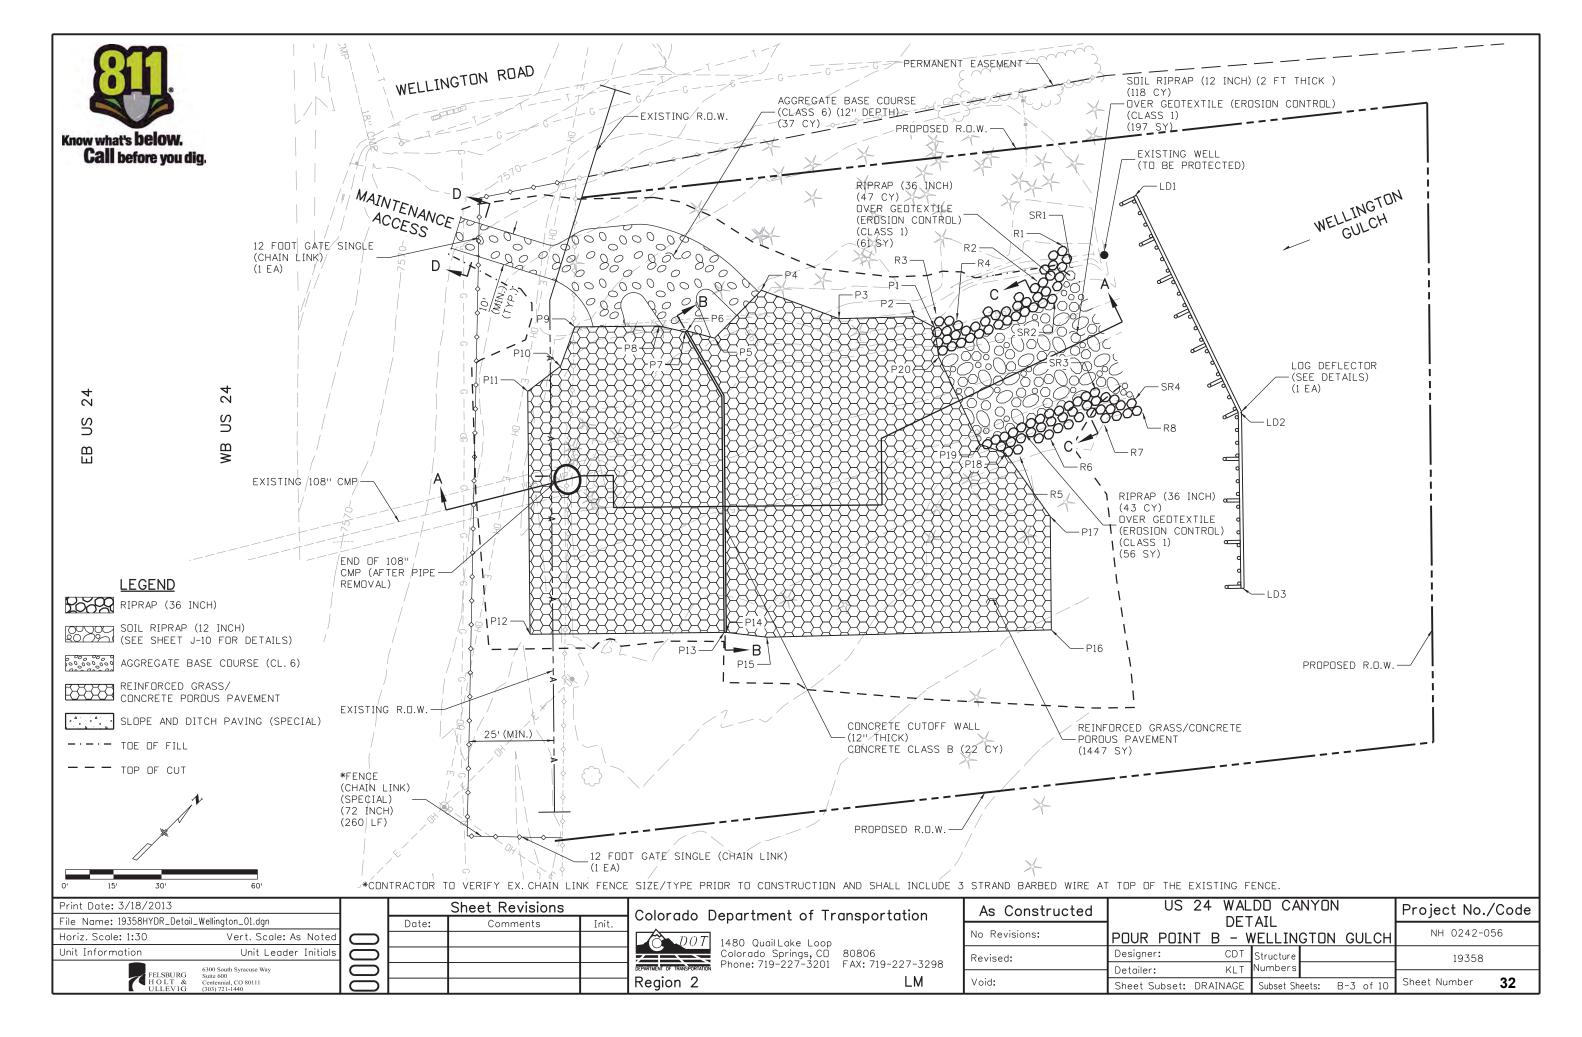
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Sheet Number

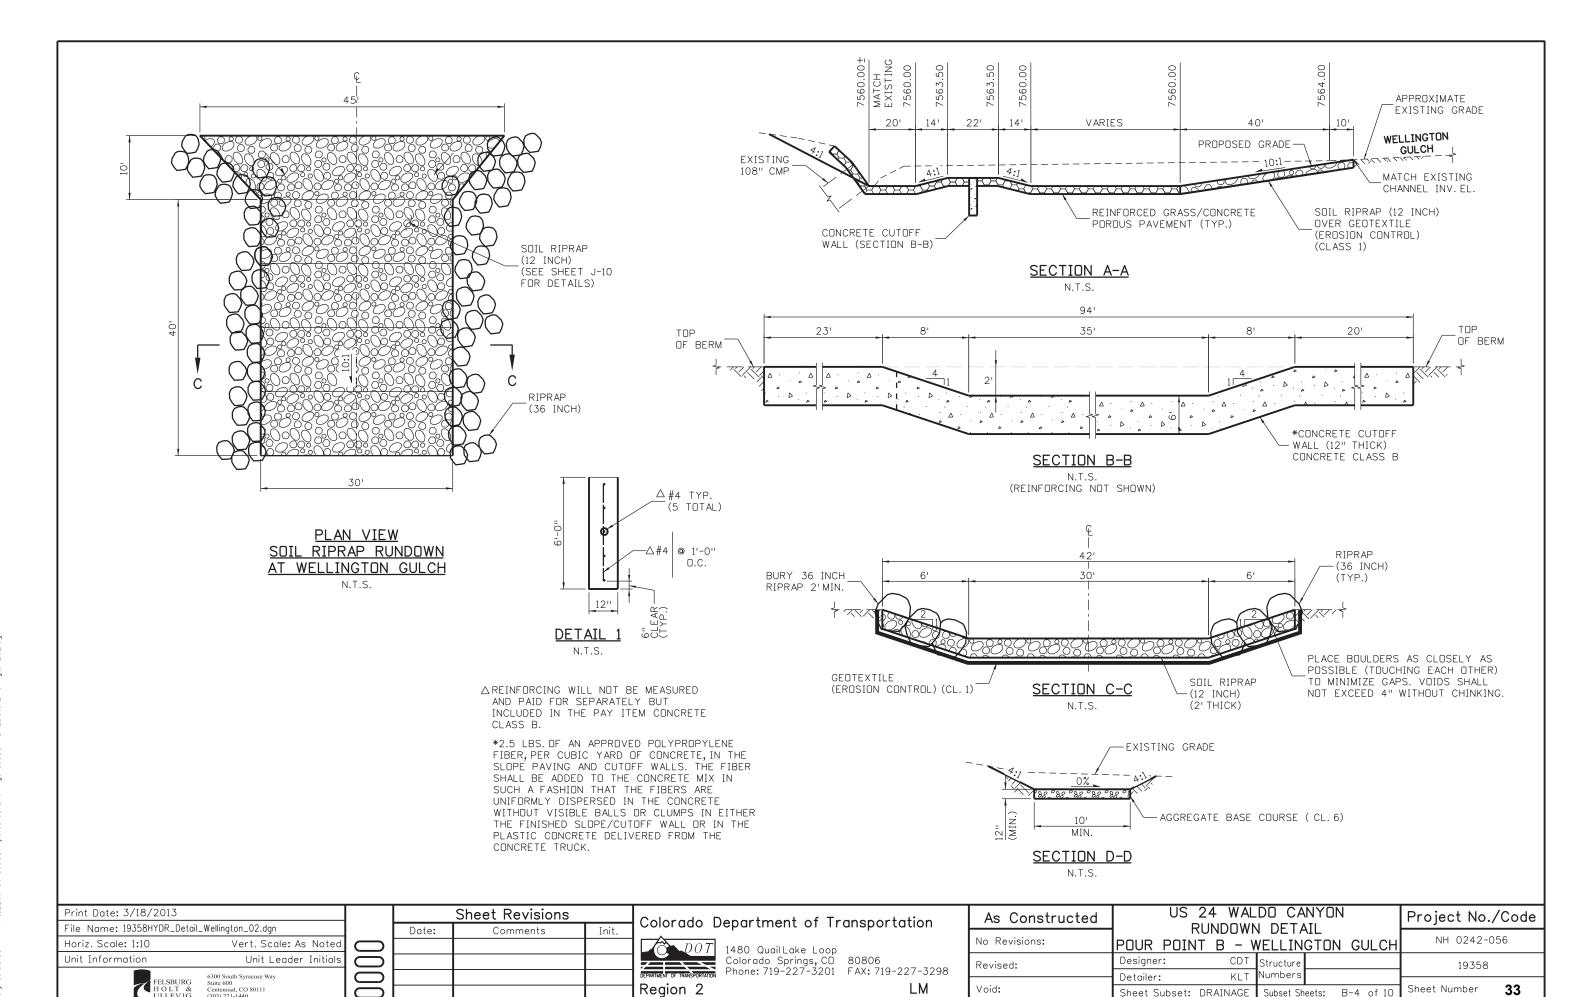Subset Sheets: B-4 of 10

33

POINT DATA TABLE - POUR POINT B - GRADING

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POINT	NORTHING	EASTING	ELEVATION	DESCRIPTION
G1	396162.89	148013.92	7569.00	FINISHED GRADE
G2	396174.65	148008.24	7569.00	FINISHED GRADE
G3	396195.33	148023,80	7569.00	FINISHED GRADE
G4	396216.23	148047.68	7568.00	FINISHED GRADE
G5	396142.14	148044.32	7558.00	FINISHED GRADE
G6	396158.61	148051.16	7567.00	FINISHED GRADE
G7	396169.04	148046.71	7567.00	FINISHED GRADE
G8	396178.48	148048.10	7565.00	FINISHED GRADE
G9	396190.34	148046,23	7565.00	FINISHED GRADE
G10	396175.40	148061.90	7563.00	FINISHED GRADE
G11	396183.73	148070.66	7563.00	FINISHED GRADE
G12	396226.13	148065,51	7565.00	FINISHED GRADE
G13	396208.56	148073.40	7565.00	FINISHED GRADE
G14	396219.73	148070.94	7565.00	FINISHED GRADE
G15	396236.17	148099.91	7565.00	FINISHED GRADE
G16	396237.15	148112.62	7565.00	FINISHED GRADE
G17	396207.38	148123.03	7560.00	FINISHED GRADE
G18	396219.61	148123.30	7530.00	FINISHED GRADE
G19	396237.10	148142.10	7560.00	FINISHED GRADE
G20	396242.77	148148.19	7560.00	FINISHED GRADE
G21	396263.09	148130.69	7567.00	FINISHED GRADE
G22	396264.85	148146.16	7567.00	FINISHED GRADE
G23	396281.75	148157.13	7567.00	FINISHED GRADE
G24	396289.08	148155.48	7567.00	FINISHED GRADE
G25	396289.09	148157.53	7556.00	FINISHED GRADE
G26	396281.01	148161.33	7565.00	FINISHED GRADE
G27	396279.94	148162.97	7564.00	FINISHED GRADE
G28	396268.86	148190.85	7564.00	FINISHED GRADE
G29	396272.25	148193.46	7565.00	FINISHED GRADE
G30	396264.44	148194.03	7566.00	FINISHED GRADE
G31	396248.79	148196.27	7567.00	FINISHED GRADE
G32	396231.69	148176.07	7560.00	FINISHED GRADE
G33	396227.61	148180.91	7550.00	FINISHED GRADE
G34	396219.58	148201.12	7560.00	FINISHED GRADE
G35	396244.82	148215.75	7567.00	FINISHED GRADE

POINT	NORTHING	EASTING	ELEVATION	DESCRIPTION
G36	396204.75	148215.21	7560.00	FINISHED GRADE
G37	396203.88	148265.71	7569.00	FINISHED GRADE
G38	396159.20	148168,83	7560.00	FINISHED GRADE
G39	396124.99	148168.24	7566.00	FINISHED GRADE
G40	396130.86	148154.38	7565.00	FINISHED GRADE
G41	396162.18	148146.68	7563.50	FINISHED GRADE
G42	396153.70	148146.47	7565.00	FINISHED GRADE
G43	396146.81	148139.22	7565.00	FINISHED GRADE
G44	396147.02	148130.74	7563.50	FINISHED GRADE
G45	396187.55	148122.57	7563.50	FINISHED GRADE
G46	396172.39	148106.62	7563.50	FINISHED GRADE
G47	396187.76	148114.09	7565.00	FINISHED GRADE
G48	396190.56	148111.42	7565.00	FINISHED GRADE
G49	396184.38	148103,50	7565.00	FINISHED GRADE
G50	396180.87	148106.84	7565.00	FINISHED GRADE
G51	396124.33	148132.99	7560.00	FINISHED GRADE
G52	396164.92	148094.41	7560.00	FINISHED GRADE
G53	396169,41	148084.62	7561.00	FINISHED GRADE
G54	396161.14	148075,92	7561.00	FINISHED GRADE
G55	396151.14	148079.91	7560.00	FINISHED GRADE
G56	396110.55	148118.50	7560.00	FINISHED GRADE
G57	396081.11	148107.85	7567.00	FINISHED GRADE

POINT DATA TABLE - POUR POINT B - LOG DEFLECTOR

POINT	NORTHING	EASTING	ELEVATION	DESCRIPTION
LD1	396321.53	148158.63	~	LIMITS OF LOG DEFLECTOR (SEE DETAILS FOR VERTICAL INFORMATION)
LD2	396294.47	148228.70		LIMITS OF LOG DEFLECTOR (SEE DETAILS FOR VERTICAL INFORMATION)
LD3	396254.75	148266.90		LIMITS OF LOG DEFLECTOR (SEE DETAILS FOR VERTICAL INFORMATION)

POINT DATA TABLE - POUR POINT B - RIPRAP (36 INCH)

POINT	NORTHING	EASTING	ELEVATION	DESCRIPTION
R1	396317.07	148164.00		LIMITS OF RIPRAP (36 INCH) - MATCH EX. GRADE EL.
R2	396299.17	148161,45	7568.00	LIMITS OF SOIL RIPRAP (36 INCH) - FINISHED GRADE EL.
R3	396252.08	148139,48	7564.04	LIMITS OF SOIL RIPRAP (36 INCH) - FINISHED GRADE EL.
R4	396258.02	148147.47	7565.50	LIMITS OF SOIL RIPRAP (36 INCH) - FINISHED GRADE EL.
R5	396237.53	148187.46	7563.83	LIMITS OF SOIL RIPRAP (36 INCH) - FINISHED GRADE EL.
R6	396271.87	148199.41		LIMITS OF RIPRAP (36 INCH) - MATCH EX. GRADE EL.
R7	396286.58	148211.09	- 8	LIMITS OF RIPRAP (36 INCH) - MATCH EX. GRADE EL.
R8	396296.98	148217,21	400	LIMITS OF RIPRAP (36 INCH) - MATCH EX. GRADE EL.

POINT DATA TABLE - POUR POINT B - SOIL RIPRAP (12 INCH)

POINT	NORTHING	EASTING	ELEVATION	DESCRIPTION
SR1	396320.62	148168.92		LIMITS OF SOIL RIPRAP (12 INCH) - MATCH EX. GRADE EL.
SR2	396307.82	148174.05	7566.83	LIMITS OF SOIL RIPRAP (12 INCH) - FINISHED GRADE EL.
SR3	396296.74	148201.93		LIMITS OF SOIL RIPRAP (12 INCH) - MATCH EX. GRADE EL.
SR4	396303.05	148213.12		LIMITS OF SOIL RIPRAP (12 INCH) - MATCH EX. GRADE EL.

POINT DATA TABLE - POUR POINT B - CUTOFF WALL

POINT	NORTHING	EASTING	ELEVATION	DESCRIPTION
W1	396194.84	148084.90	7565.00	CONCRETE CUTOFF WALL - FINISHED GRADE EL.
W2	396187.94	148107.02	7565.00	CONCRETE CUTOFF WALL - FINISHED GRADE EL.
W3	396184.32	148110.46	7565.00	CONCRETE CUTOFF WALL - FINISHED GRADE EL.
W4	396179.97	148114.60	7563.50	CONCRETE CUTOFF WALL - FINISHED GRADE EL.
W5	396154.60	148138.71	7563.50	CONCRETE CUTOFF WALL - FINISHED GRADE EL.
VV6	396150.25	148142.84	7565.00	CONCRETE CUTOFF WALL - FINISHED GRADE EL.
W7	396134.31	148158.00	7565.00	CONCRETE CUTOFF WALL - FINISHED GRADE EL.

POINT DATA TABLE - POUR POINT B - POROUS PAVERS

POINT	NORTHING	EASTING	ELEVATION	DESCRIPTION
P1	396248.74	148140.82	7563.00	REINFORCED GRASS/CONC. POROUS PAVEMENT FINISHED GRADE EL.
P2	396246,89	148133.96	7563.00	REINFORCED GRASS/CONC. POROUS PAVEMENT FINISHED GRADE EL.
P3	396230.37	148117.14	7563.00	REINFORCED GRASS/CONC. POROUS PAVEMENT FINISHED GRADE EL.
P4	396220.28	148093.31	7563.00	REINFORCED GRASS/CONC. POROUS PAVEMENT FINISHED GRADE EL.
P5	396199.36	148092.84	7565.00	REINFORCED GRASS/CONC. POROUS PAVEMENT FINISHED GRADE EL.
P6	396195.16	148084.99	7565.00	REINFORCED GRASS/CONC. POROUS PAVEMENT FINISHED GRADE EL.
P7	396194.52	148084.80	7565.00	REINFORCED GRASS/CONC. POROUS PAVEMENT FINISHED GRADE EL.
P8	396190.31	148077.58	7565.00	REINFORCED GRASS/CONC. POROUS PAVEMENT FINISHED GRADE EL.
P9	396172.12	148058.44	7564.00	REINFORCED GRASS/CONC. POROUS PAVEMENT FINISHED GRADE EL.
P10	396160.08	148063.57	7564.00	REINFORCED GRASS/CONC. POROUS PAVEMENT FINISHED GRADE EL.
P11	396147.36	148061.43	7564.00	REINFORCED GRASS/CONC. POROUS PAVEMENT FINISHED GRADE EL.
P12	396092.28	148113.79	7565.00	REINFORCED GRASS/CONC. POROUS PAVEMENT FINISHED GRADE EL.
P13	396134.08	148157.76	7565.00	REINFORCED GRASS/CONC. POROUS PAVEMENT FINISHED GRADE EL.
P14	396134.54	148158.24	7565.00	REINFORCED GRASS/CONC. POROUS PAVEMENT FINISHED GRADE EL.
P15	396142.09	148168.54	7563.00	REINFORCED GRASS/CONC. POROUS PAVEMENT FINISHED GRADE EL.
P16	396204.46	148232.04	7563.00	REINFORCED GRASS/CONC. POROUS PAVEMENT FINISHED GRADE EL.
P17	396230.14	148207.63	7563.00	REINFORCED GRASS/CONC. POROUS PAVEMENT FINISHED GRADE EL.
P18	396235.05	148183.86	7563.00	REINFORCED GRASS/CONC. POROUS PAVEMENT FINISHED GRADE EL.
P19	396231.69	148176.07	7560.00	REINFORCED GRASS/CONC. POROUS PAVEMENT FINISHED GRADE EL.
P20	396242.77	148148.19	7560.00	REINFORCED GRASS/CONC. POROUS PAVEMENT FINISHED GRADE EL.

POINT DATA TABLE - POUR POINT B - AGGREGATE BASE COURSE (CL. 6)

POINT	NORTHING	EASTING	ELEVATION	DESCRIPTION
BC1	396163.79	148013.48	7569.00	ABC (CL. 6) FINISHED GRADE EL.
BC2	396172.79	148009.13	7569.00	ABC (CL. 6) FINISHED GRADE EL.
BC3	396185.06	148034.56	7566.25	ABC (CL. 6) FINISHED GRADE EL.
BC4	396177.73	148042.37	7565.67	ABC (CL. 6) FINISHED GRADE EL.
BC5	396176.06	148062.59	7563.00	ABC (CL. 6) FINISHED GRADE EL.
BC6	396183.04	148069.93	7563.00	ABC (CL. 6) FINISHED GRADE EL.
BC7	396190.99	148063.58	7564.50	ABC (CL. 6) FINISHED GRADE EL.
BC8	396193.48	148068.21	7565.00	ABC (CL. 6) FINISHED GRADE EL.
BC9	396198.77	148091.75	7565.00	ABC (CL. 6) FINISHED GRADE EL.
BC10	396212.07	148054.95	7565.75	ABC (CL. 6) FINISHED GRADE EL.
BC11	396217.77	148068.86	7565.25	ABC (CL. 6) FINISHED GRADE EL.
BC12	396207.16	148079.49	7564.75	ABC (CL. 6) FINISHED GRADE EL.
BC13	396209.28	148093.06	7563.00	ABC (CL. 6) FINISHED GRADE EL.
BC14	396219.28	148093.29	7563.00	ABC (CL. 6) FINISHED GRADE EL.

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Vert. Scale: As Noted
Unit Leader Initials
South Syracuse Way 600 ennial. CO 80111


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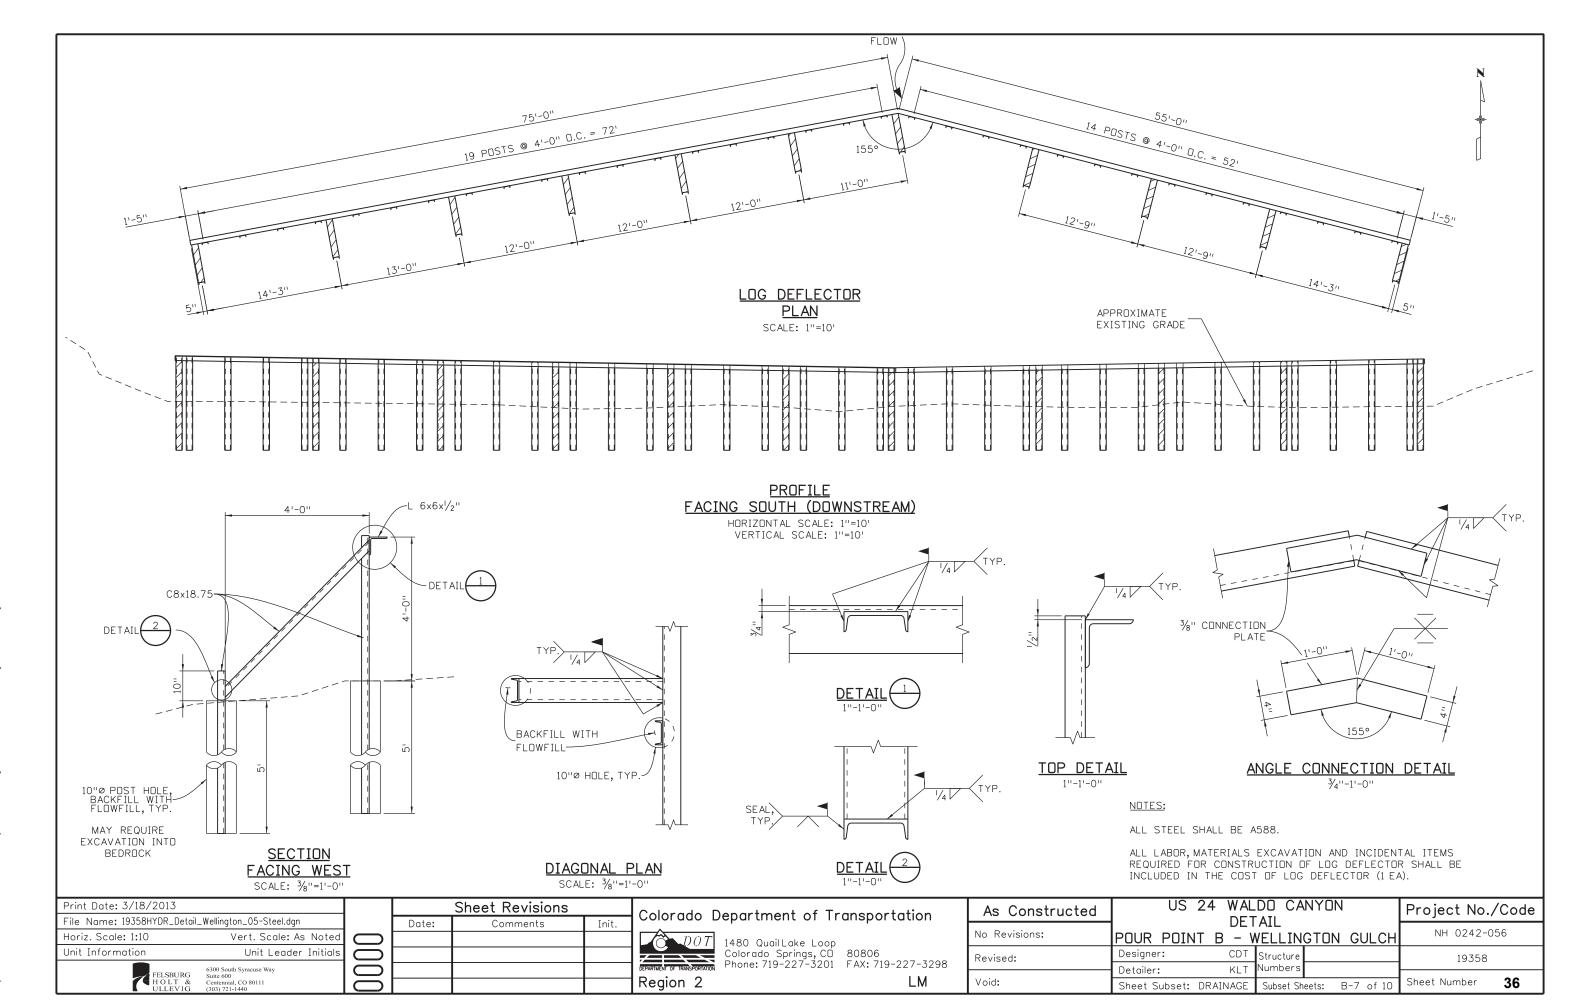
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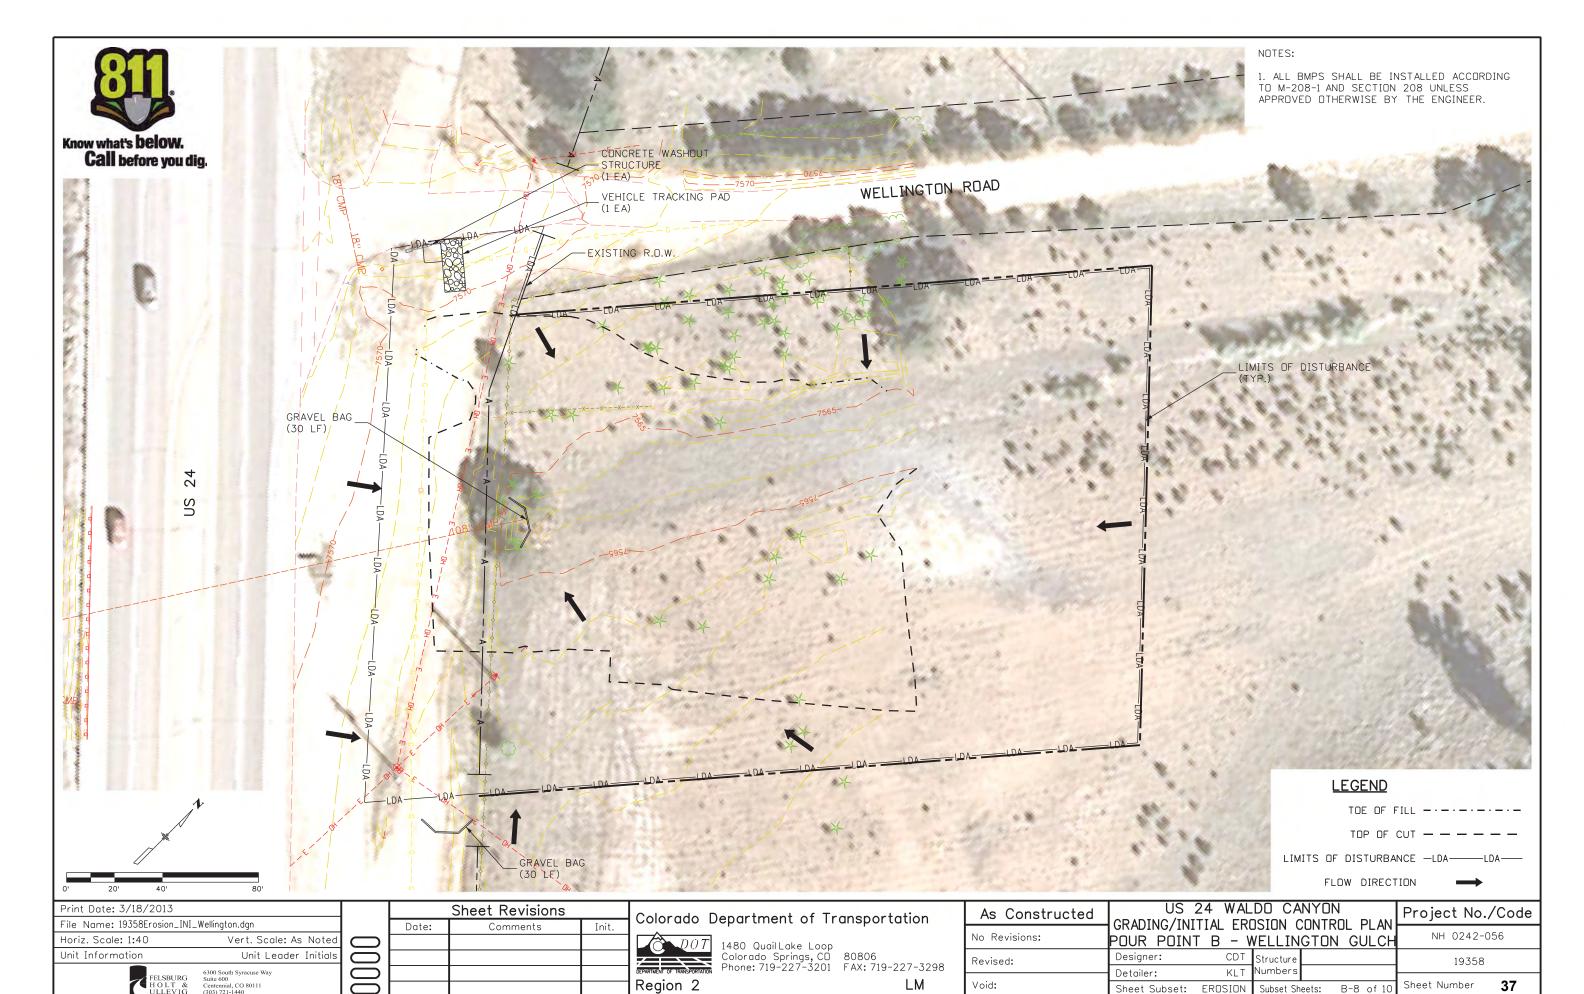
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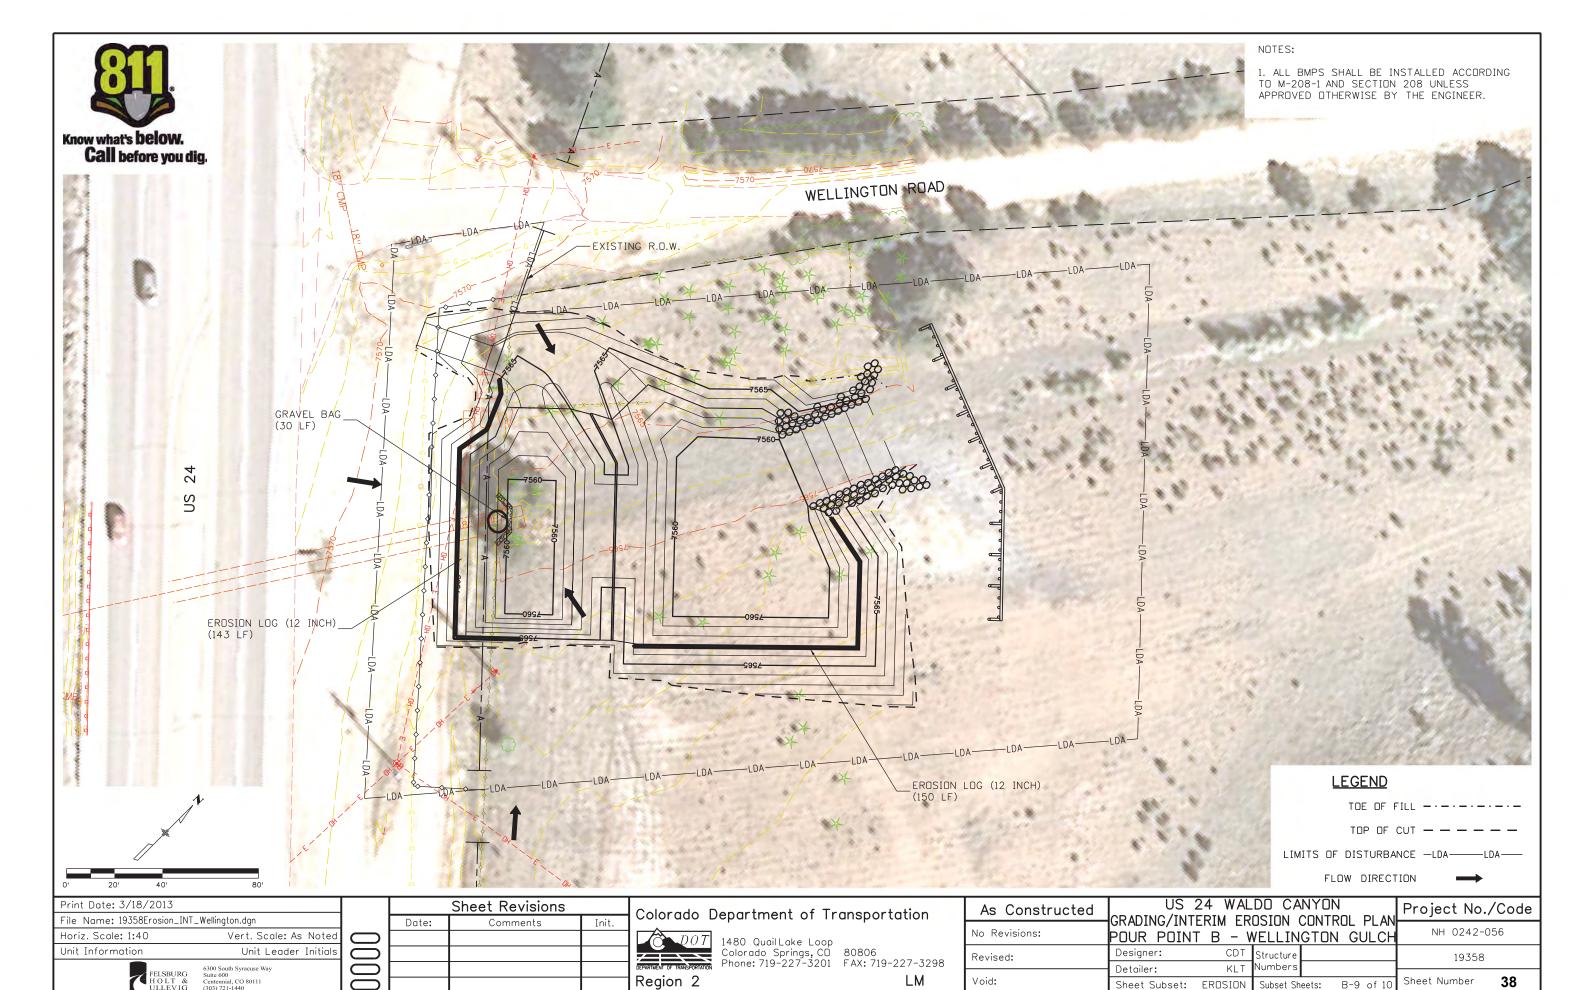
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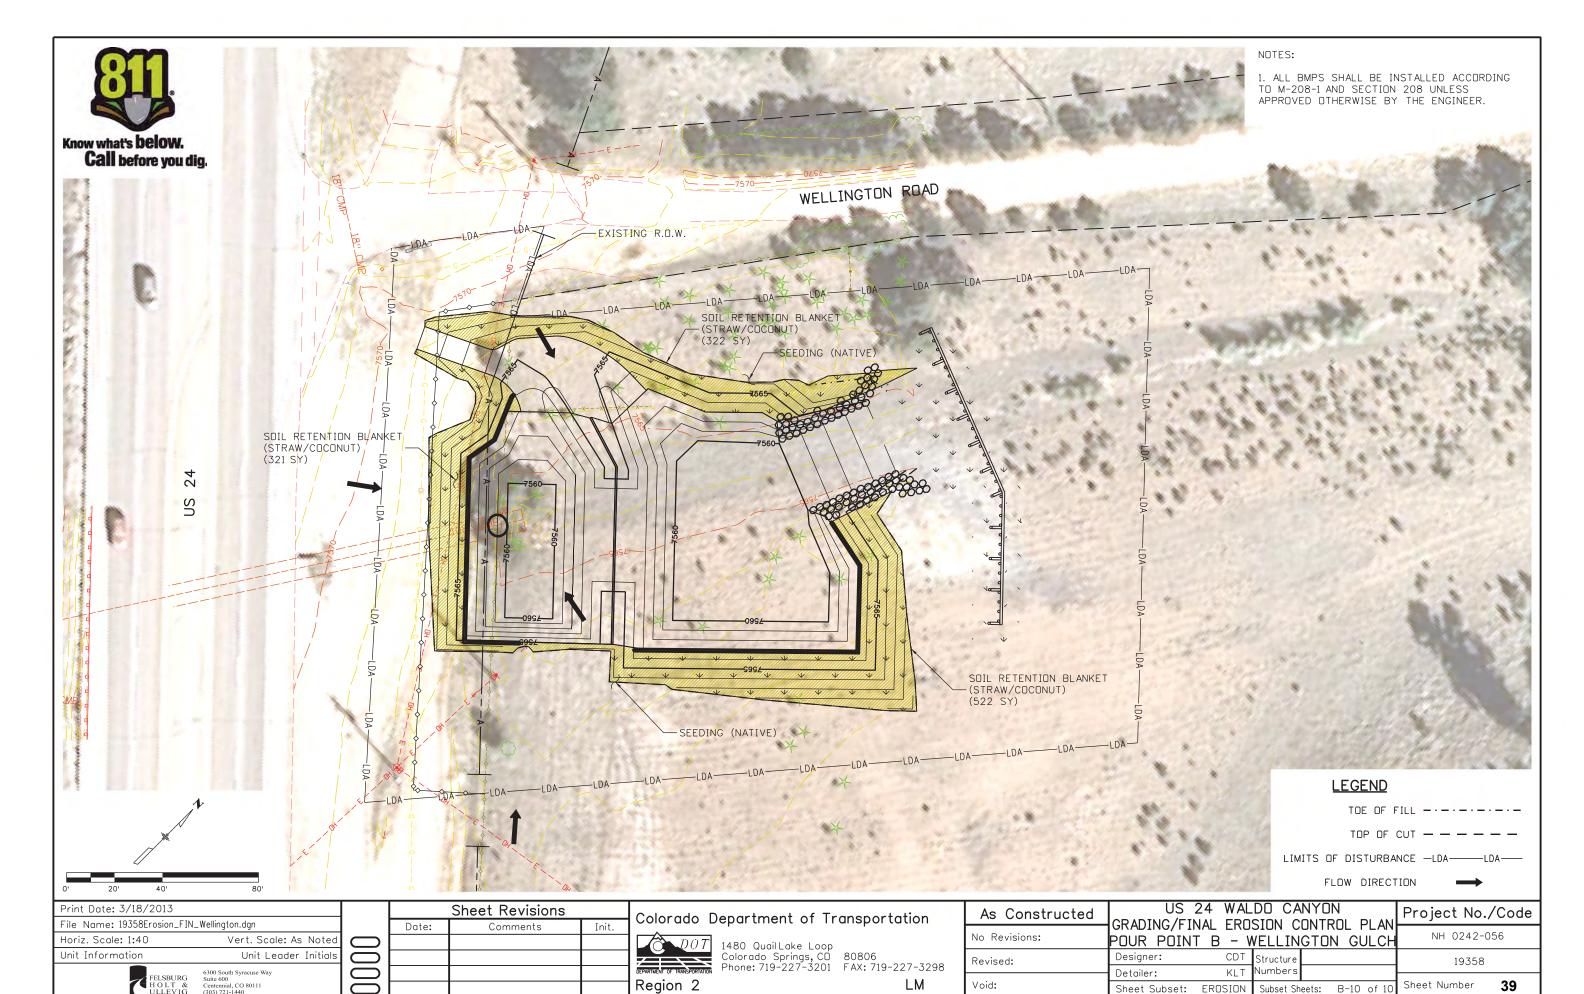
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No Revisions:	POUR POINT B - WELLINGTON G	GULCH	NH 0242-056
Revised:	Designer: CDT Structure Detailer: KLT Numbers		19358
Void:	881811	5 of 10	Sheet Number 34









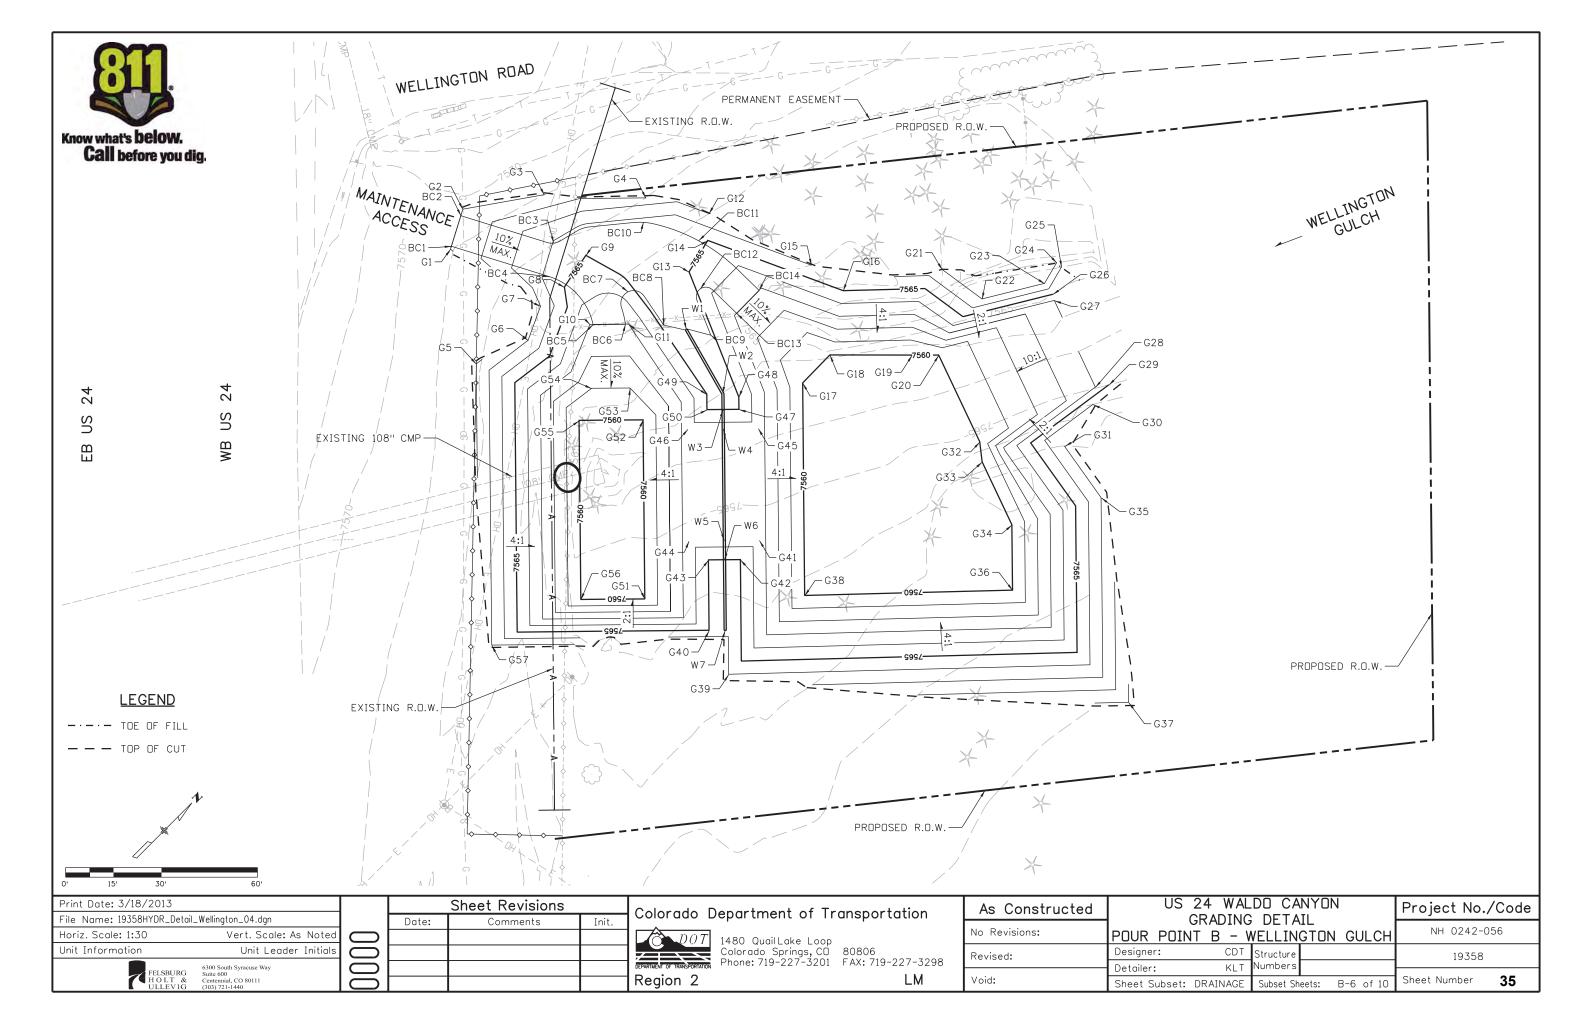

POUR POINT C TABULATION

CONTRACT ITEM NO.	CONTRACTITÉM	UNIT	QUANTITY
201-00001	CLEARING AND GRUBBING	LS	1
202-00010	REMOVAL OF TREE	EA	17
202-00220	REMOVAL OF ASPHALT MAT	SY	792
202-01000	REMOVAL OF FENCE	LF	137
202-04002	CLEAN CULVERT	EA	7
203-00010	UNCLASSIFIED EXCAVATION (COMPLETE IN PLACE)	CY	3000
203-01622	SWEEPING (WITH PICKUP BROOM)	HR	40
207-00205	TOPSOIL	CY	320
208-00002	EROSION LOG (12 INCH)	LF	1300
208-00020	SILT FENCE	LF	241
208-00034	GRAVEL BAG	LF	486
208-00045	CONCRETE WASHOUT STRUCTURE	EA	1
208-00070	VEHICLE TRACKING PAD	EA	1
208-00103	REMOVAL AND DISPOSAL OF SEDIMENT (LABOR)	HR	80
208-00105	REMOVAL AND DISPOSAL OF SEDIMENT (EQUIPMENT)	HR	40
208-00205	EROSION CONTROL SUPERVISOR	DAY	30
210-01130	RESET GUARDRAIL TYPE 3	LF	43
212-00006	SEEDING (NATIVE)	AC	0.4
212-00032	SOIL CONDITIONING	AC	0.4
213-00002	MULCHING (WEED FREE)	AC	0.4
214-00450	EVERGREEN TREE (5 GALLON CONTAINER)	EA	17
216-00041	SOIL RETENTION BLANKET (STRAW/COCONUT)	SY	2105
304-06000	AGGREGATE BASE COURSE (CLASS 6)	CY	23
420-00102	GEOTEXTILE (EROSION CONTROL) (CLASS 1)	SY	1171
506-00030	GROUTED RIPRAP	CY	120
506-00412	SOIL RIPRAP (12 INCH)	CY	423
507-00725	SLOPE AND DITCH PAVING (SPECIAL)	CY	120
601-01000	CONCRETE CLASS B	CY	103
603-01240	24 INCH REINFORCED CONCRETE PIPE (CIP)	LF	154
603-01420	42 INCH REINFORCED CONCRETE PIPE (CIP)	LF	108
603-05024	24 INCH REINFORCED CONCRETE END SECTION	EA	4
603-05042	42 INCH REINFORCED CONCRETE END SECTION	EA	2
604-50050	INLET GRATING AND FRAME SPECIAL	EA	1
608-00100	REINFORCED GRASS/CONCRETE POROUS PAVEMENT	SY	491

NOTE: TREES SHALL BE PLACED AS DIRECTED BY THE ENGINEER.

	INDEX		ITEM	PROJECT TOTALS	
воок	PAGE	SHEET	ITEM	PROJECT TOTALS	
			EMBANKMENT MATERIAL (CIP) (FOR INFO. ONLY)	CU. YDS.	
			CASCADE SLIDE AREA	881	
			SUBTOTAL	881	
			TOTAL	881	
			UNCLASSIFIED EXCAVATION	CU. YDS.	
			CASCADE SLIDE AREA	2,921	
			OTHER EXCAVATION	79	
			SUBTOTAL	3,000	
			TOTAL FOR PAY QUANTITY	3,000	

	COMPACTION (FOR INFORMATION ONLY) (MOISTURE & DENSITY CONTROL) EMBANKMENT (NET)	881
	TOTAL	881
1	WETTING QUANTITIES (FOR INFORMATION ONLY) COMPACTION	M. GAL.
	(881 x 0.040 M. GAL./yd) TOTAL	35 35
1	ACCESS ROAD QUANTITIES BALANCE (FOR INFORMATION ONLY	CU. YDS.
	EMBANKMENT (NET)	881
	EMBANKMENT X FACTOR (1.15)	1,013
	BALANCE TOTAL	1,013
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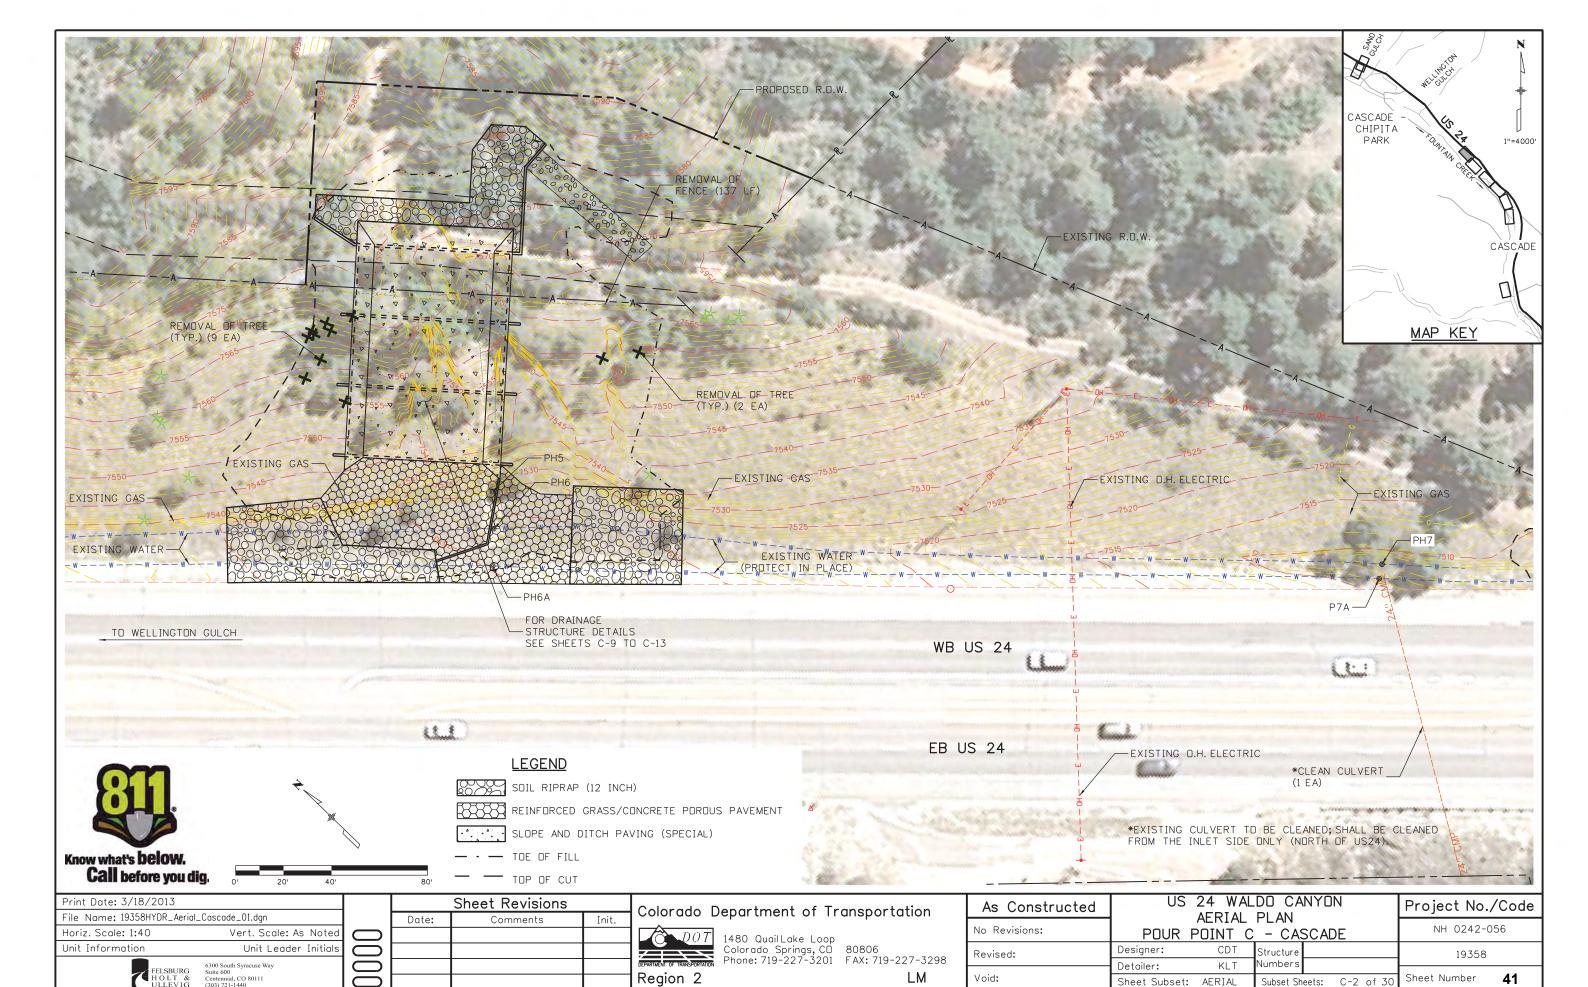
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HOLT & ULLEVIG	Centennial, CO 80111 (303) 721-1440		


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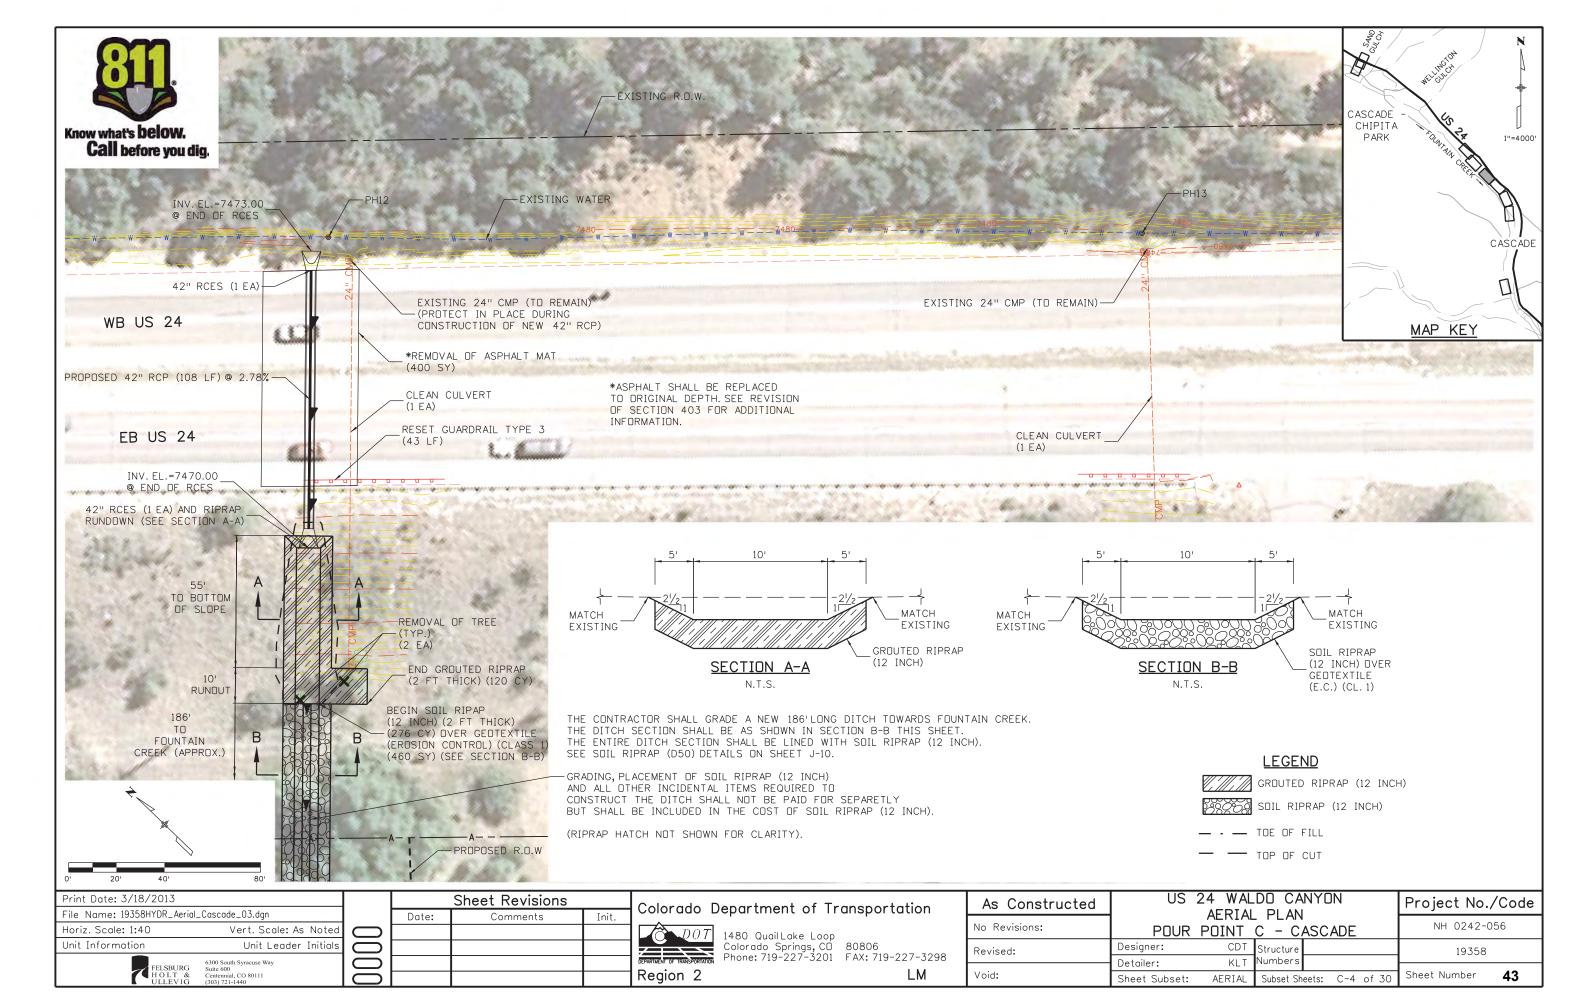
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Colorado Springs, CD 80806 Phone: 719-227-3201 FAX: 719-227-3298	


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No Revisions:	POUR	POINT		ASC/	ADE	NH 0242-0)56
Revised:	Designer:	CDT	Structure			19358	
	Detailer:	KLT	Numbers				
Void:	Sheet Subset:	TAB	Subset Sh	eets:	C-1 of 30	Sheet Number	40


Region 2






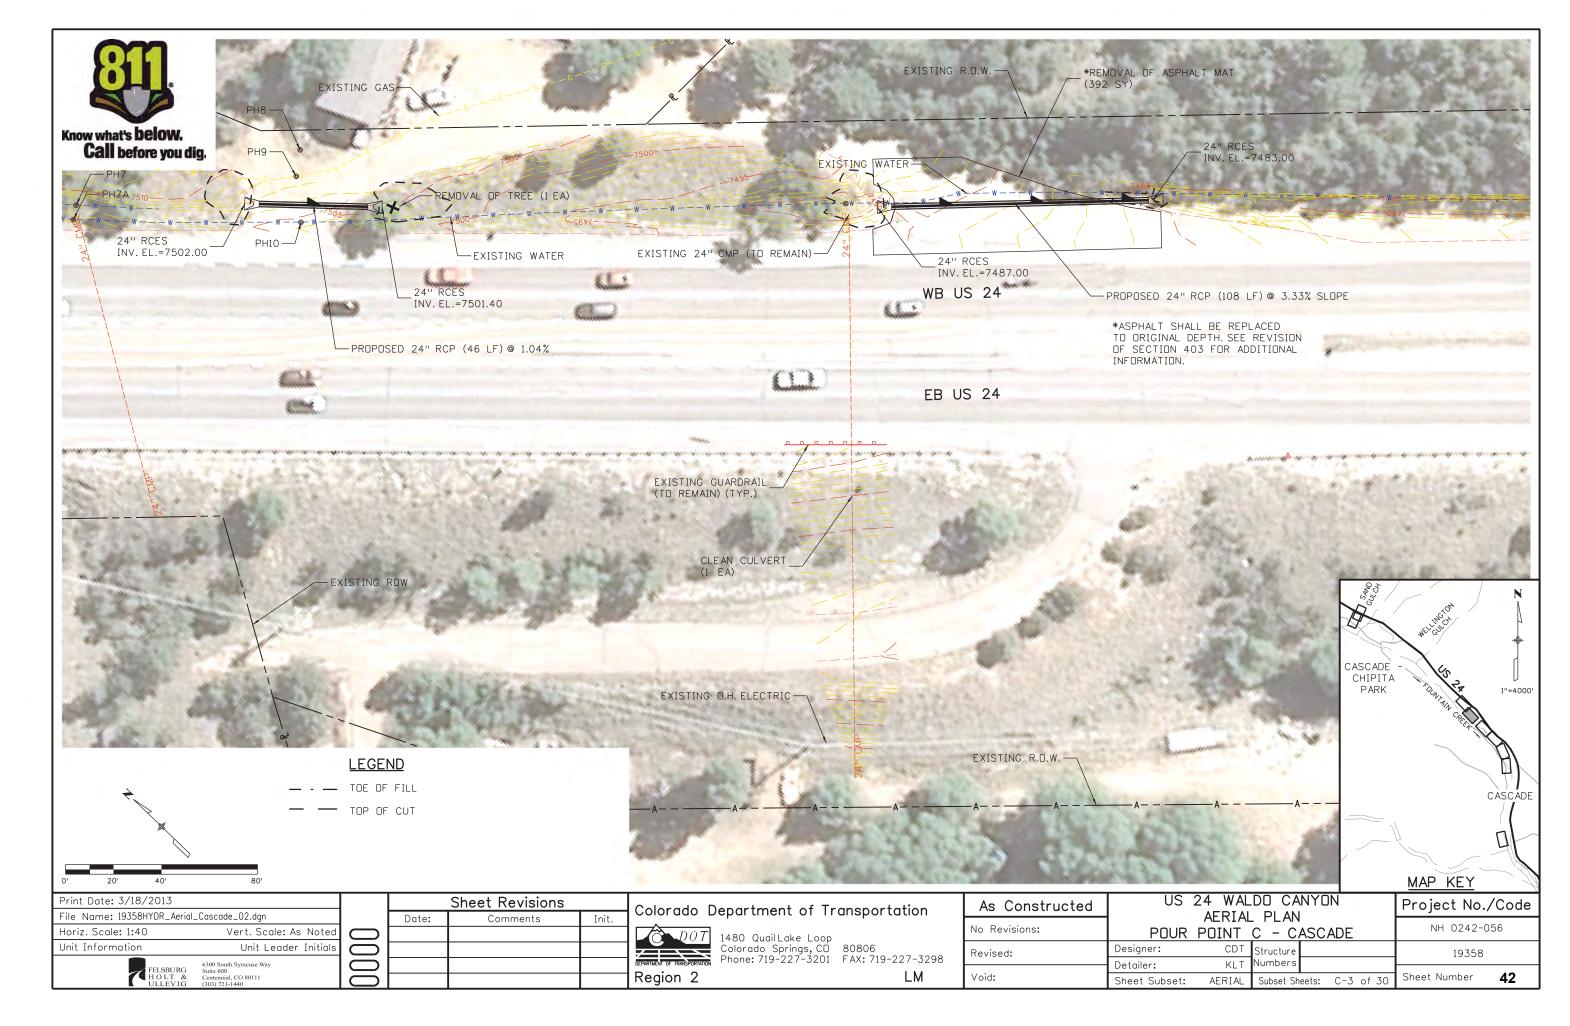

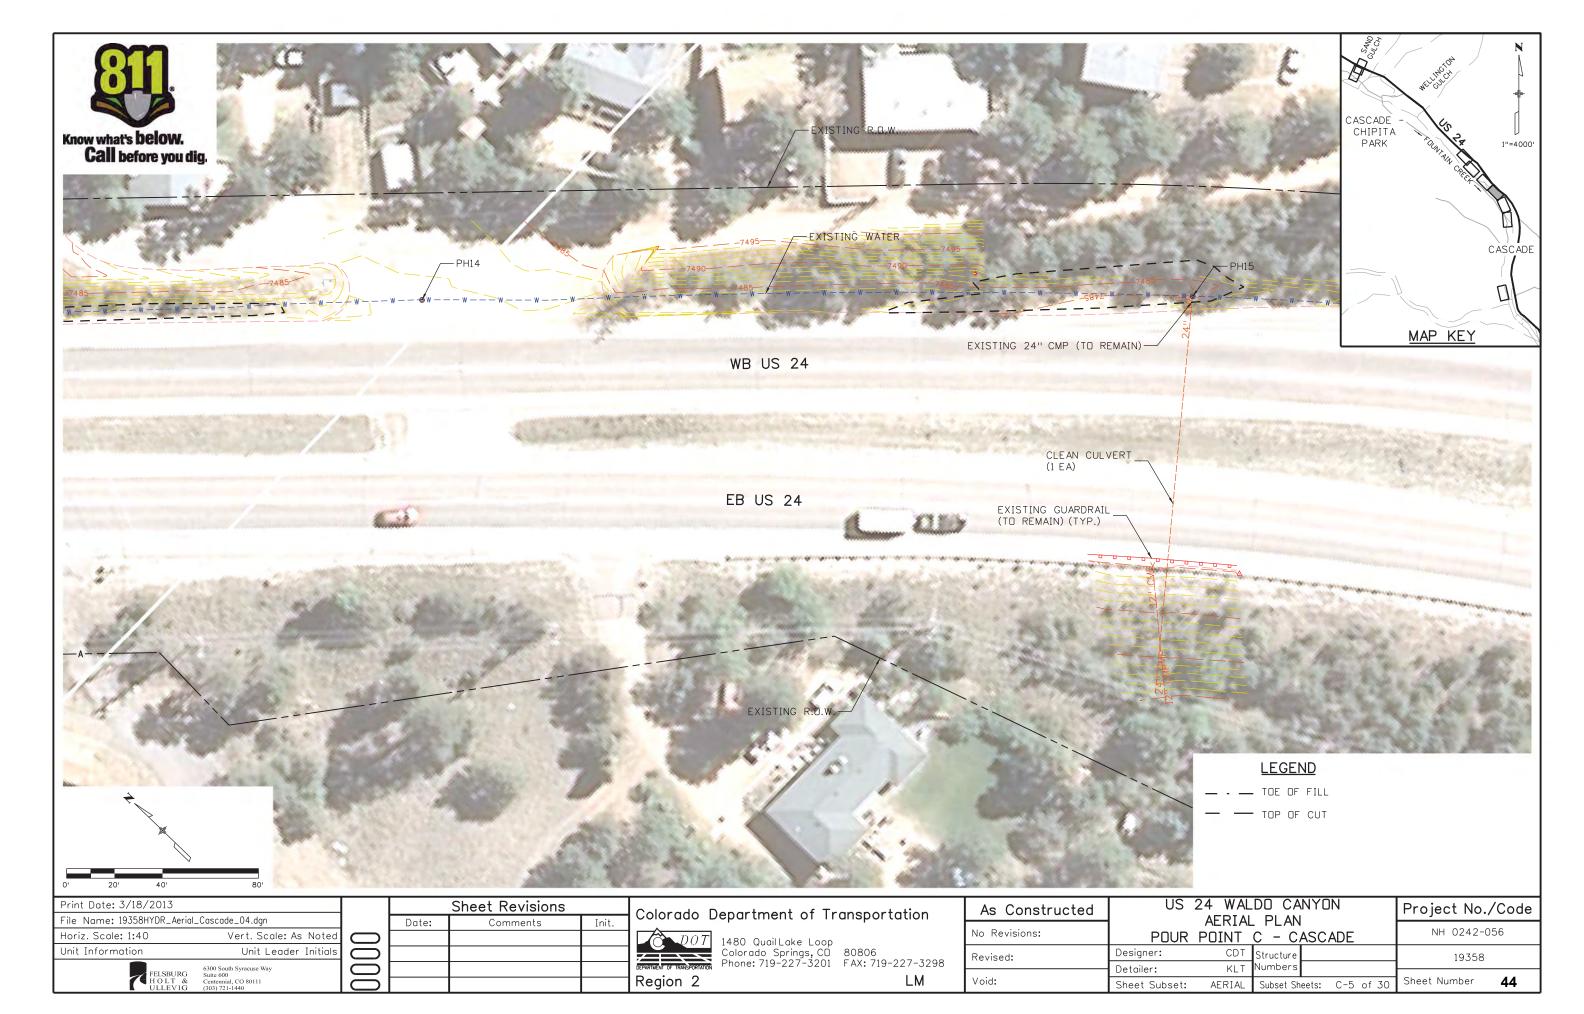

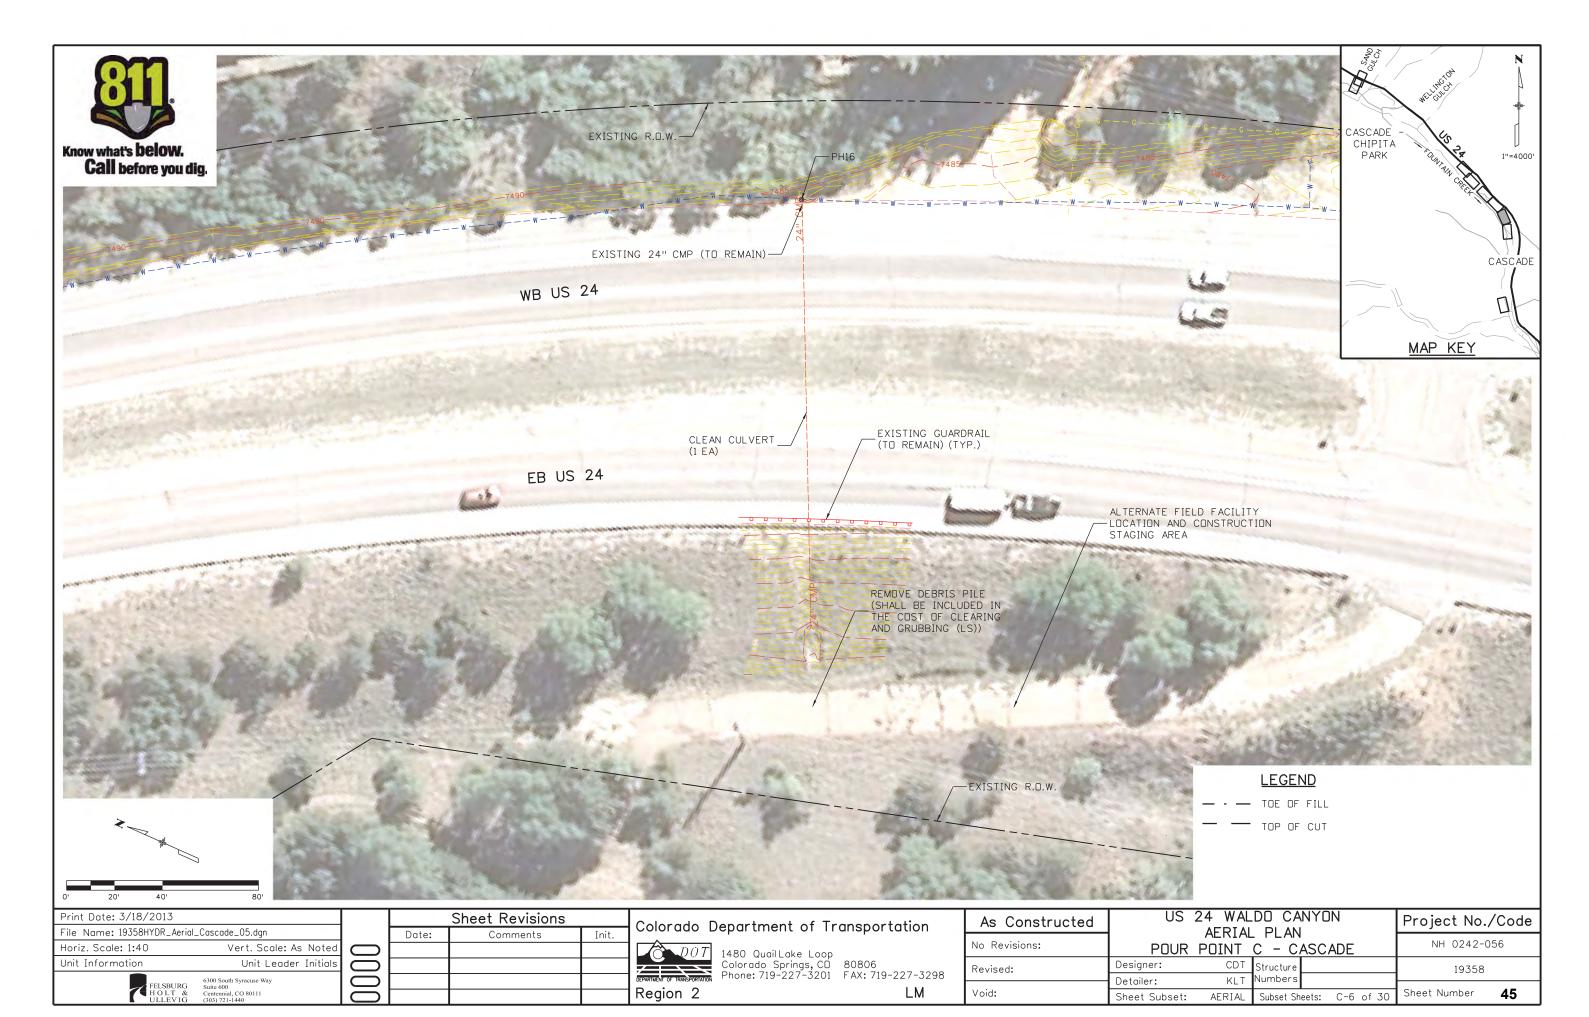

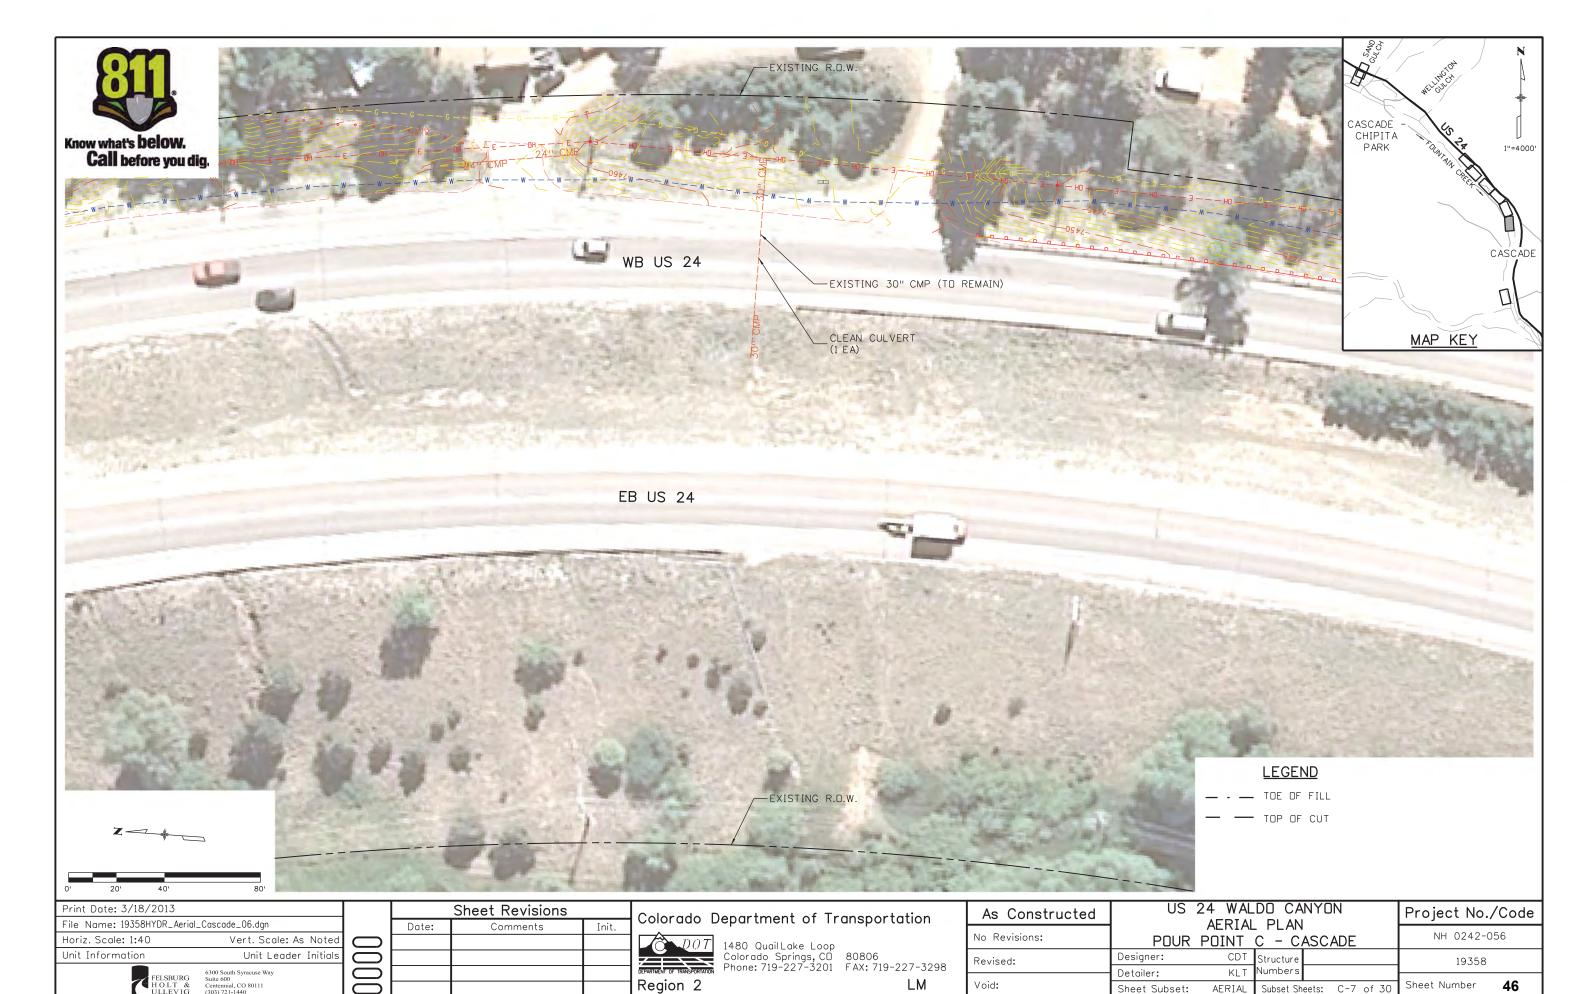



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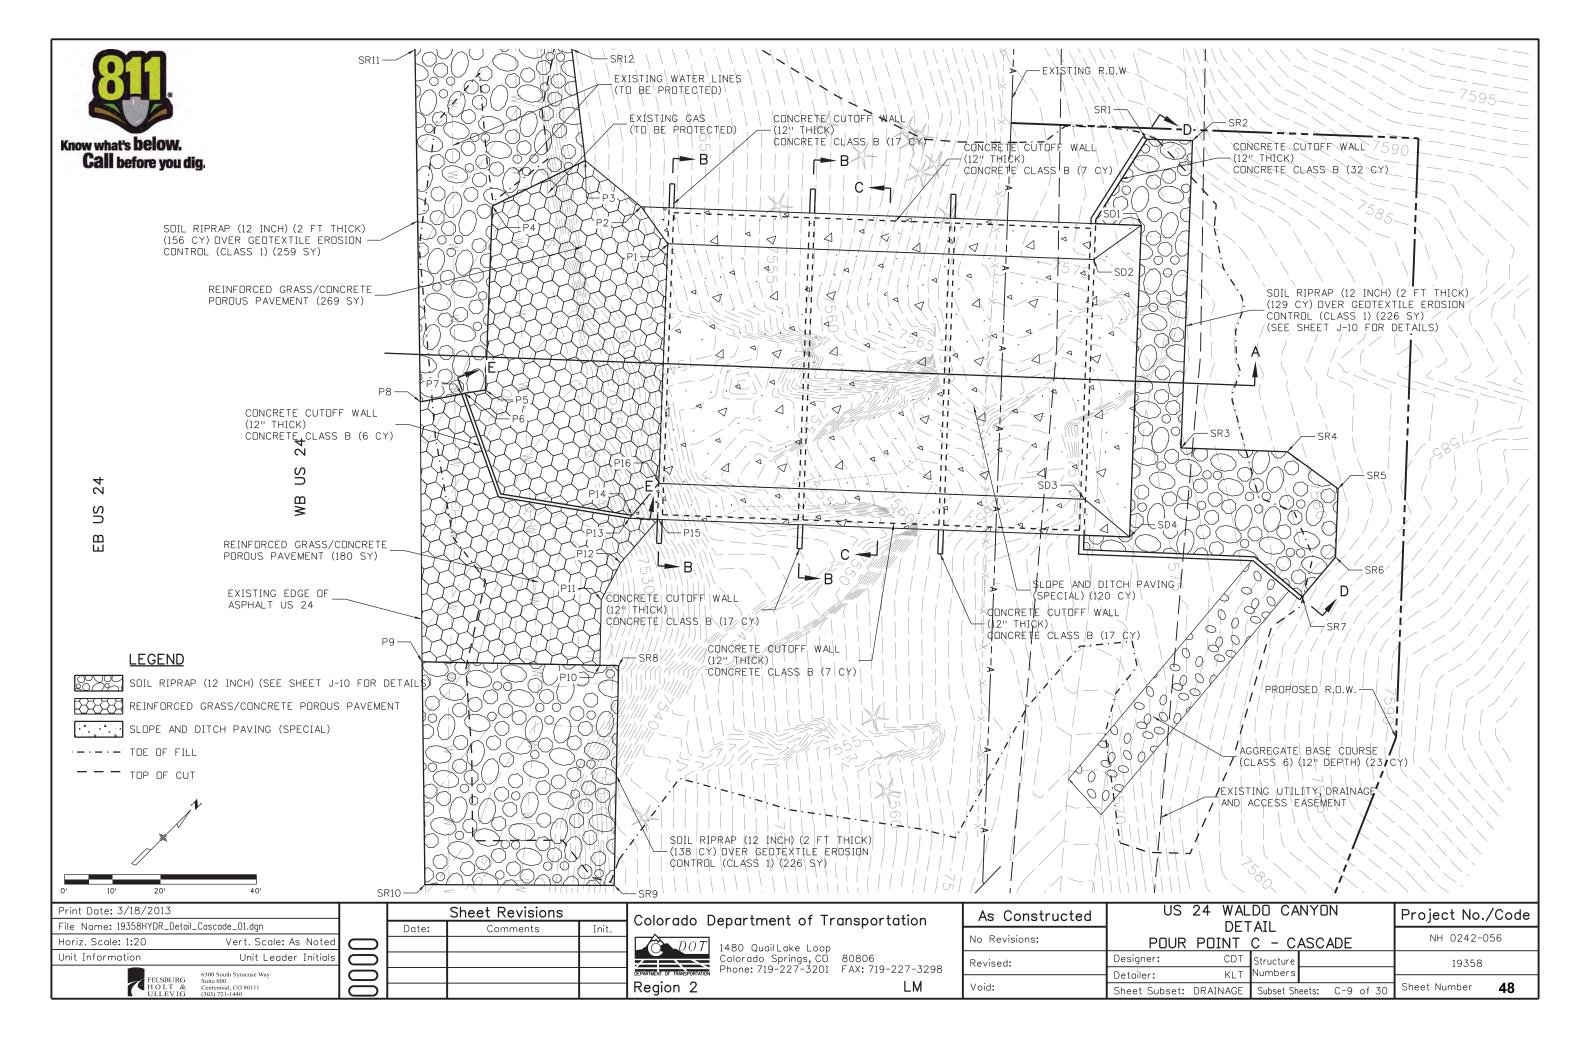
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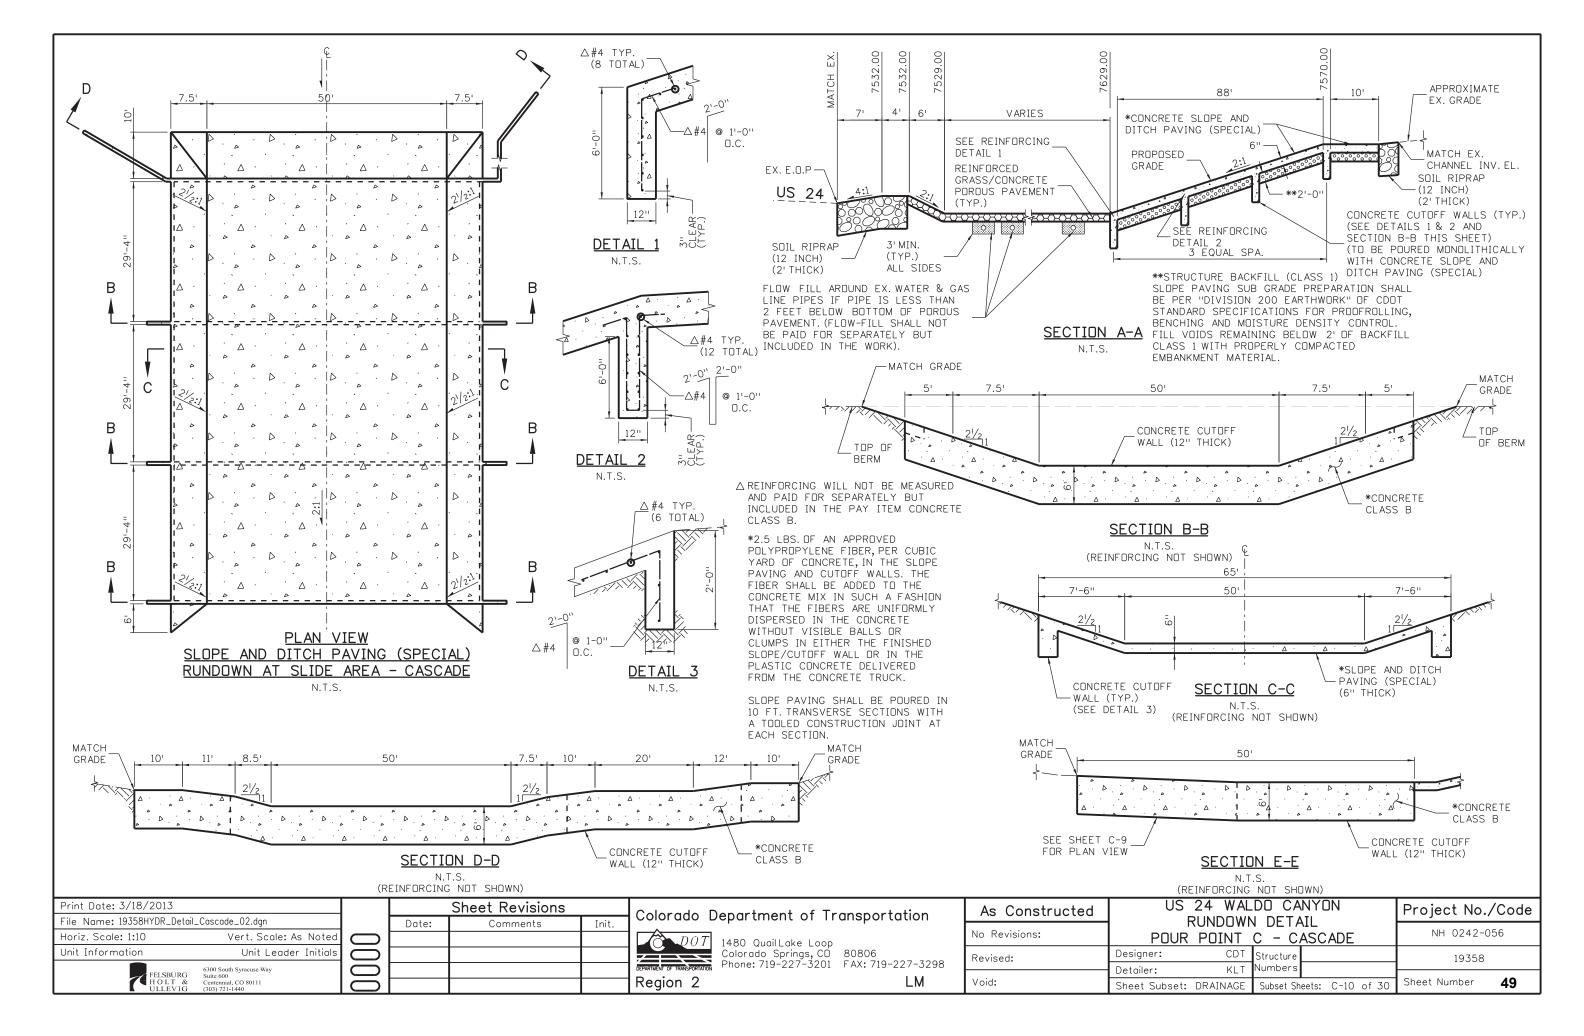
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Subset Sheets: C-8 of 30

Sheet Number

Region 2





POINT DATA TABLE - POUR POINT C - GRADING

POINT	NORTHING	EASTING	ELEVATION	DESCRIPTION
G1	393979.89	150030.24	7534.00	FINISHED GRADE
G2	393993.50	150029.05	7534.00	FINISHED GRADE
G3	393965.98	150042.28	7534.00	FINISHED GRADE
G4	393959.49	150044.49	7533.00	FINISHED GRADE
G5	393956.04	150056.19	7534.00	FINISHED GRADE
G6	393959.66	150058.32	7534.00	FINISHED GRADE
G7	393944.43	150058.82	7532.00	FINISHED GRADE
G8	393943.96	150069.61	7533.00	FINISHED GRADE
G9	393947.32	150071.64	7533.00	FINISHED GRADE
G10	393933.74	150072.82	7531.00	FINISHED GRADE
G11	393929.41	150092.20	7532.00	FINISHED GRADE
G12	393930.49	150093.83	7532.00	FINISHED GRADE
G13	393935.24	150090.66	7532.00	FINISHED GRADE
G14	393920.30	150092.96	7530.00	FINISHED GRADE
G15	393917.28	150102.85	7528.00	FINISHED GRADE
G16	393914.86	150113.64	7526.00	FINISHED GRADE
G17	393902.23	150111.91	7528.00	FINISHED GRADE
G18	393876.57	150136.72	7526.00	FINISHED GRADE
G19	393920.77	150122.49	7526.00	FINISHED GRADE
G20	393935.00	150114.99	7530.00	FINISHED GRADE
G21	393941.24	150117.13	7531.00	FINISHED GRADE
G22	393944.37	7 150088.20 7529.00		FINISHED GRADE
G23	393958.87	150109.92 7529.00		FINISHED GRADE
G24	393950.61	150079.37 7529.00 FINISHED GRAD		
G25	325 393971.41 150061.38		7529.00	FINISHED GRADE
G26	393984.12	150066.24	7529.00	FINISHED GRADE
G27	393993.61	150077.22	7529.00	FINISHED GRADE
G28	393993.03	150080.36	7529.00	FINISHED GRADE
G29	393975.35	150050.04	7532.00	FINISHED GRADE
G30	393989.46	150059.72	7531.00	FINISHED GRADE
G31	393997.24	150054.13	7533.00	FINISHED GRADE
G32	393997.44	150044.05	7534.00	FINISHED GRADE
G33	394013.08	150034.09	7541.00	FINISHED GRADE
G34	394034.63	150055.11	7552.00	FINISHED GRADE
G35	394046.16	150104.36	7565.00	FINISHED GRADE

POINT	NORTHING	EASTING	ELEVATION	DESCRIPTION
G36	394064.09	150125.26	7575.00	FINISHED GRADE
G37	394070.02	150127.21	7576.00	FINISHED GRADE
G38	394078.49	150137.84	7580.00	FINISHED GRADE
G39	394079.74	150141.67	7580.00	FINISHED GRADE
G40	394057.97	150126.40	7575.00	FINISHED GRADE
G41	394064.79	150140.39	7580.00	FINISHED GRADE
G42	394067.82	150143.90	7580.00	FINISHED GRADE
G43	394077.89	150160.12	7579.00	FINISHED GRADE
G44	394061.27	150154.67	7576.00	FINISHED GRADE
G45	394018.92	150191.30	7576.00	FINISHED GRADE
G46	394023.80	150206.11	7578.00	FINISHED GRADE
G47	394034.95	150203.92	7578.00	FINISHED GRADE
G48	394041.92	150215.57	7579.00	FINISHED GRADE
G49	394034.53	150227.29	7581.00	FINISHED GRADE
G50	394033.93	150215.99	7581.00	FINISHED GRADE
G51	394025.94	150216.41	7581.00	FINISHED GRADE
G52	394026.62	150229.29	7581.00	FINISHED GRADE
G53	394022.47	150226.61	7580.00	FINISHED GRADE
G54	394021,10	150209.11	7578.00	FINISHED GRADE
G55	394005.55	150209.48	7574.00	FINISHED GRADE
G56	394009.27	150189.32	7578.00	FINISHED GRADE
G57	394006.29	150191.99	7578.00	FINISHED GRADE
G58	393967.00	150197.02	7567.00	FINISHED GRADE
G59	393975.10	150201.79	7568.00	FINISHED GRADE
G60	393982.00	150218.73	7570.00	FINISHED GRADE
G61	393982.53	150228.71	7570.00	FINISHED GRADE
G62	393980.16	150246.51	7578.00	FINISHED GRADE
G63	393948.04	150208.65	7565.00	FINISHED GRADE
G64	393989.44	150165.29	7563.00	FINISHED GRADE
G65	393926.94	150183.21	7552.00	FINISHED GRADE
G66	393916.07	150160.58	7542.00	FINISHED GRADE
G67	393934.58	150130.41	7538.00	FINISHED GRADE
G68	393933.75	150117.42	7531.00	FINISHED GRADE
G69	393928.44	150127.45	7535.00	FINISHED GRADE
G70	393898.54	150161.41	7538.00	FINISHED GRADE

Init.

Region 2

POINT DATA TABLE - POUR POINT C - CUTOFF WALL

POINT	NORTHING	EASTING	ELEVATION	DESCRIPTION
W1	394078.52	150139.87	7580.00	CONCRETE CUTOFF WALL - FINISHED GRADE EL.
W2	394066.30	150142.14	7580.00	CONCRETE CUTOFF WALL - FINISHED GRADE EL.
W3	394058.86	150143.53	7577.50	CONCRETE CUTOFF WALL - FINISHED GRADE EL.
VV4	394006.33	150188.98	7577.33	CONCRETE CUTOFF WALL - FINISHED GRADE EL.
W5	394007.78	150190.66	7578.00	CONCRETE CUTOFF WALL - FINISHED GRADE EL.
W6	394024.31	150209.77	7579.00	CONCRETE CUTOFF WALL - FINISHED GRADE EL.
W7	394029.94	150216.27	7581.00	CONCRETE CUTOFF WALL - FINISHED GRADE EL.
W8	394030.61	150229.08	7581.00	CONCRETE CUTOFF WALL - FINISHED GRADE EL.
W9	394034.32	150109.00	7578.04	CONCRETE CUTOFF WALL - FINISHED GRADE EL.
W10	393977.60	150158.06	7557.75	CONCRETE CUTOFF WALL - FINISHED GRADE EL.
W11	394004.34	150074.33	7535.25	CONCRETE CUTOFF WALL - FINISHED GRADE EL.
W12	393947.61	150123.40	753.5.25	CONCRETE CUTOFF WALL - FINISHED GRADE EL.
W13	393942.63	150072.31	7532.75	CONCRETE CUTOFF WALL - FINISHED GRADE EL.
W14	393932.28	150092.30	7532.00	CONCRETE CUTOFF WALL - FINISHED GRADE EL.
W15	393933.42	150094.01	7531.00	CONCRETE CUTOFF WALL - FINISHED GRADE EL.
W16	393947.64	150115.32	7531,00	CONCRETE CUTOFF WALL - FINISHED GRADE EL.

POINT DATA TABLE - POUR POINT C - SLOPE AND DITCH PAVING

POINT	NORTHING	EASTING	ELEVATION	DESCRIPTION
SD1	394064.67	150151.72	7577.50	SLOPE AND DITCH PAVING FINISHED GRADE ELEVATION
SD2	394052.68	150149.32	7574.50	SLOPE AND DITCH PAVING FINISHED GRADE ELEVATION
SD3	394014.86	150182.03	7574.50	SLOPE AND DITCH PAVING FINISHED GRADE ELEVATION
SD4	394015.52	150194.25	7577.50	SLOPE AND DITCH PAVING FINISHED GRADE ELEVATION

POINT DATA TABLE - POUR POINT C - POROUS PAVERS

POINT	NORTHING	EASTING	ELEVATION	DESCRIPTION
P1	393994.66	150082.26	7530.00	REINFORCED GRASS/CONC. POROUS PAVEMENT FINISHED GRADE EL.
P2	393996.41	150072.81	7531.00	REINFORCED GRASS/CONC. POROUS PAVEMENT FINISHED GRADE EL.
P3	393995.52	150057.76	7532.00	REINFORCED GRASS/CONC. POROUS PAVEMENT FINISHED GRADE EL.
P4	393975.35	150050.04	7532.00	REINFORCED GRASS/CONC. POROUS PAVEMENT FINISHED GRADE EL.
P5	393946.33	150075.15	7532.00	REINFORCED GRASS/CONC. POROUS PAVEMENT FINISHED GRADE EL.
P6	393942.92	150072.46	7532.75	REINFORCED GRASS/CONC. POROUS PAVEMENT FINISHED GRADE EL.
P7	393942.33	150072.15	7532.75	REINFORCED GRASS/CONC. POROUS PAVEMENT FINISHED GRADE EL.
P8	393935.29	150066.90	1	REINFORCED GRASS/CONC. POROUS PAVEMENT MATCH EX. GRADE EL.
P9	393895.89	150104.12	19.5	REINFORCED GRASS/CONC. POROUS PAVEMENT MATCH EX. GRADE EL.
P10	393920.64	150131.75	7533.00	REINFORCED GRASS/CONC. POROUS PAVEMENT FINISHED GRADE EL.
P11	393930.80	150122.65	7533.00	REINFORCED GRASS/CONC. POROUS PAVEMENT FINISHED GRADE EL.
P12	393939.24	150120.33	7533.00	REINFORCED GRASS/CONC. POROUS PAVEMENT FINISHED GRADE EL.
P13	393947.25	150115.34	7531.00	REINFORCED GRASS/CONC. POROUS PAVEMENT FINISHED GRADE EL.
P14	393948.04	150115.31	7531.00	REINFORCED GRASS/CONC. POROUS PAVEMENT FINISHED GRADE EL.
P15	393951.18	150119.87	7533.00	REINFORCED GRASS/CONC. POROUS PAVEMENT FINISHED GRADE EL.
P16	393956.85	150114.97	7530.00	REINFORCED GRASS/CONC. POROUS PAVEMENT FINISHED GRADE EL.

POINT DATA TABLE - POUR POINT C - AGGREGATE BASE COURSE (CL. 6)


POINT	NORTHING	EASTING	ELEVATION	DESCRIPTION
BC1	393969.91	150219.36	7569.00	ABC (CL. 6) MATCH EX. GRADE EL.
BC2	393969.11	150229.42	7569.00	ABC (CL. 6) MATCH EX. GRADE EL.
BC3	394029.46	150216.23	7581.00	ABC (CL, 6) FINISHED GRADE EL.
BC4	394030.13	150226.21	7581.00	ABC (CL. 6) FINISHED GRADE EL.


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Unit Information	Unit Leader Initials			
FELSBURG HOLT &	6300 South Syracuse Way Suite 600 Centennial, CO 80111)()		


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DOT	1480 QuailLake Loop Colorado Springs, CO Phone: 719-227-3201	80806


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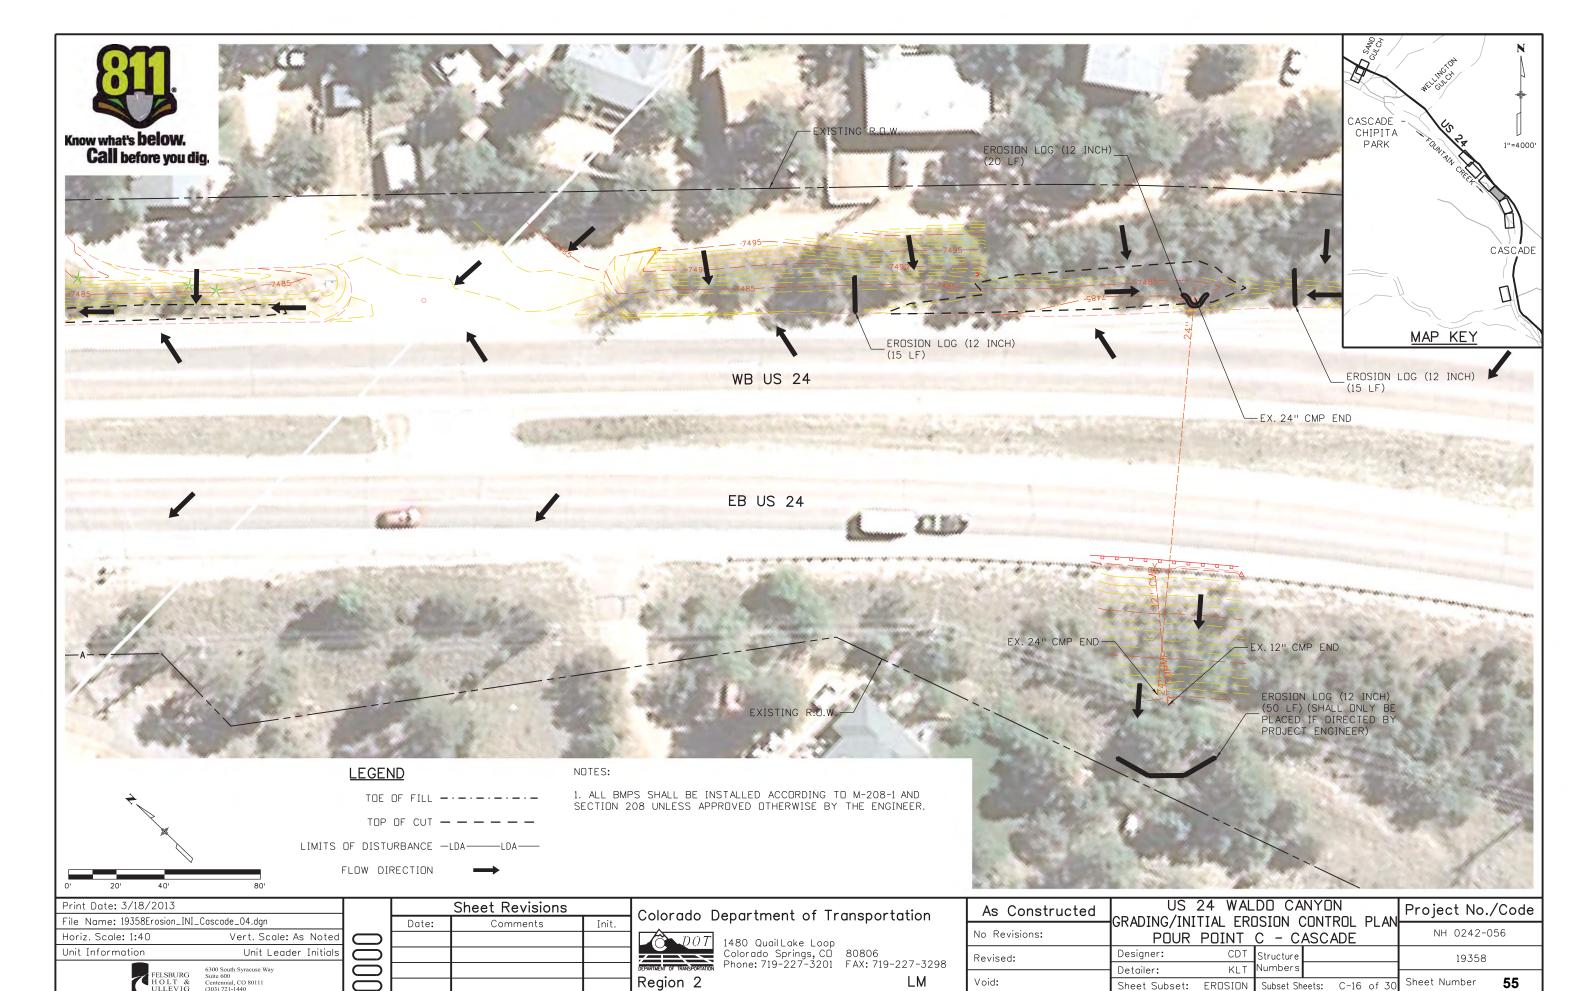
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Revised:		Structure Numbers	19358	
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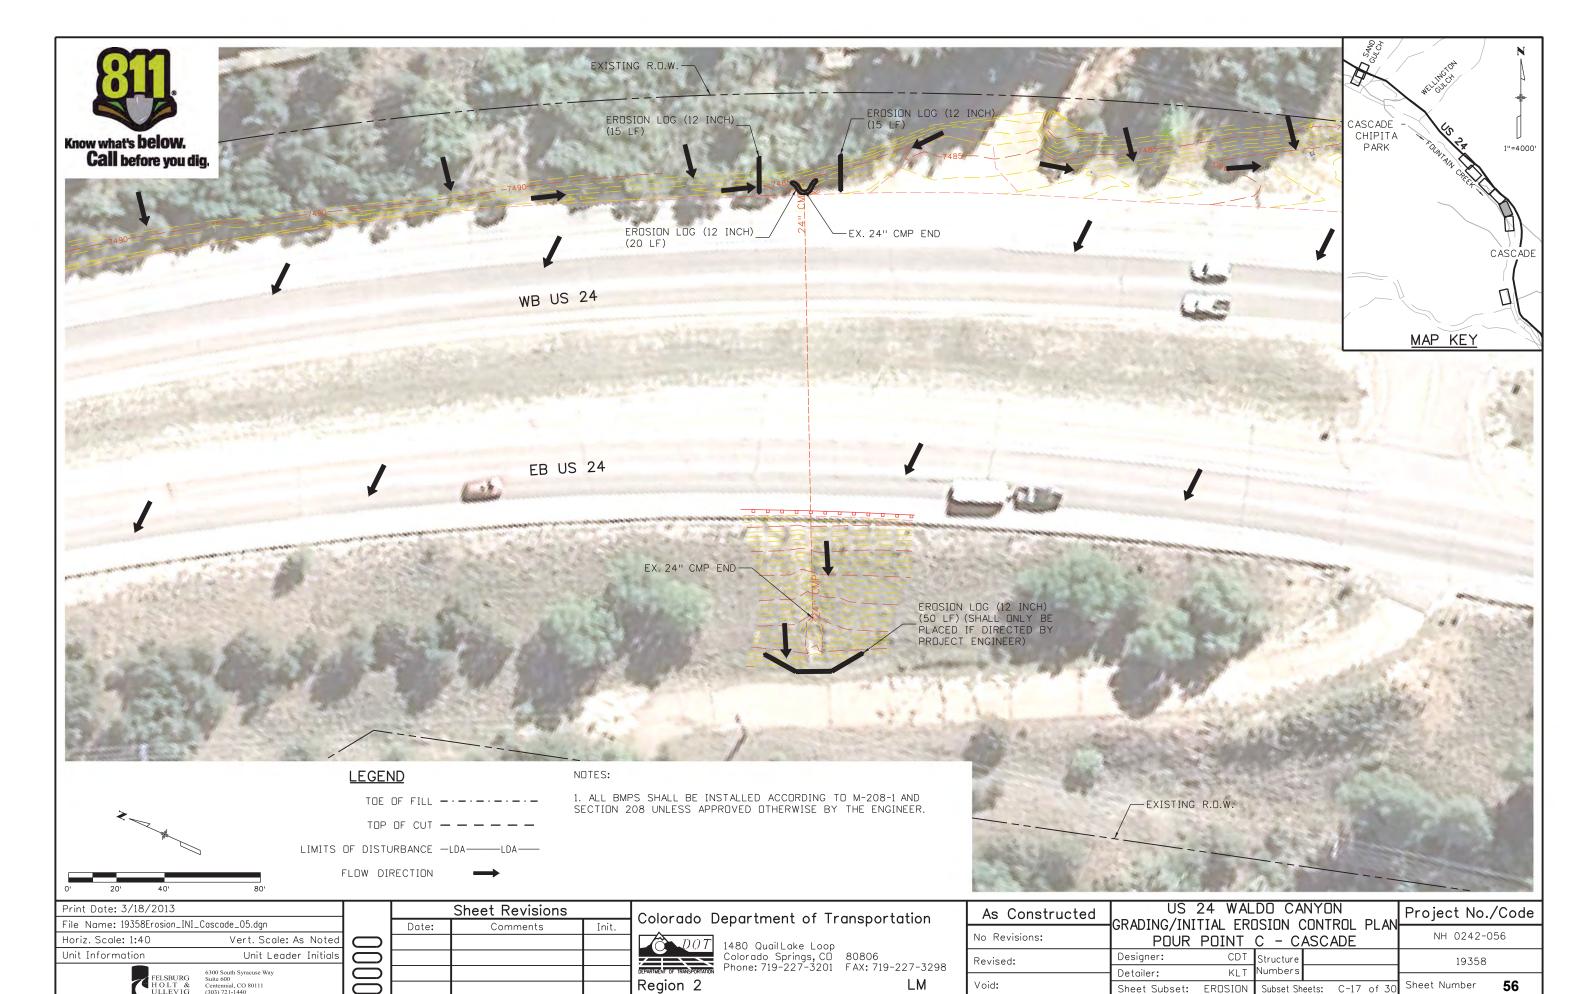





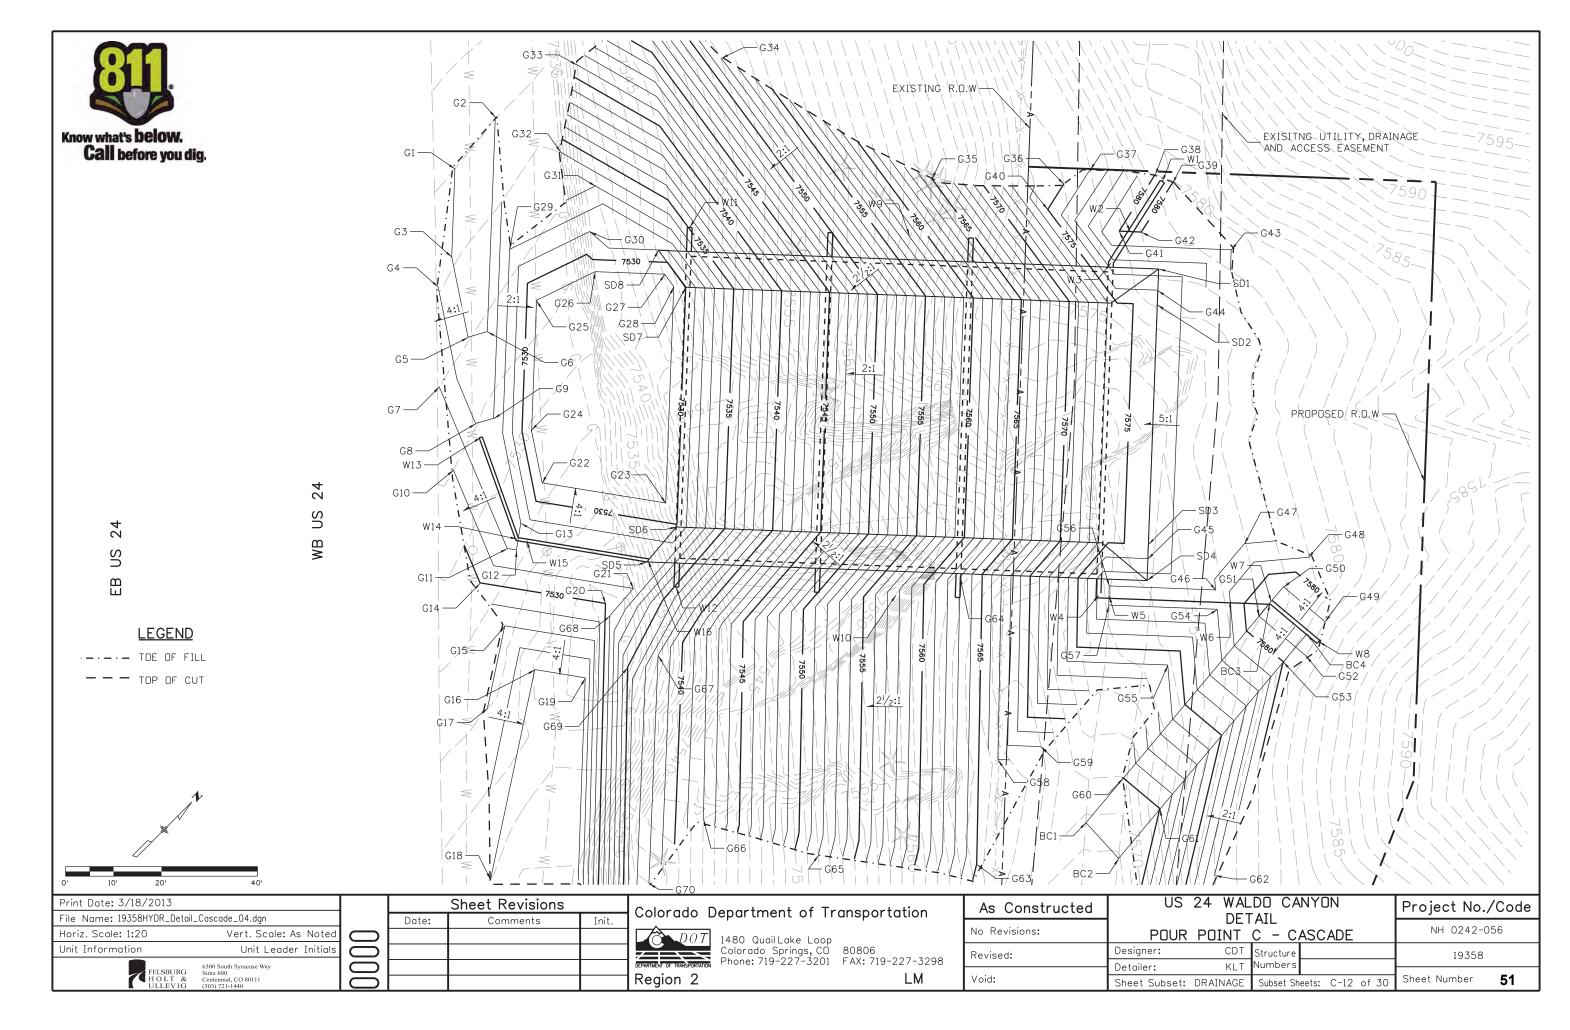


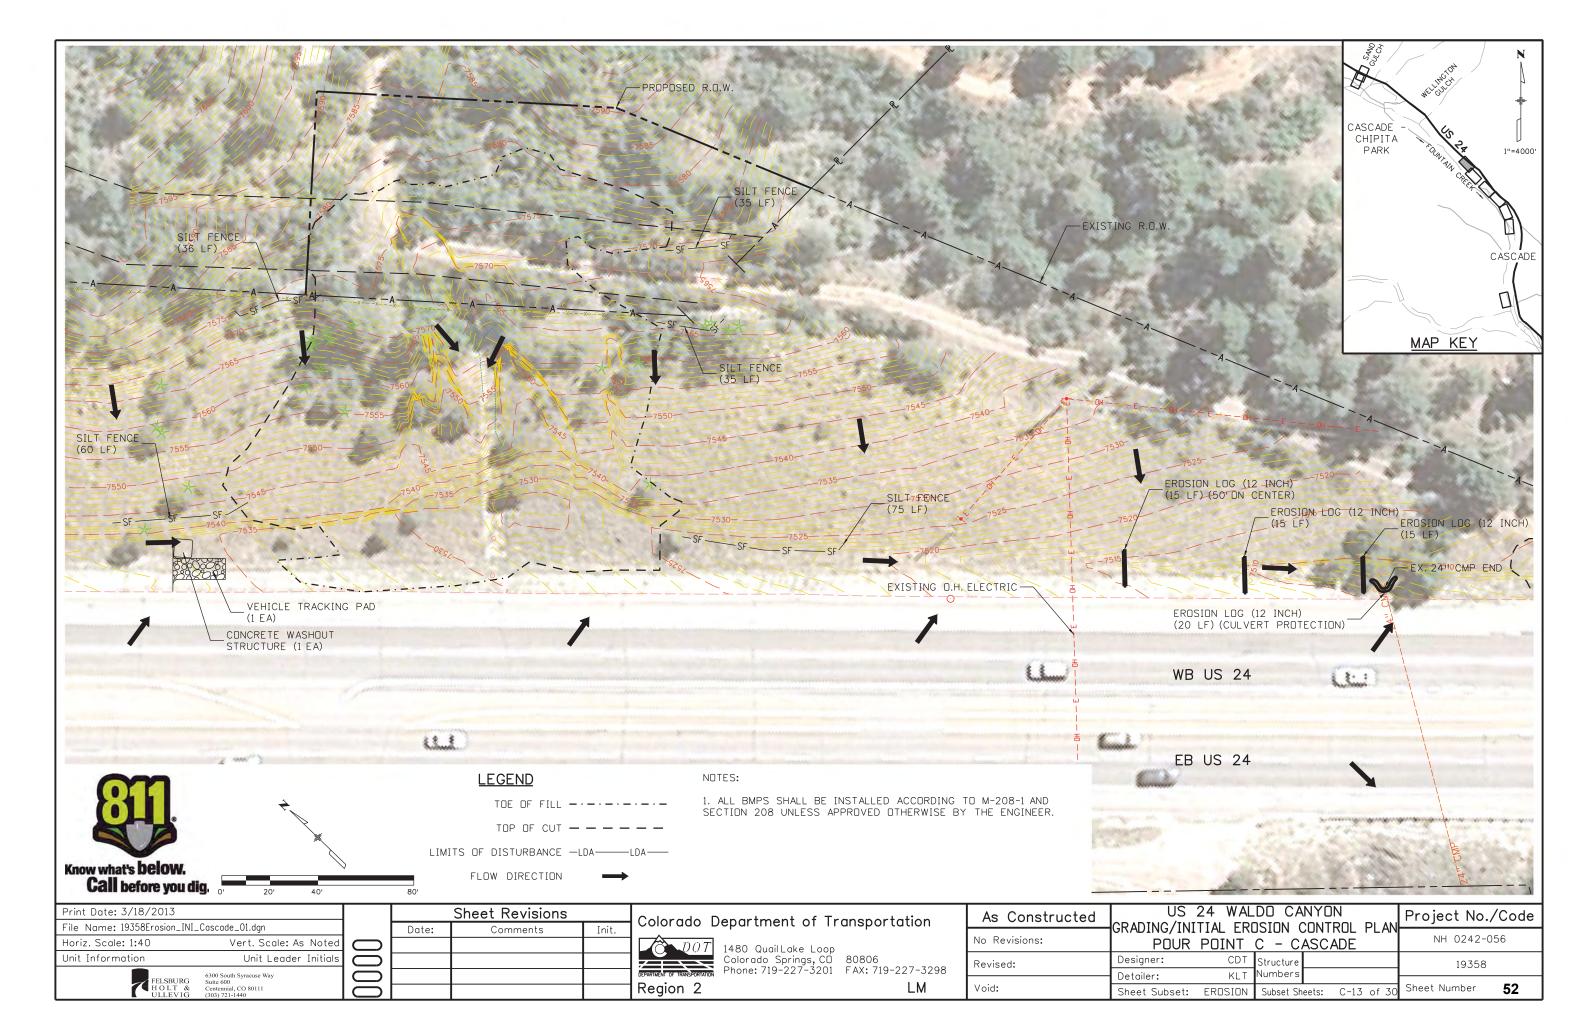


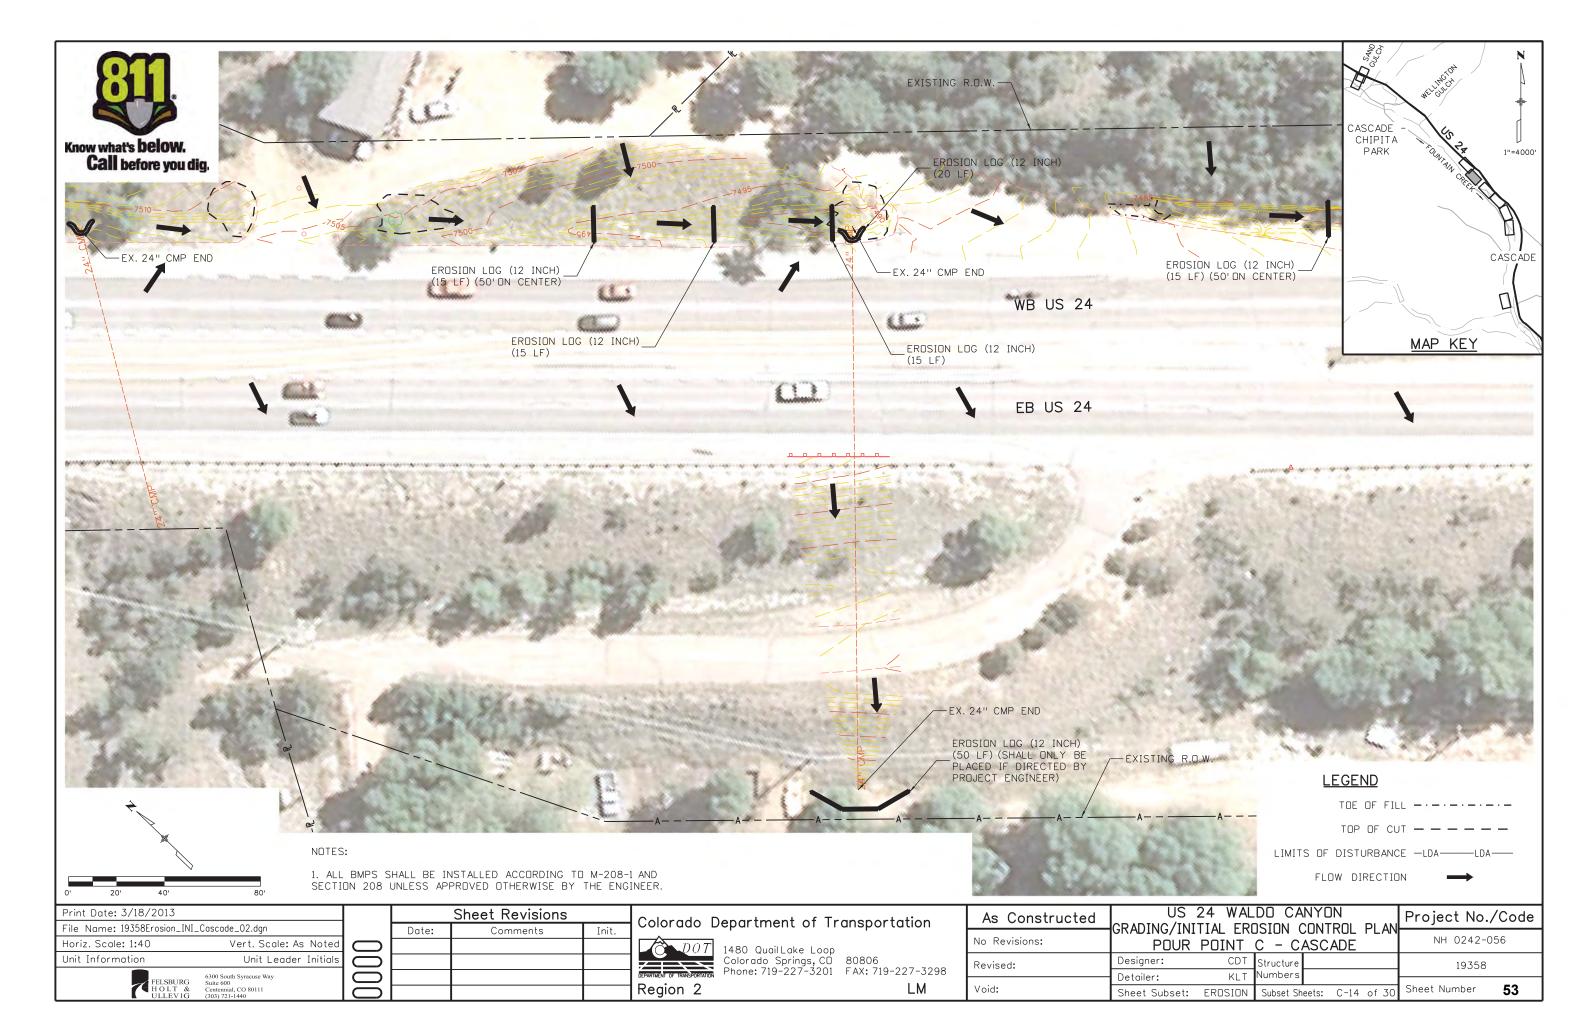


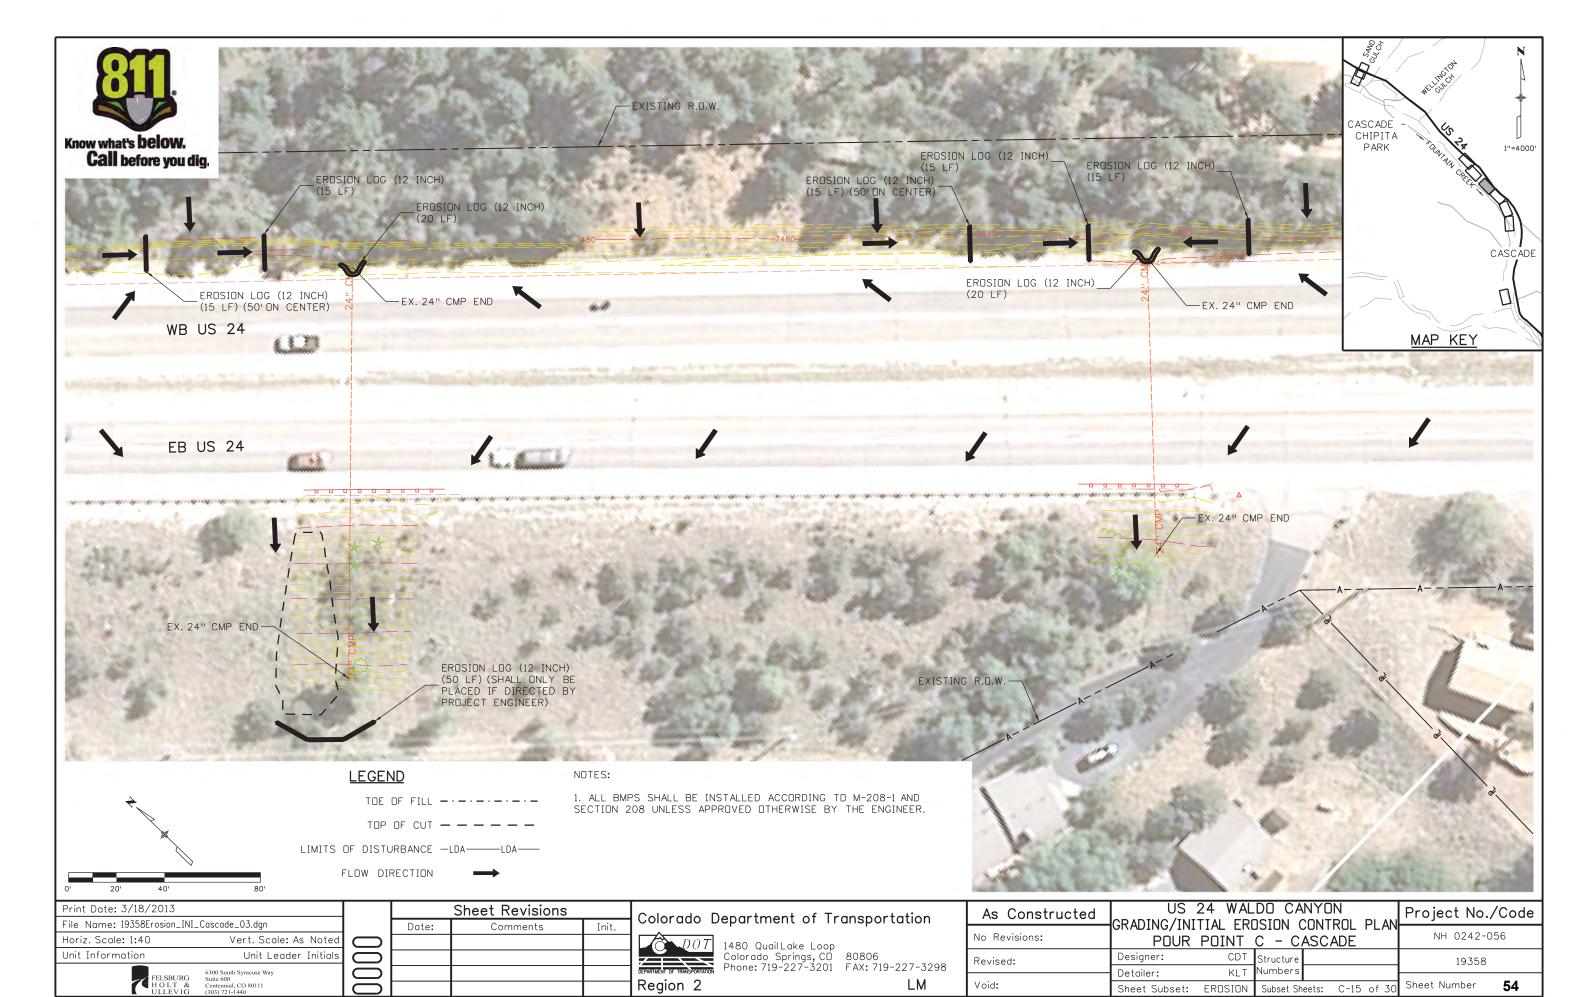


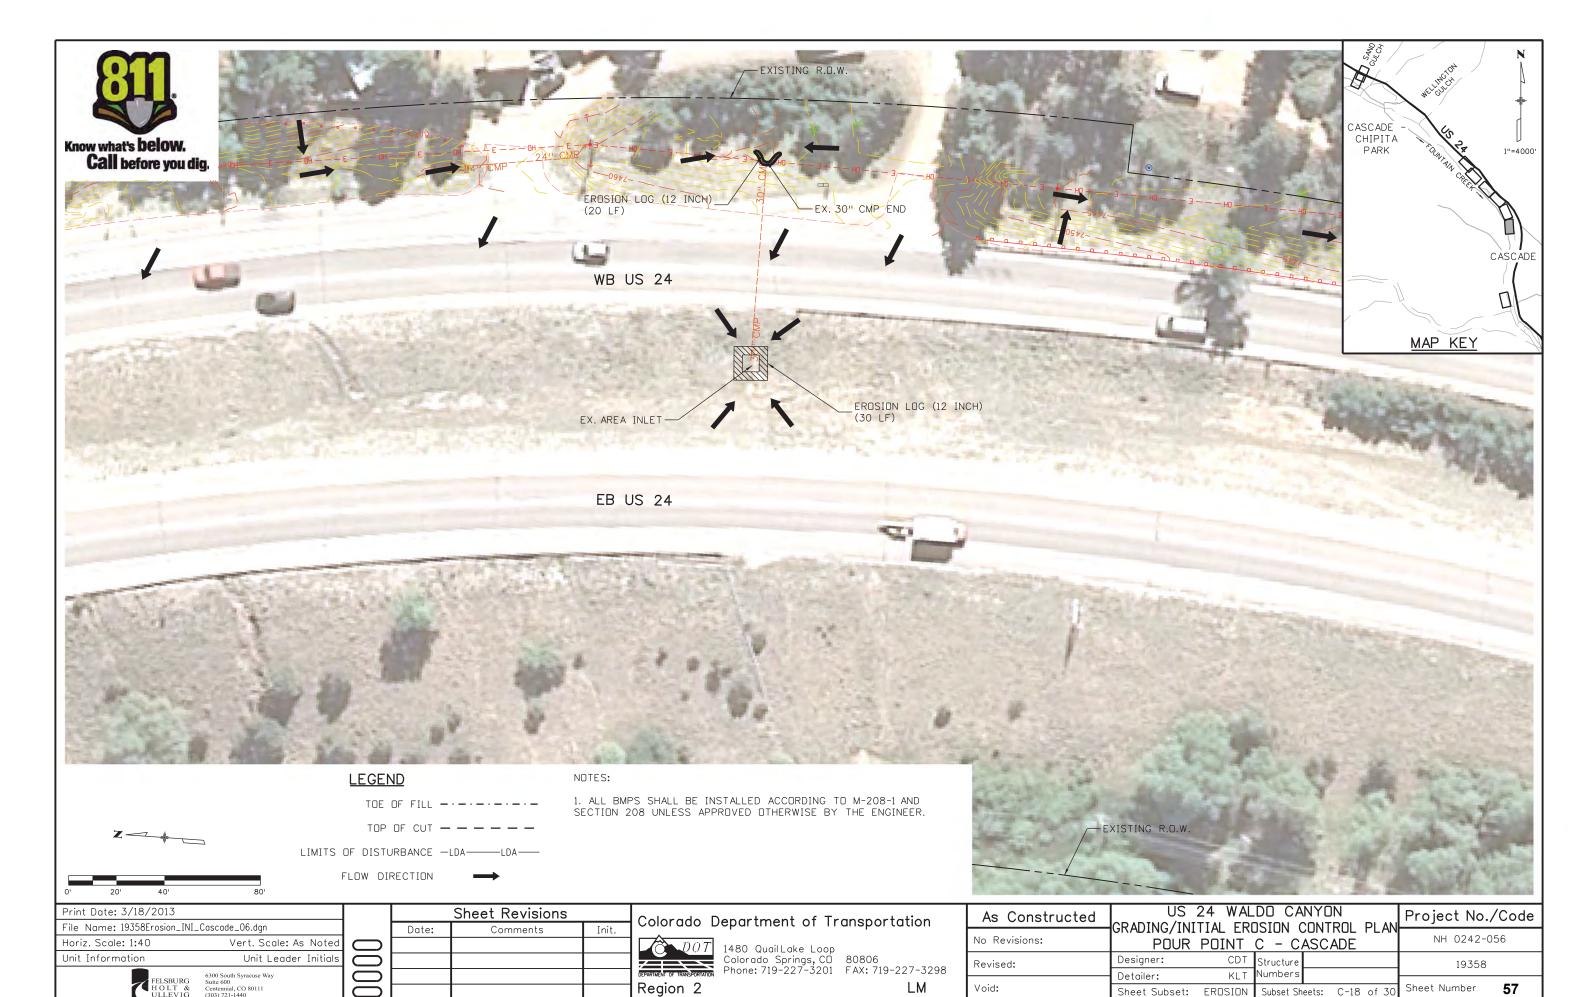


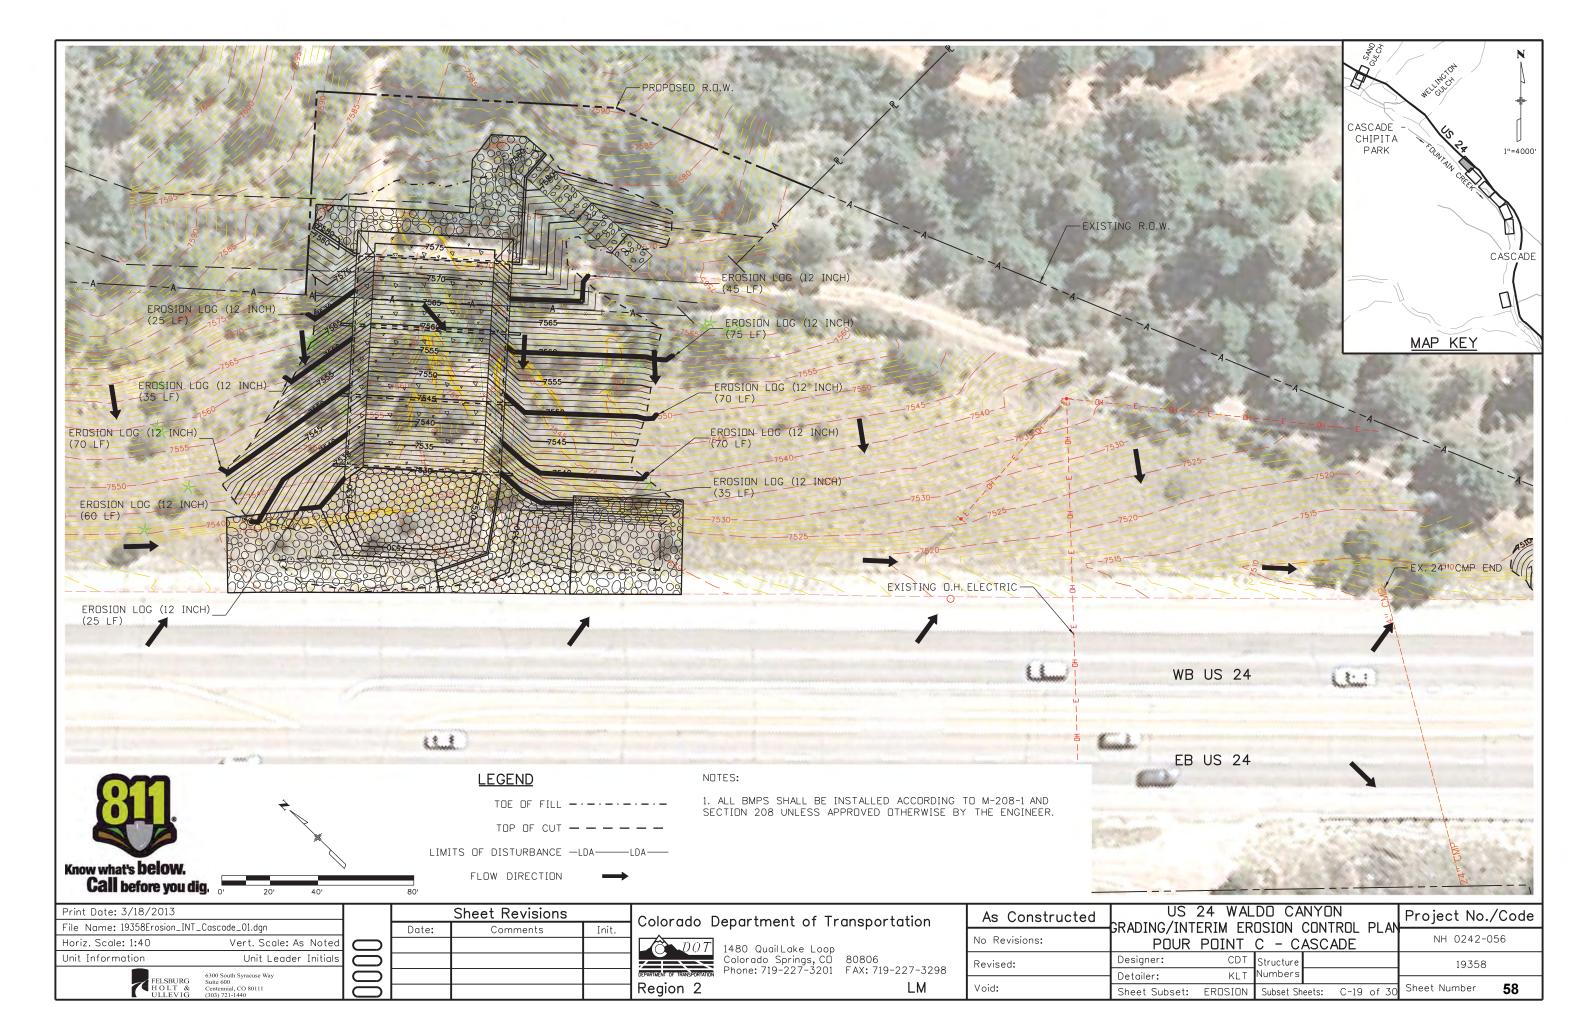


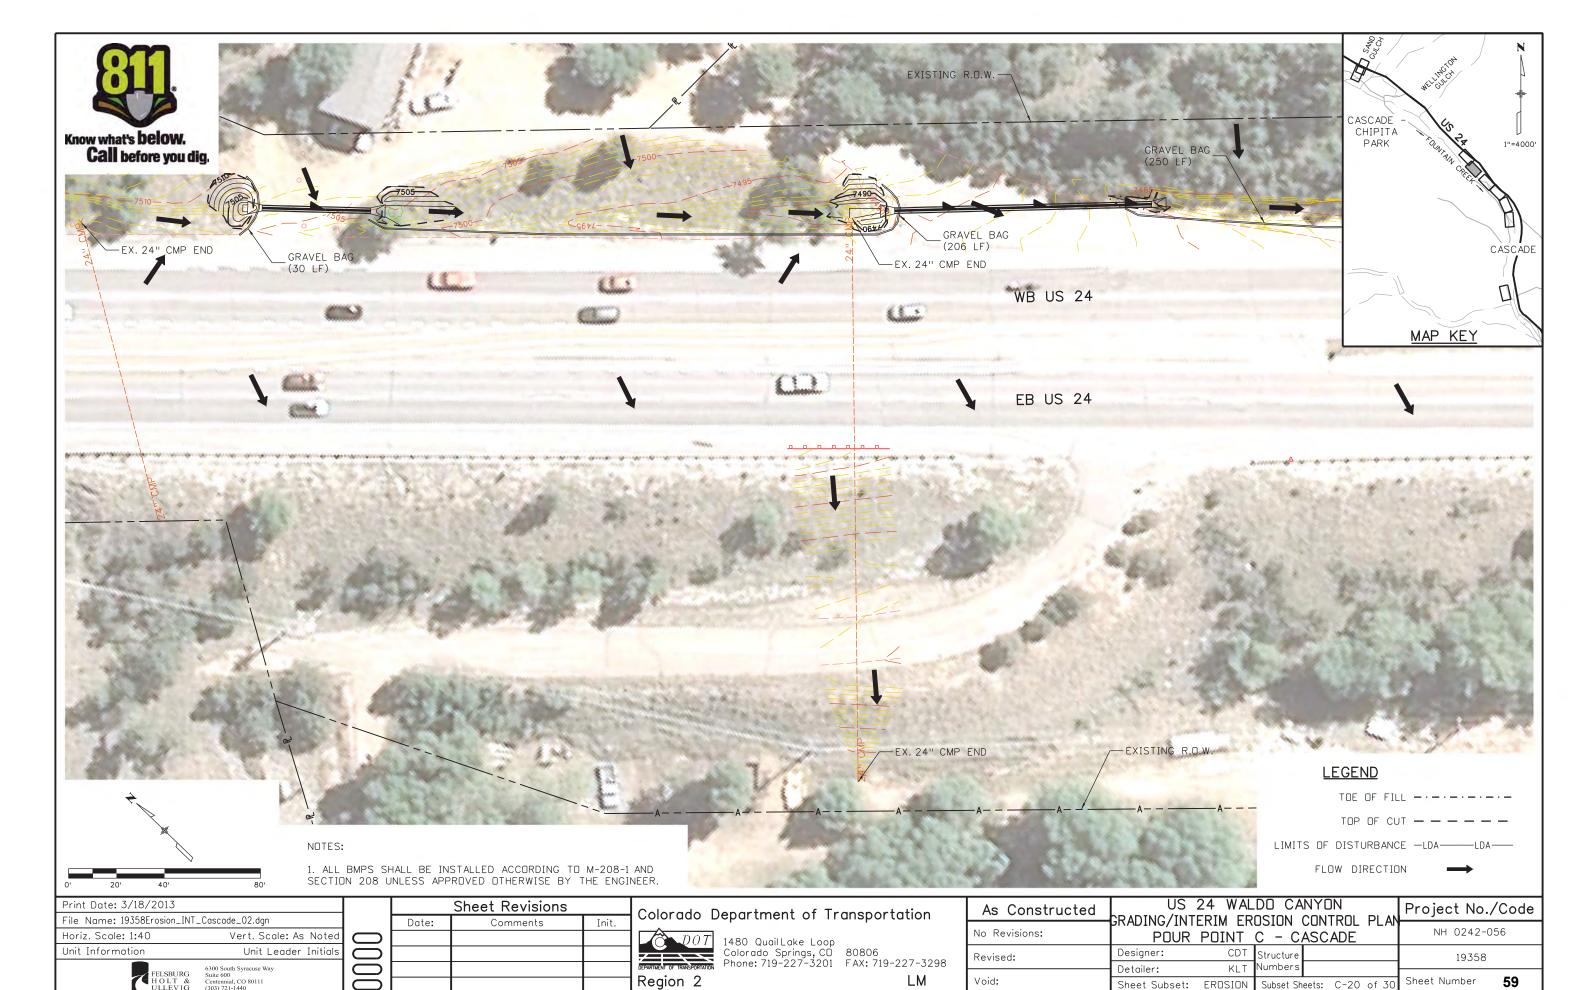


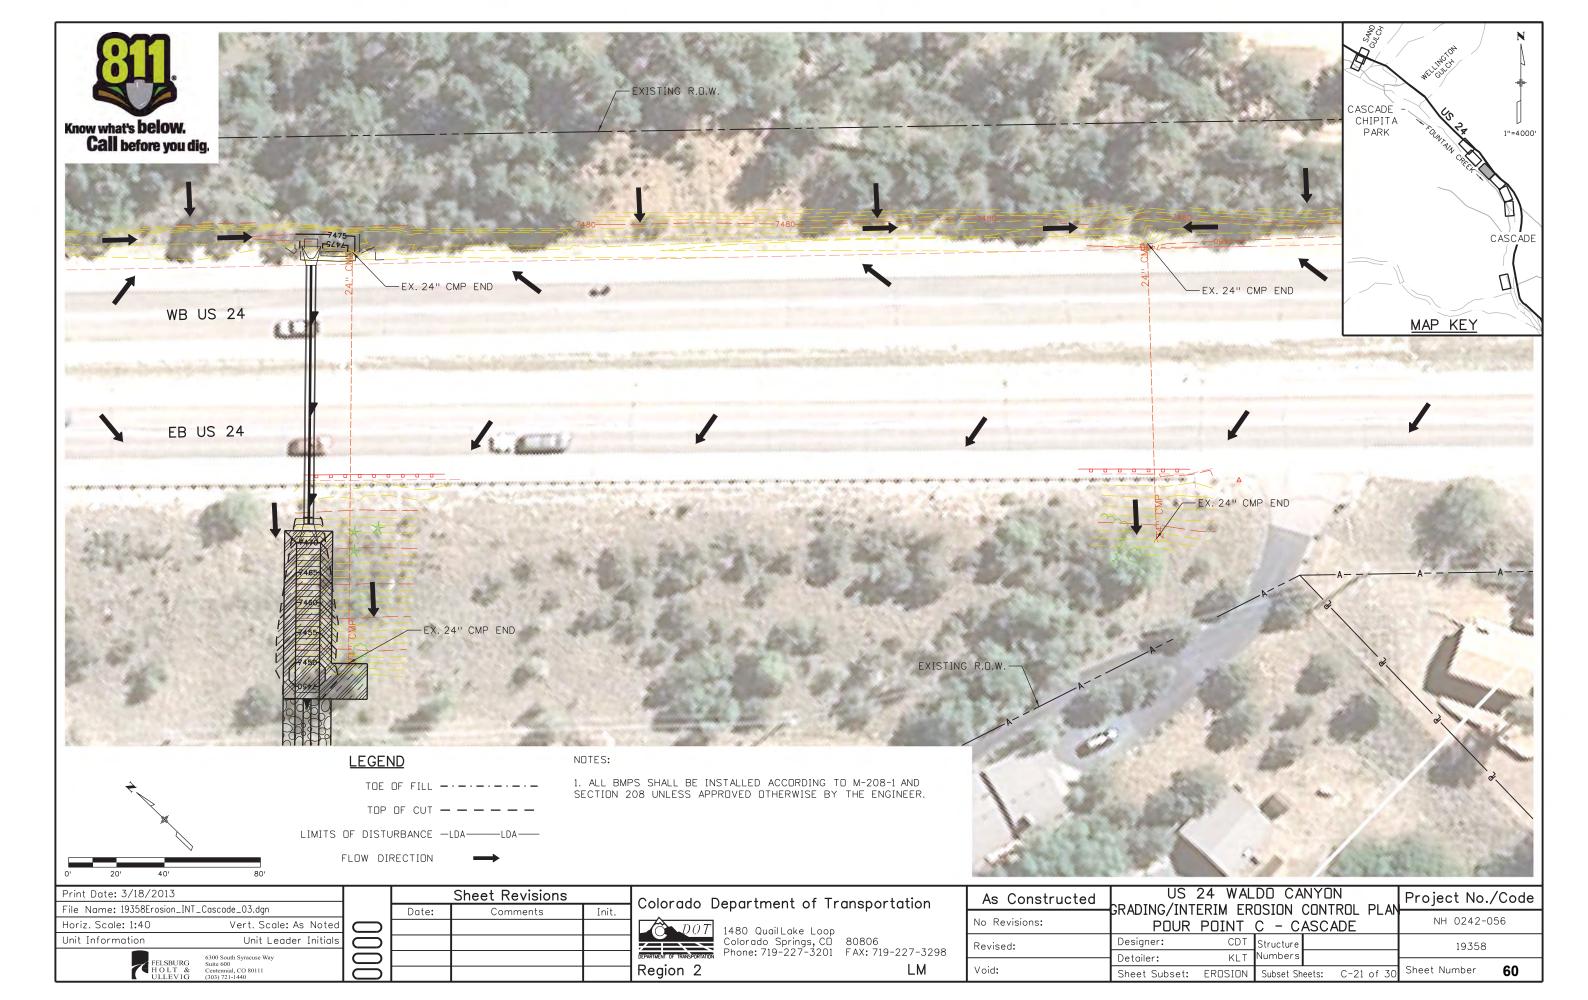


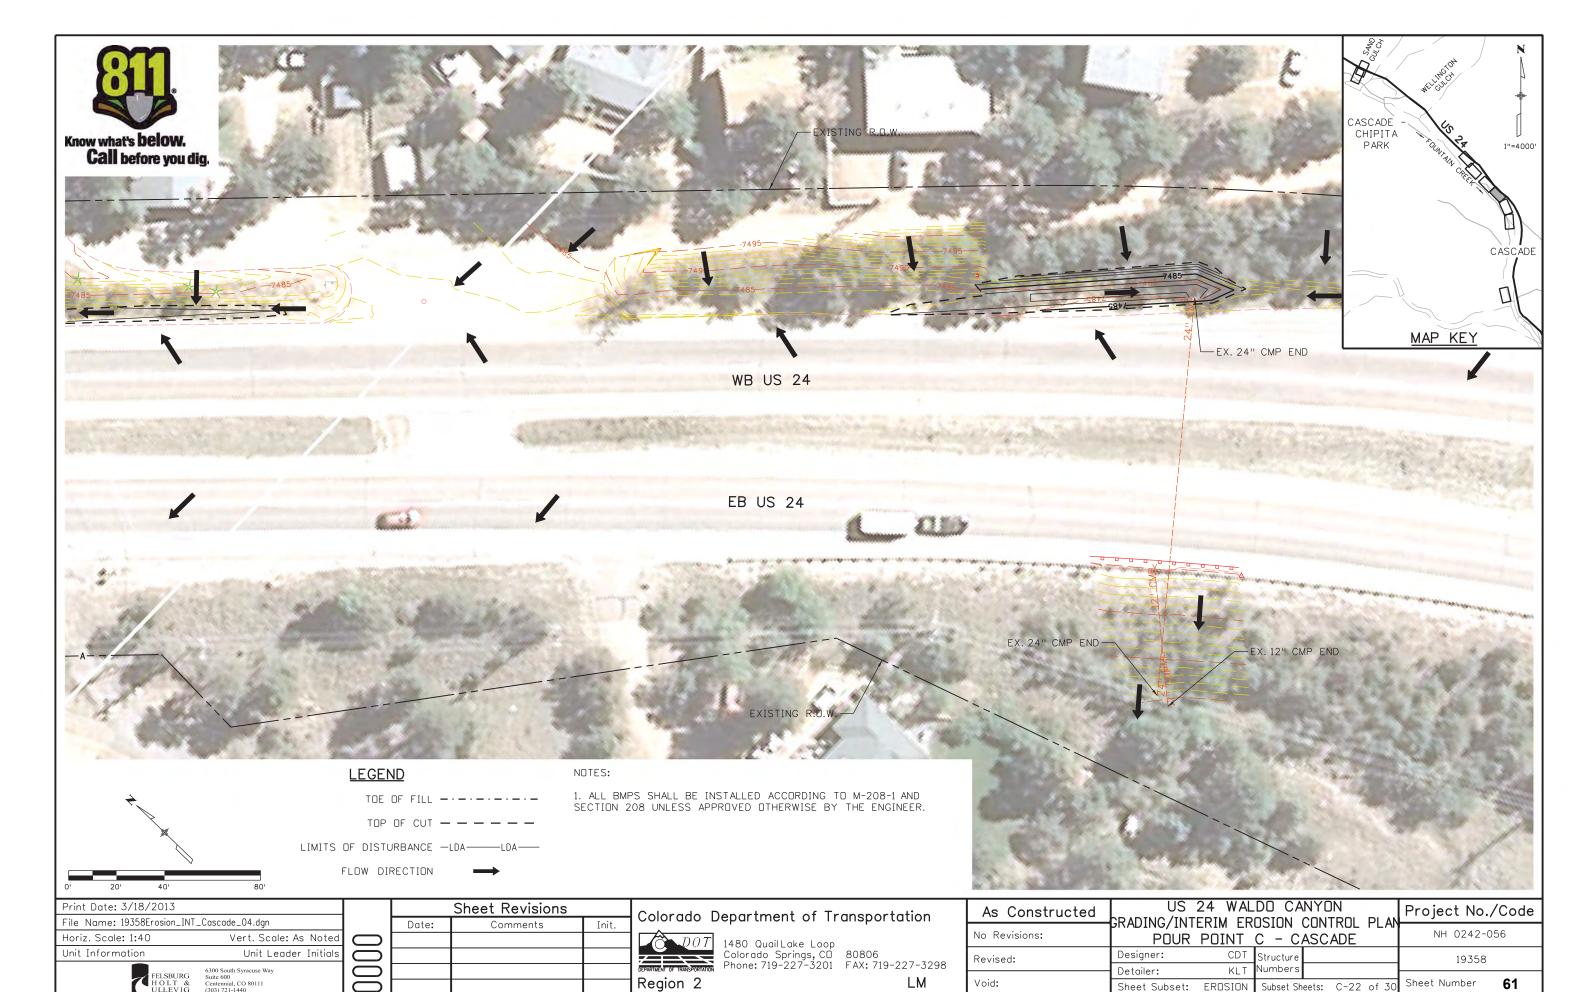


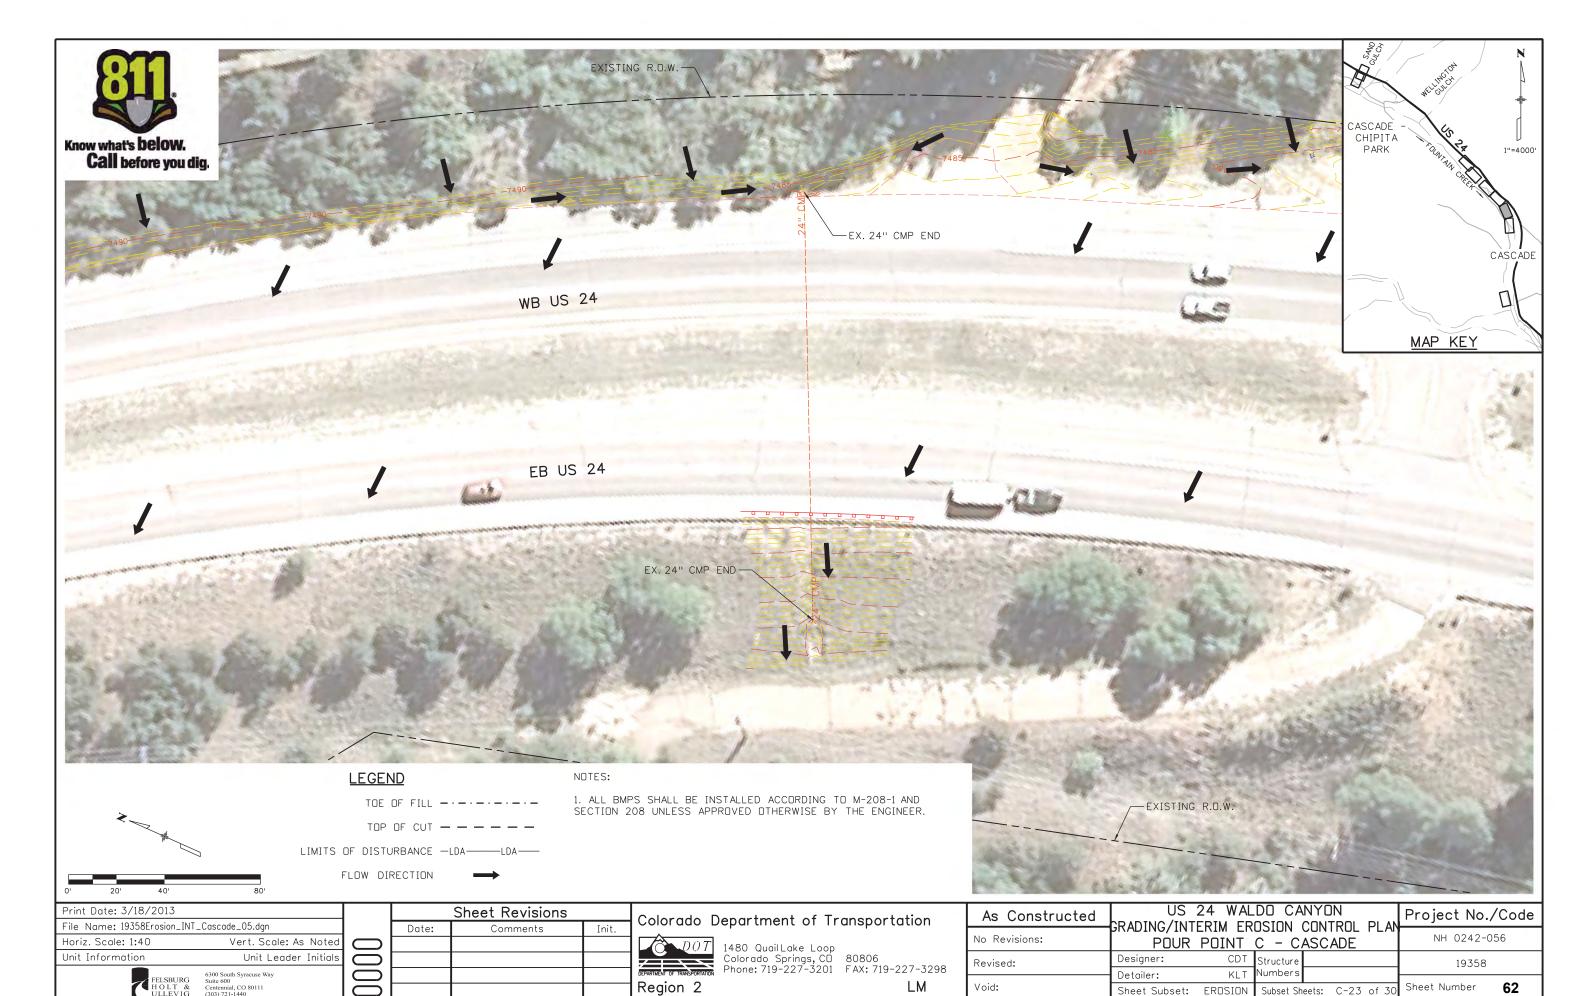


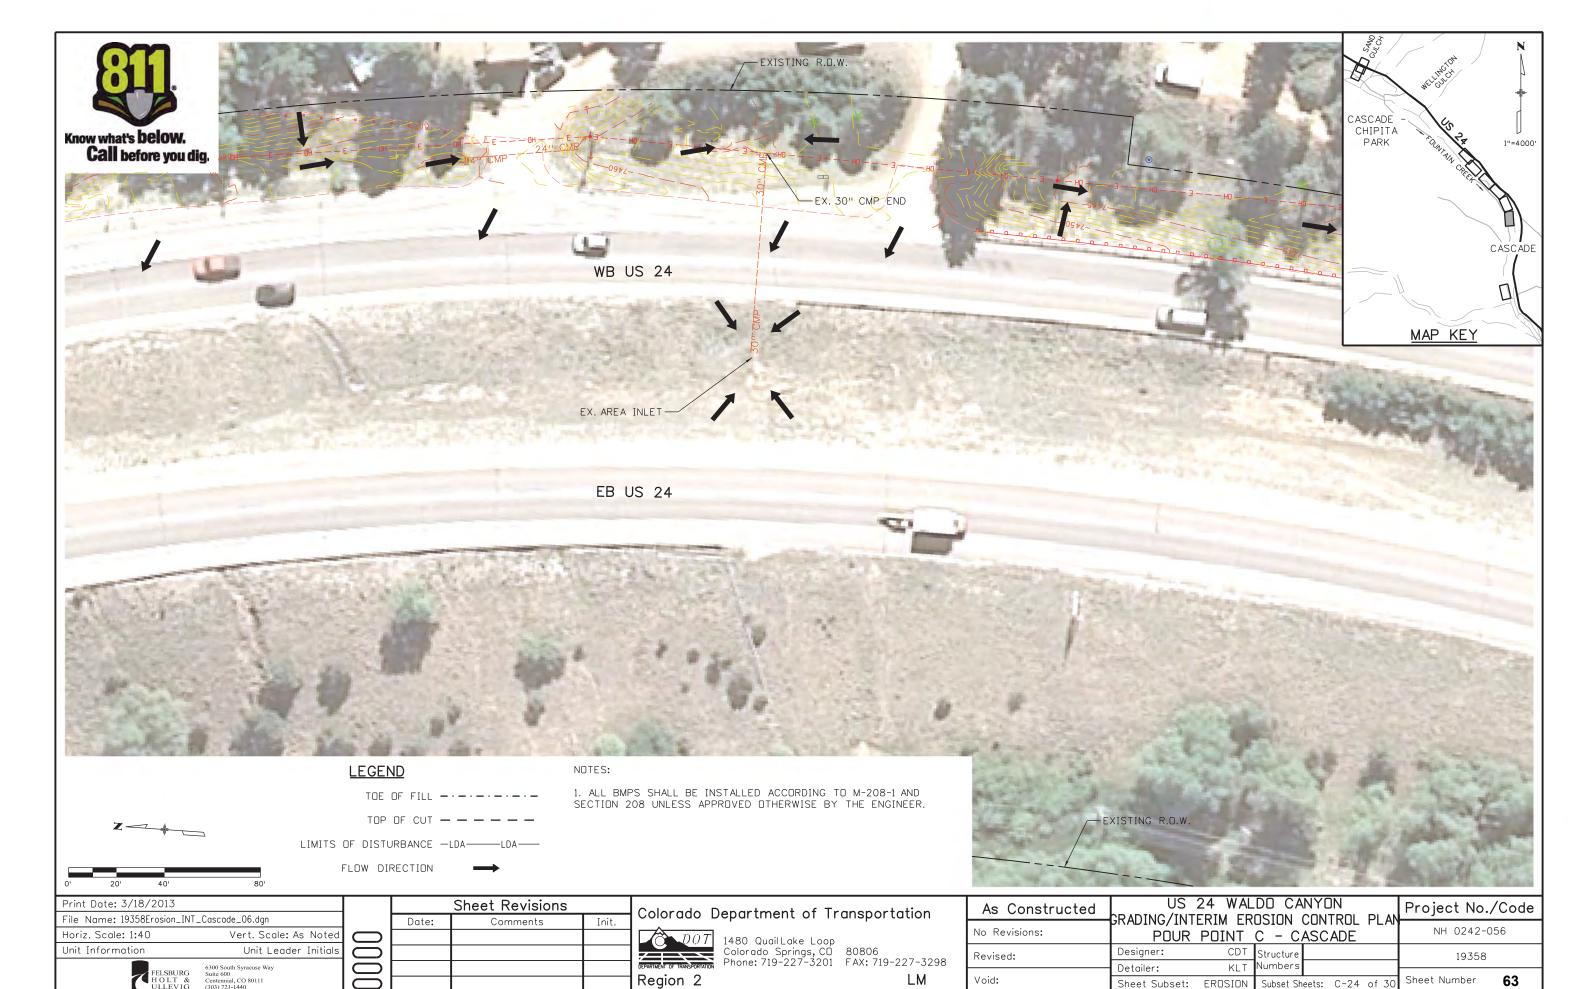


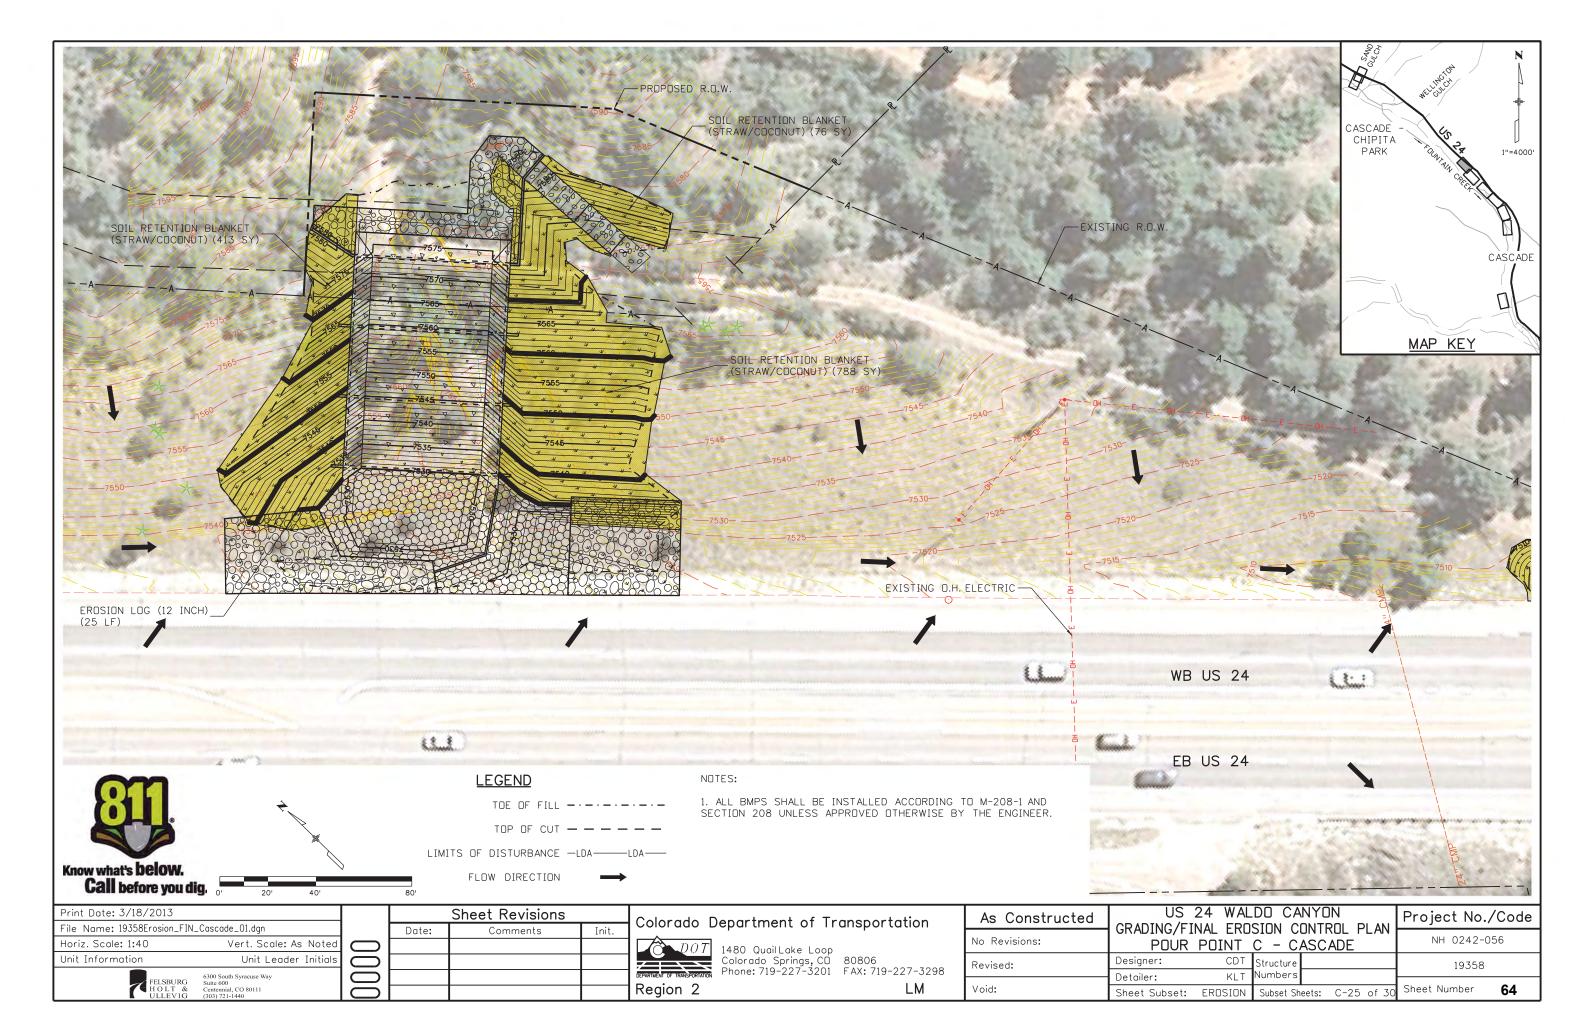


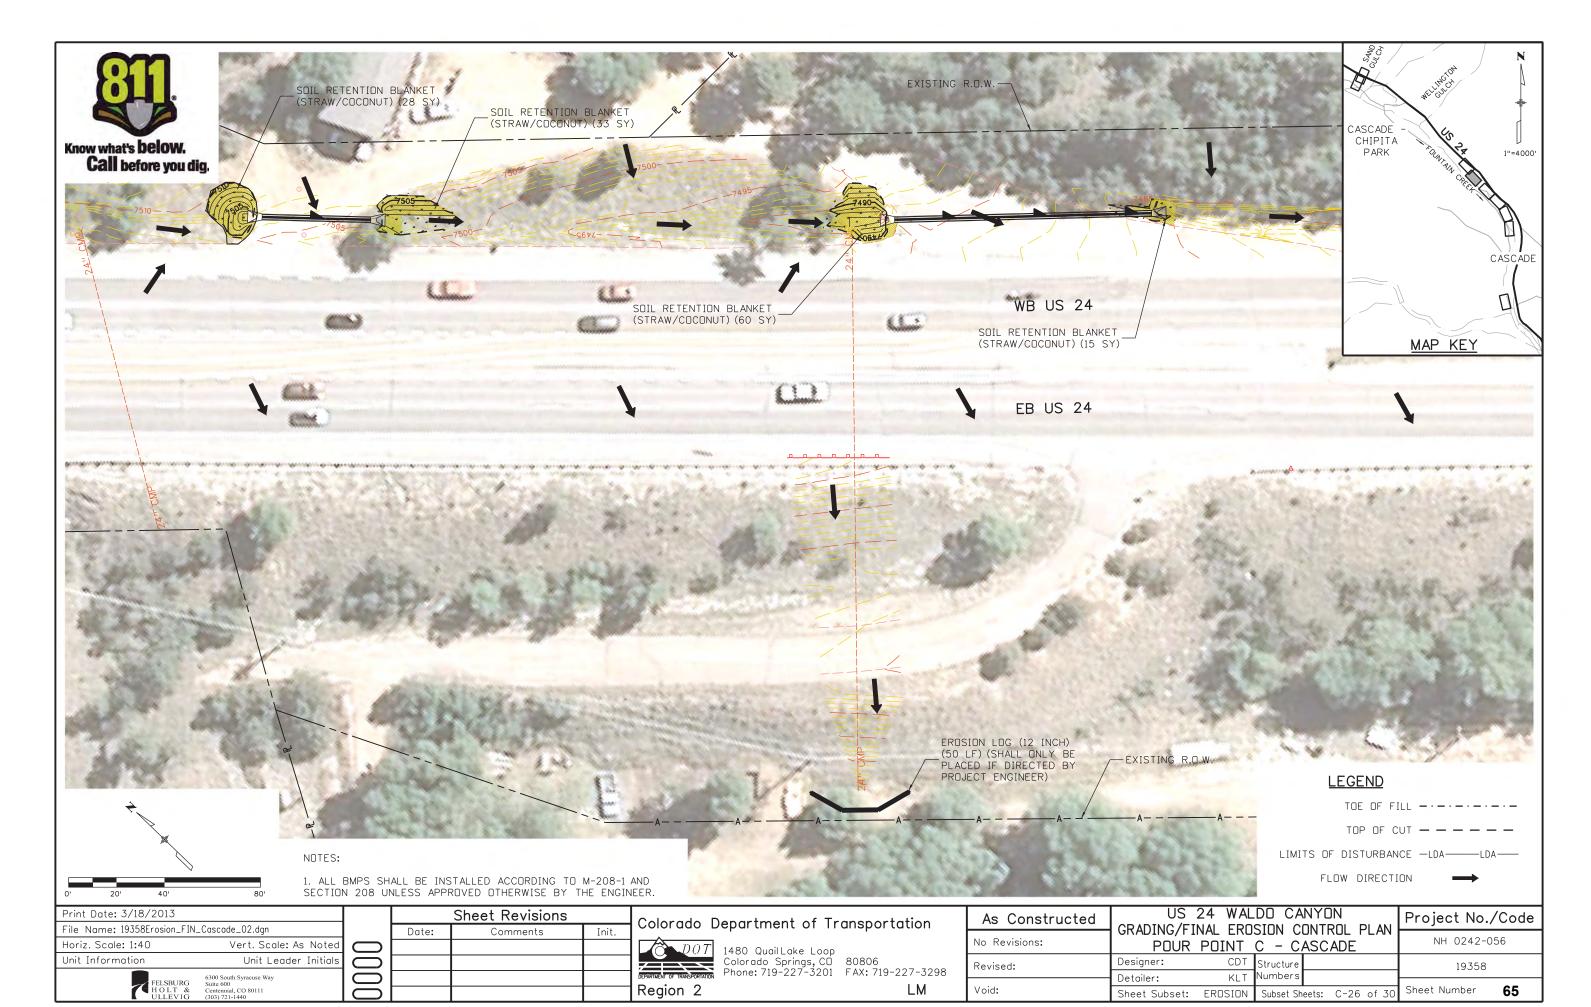

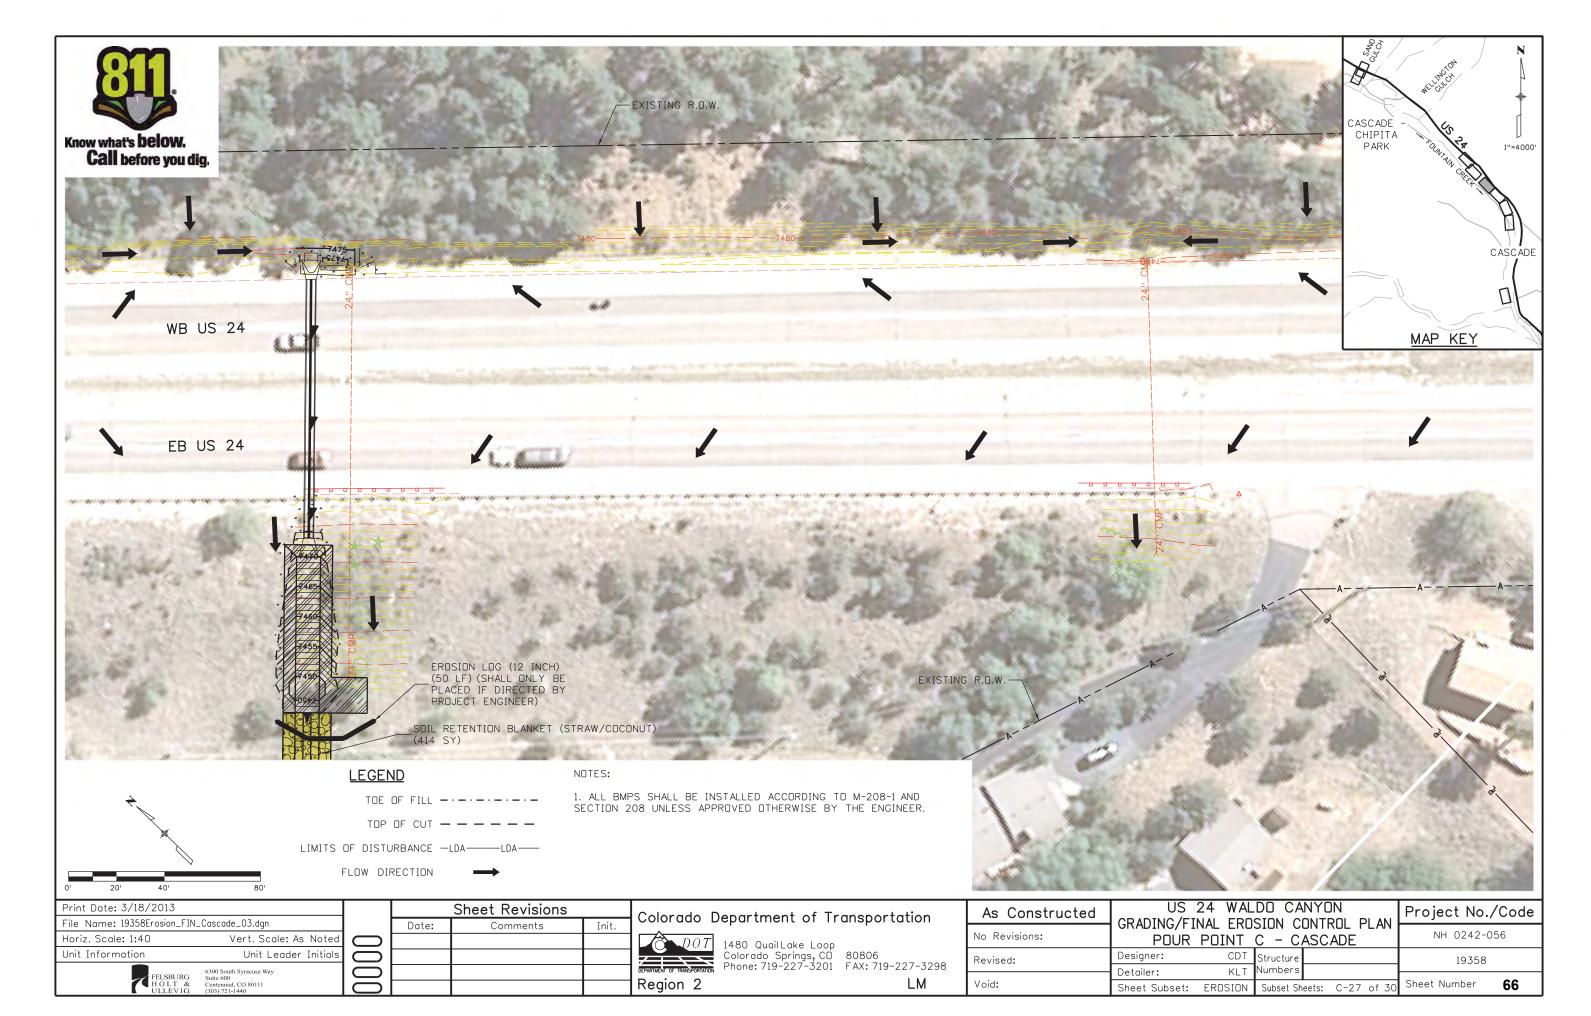

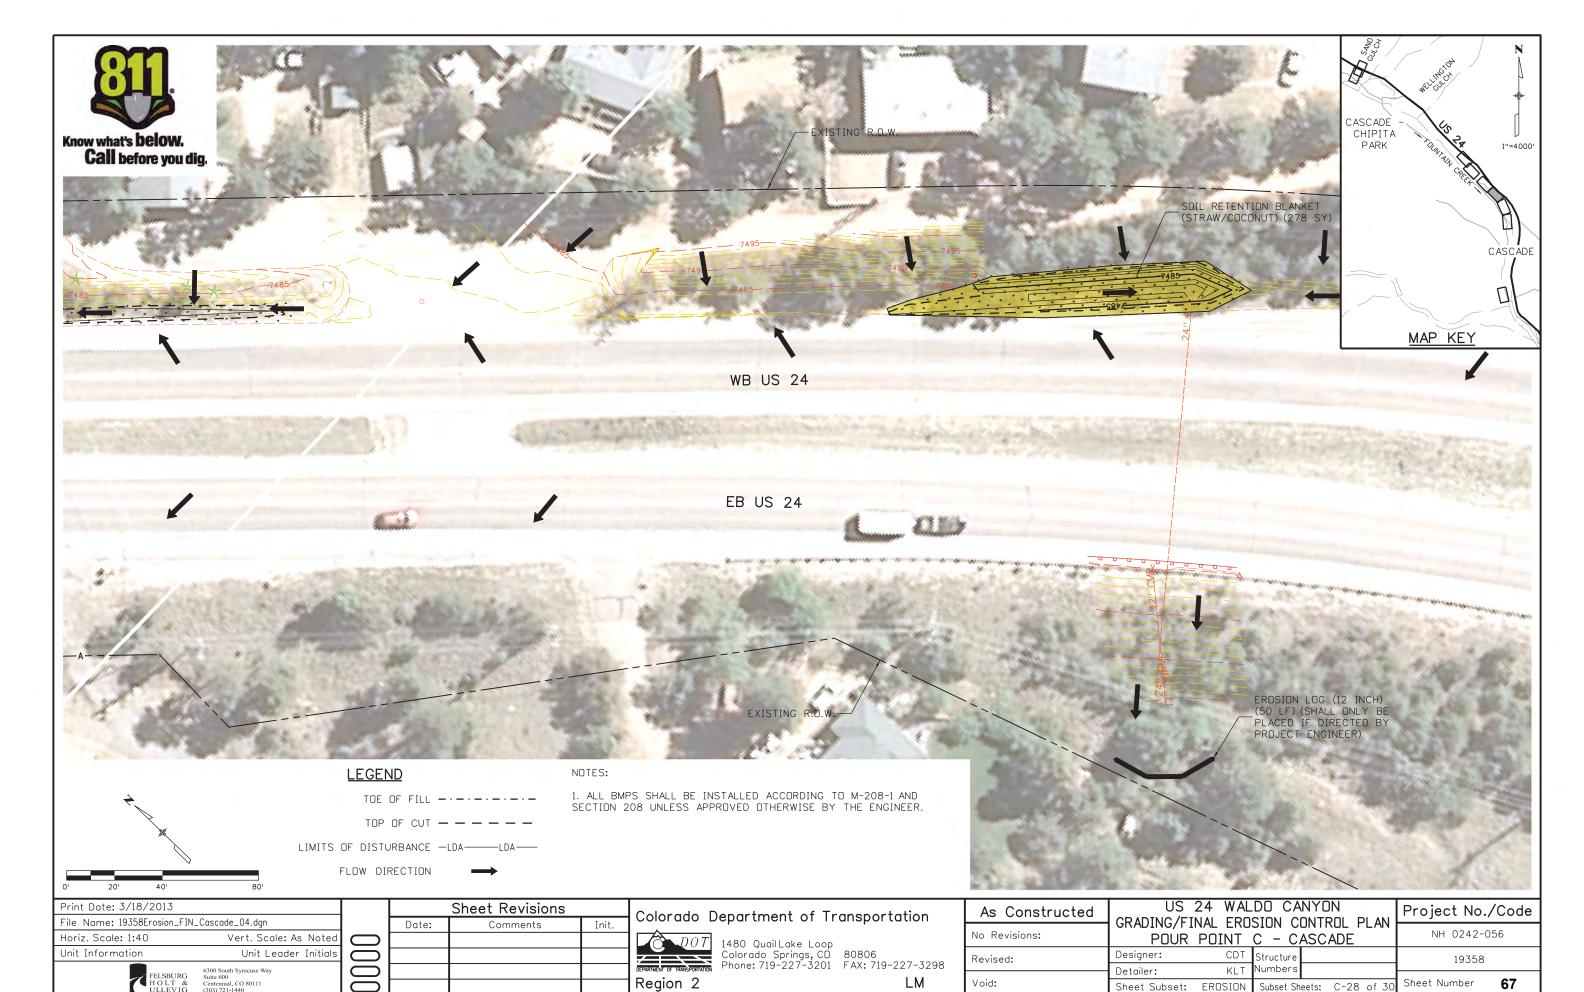

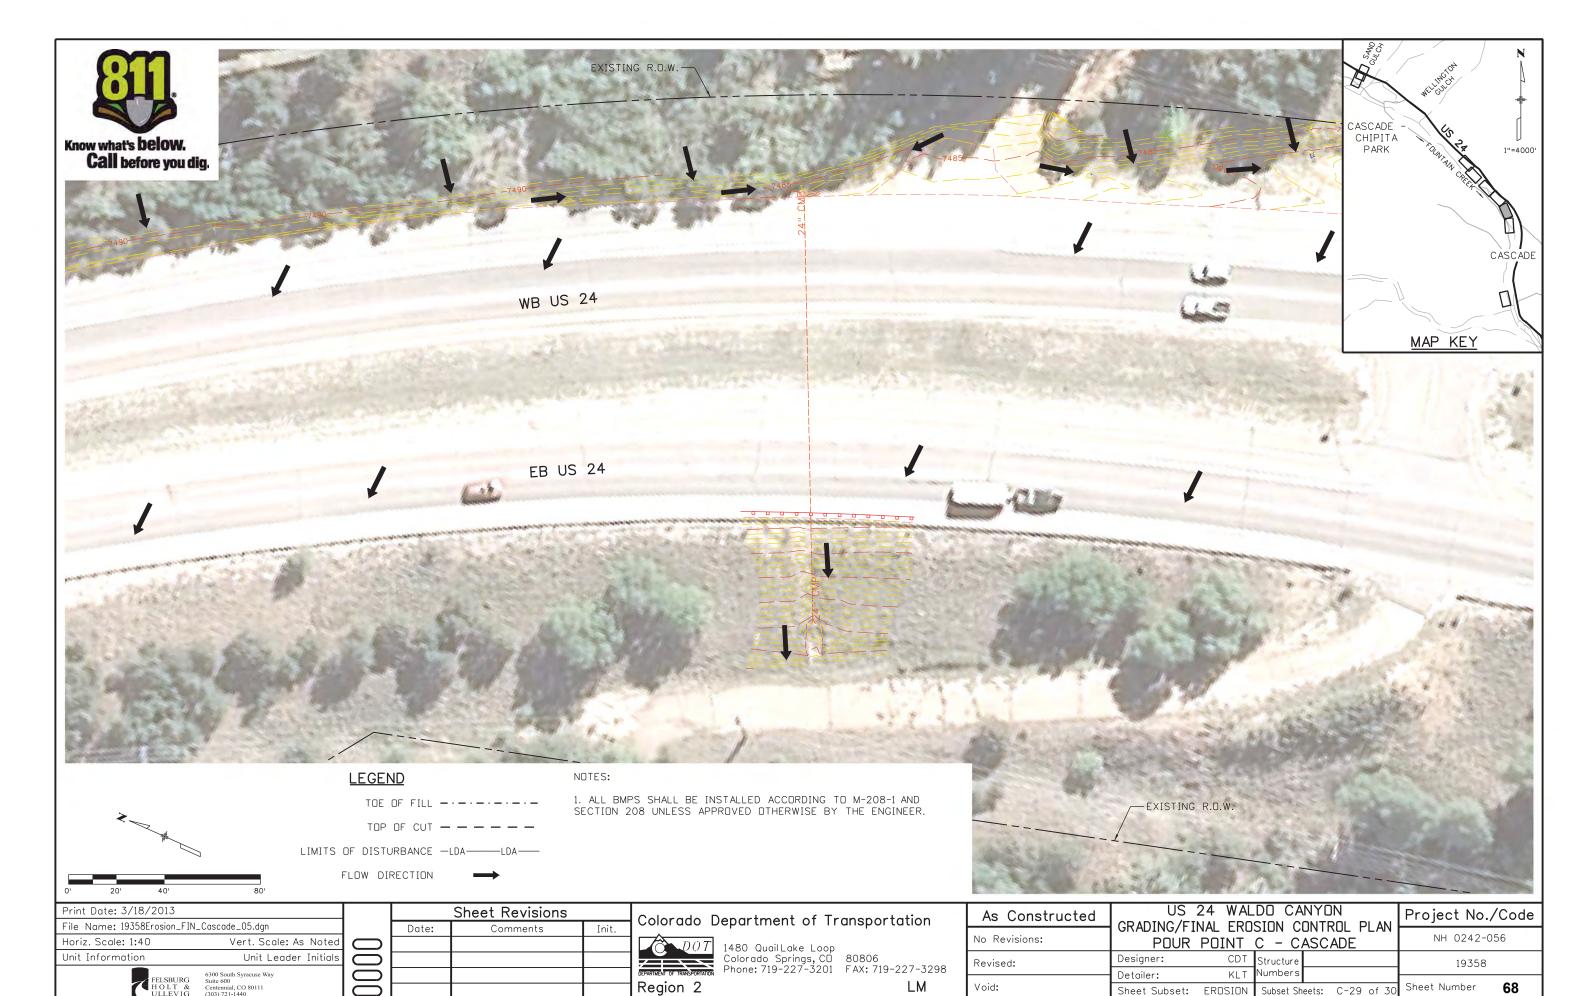

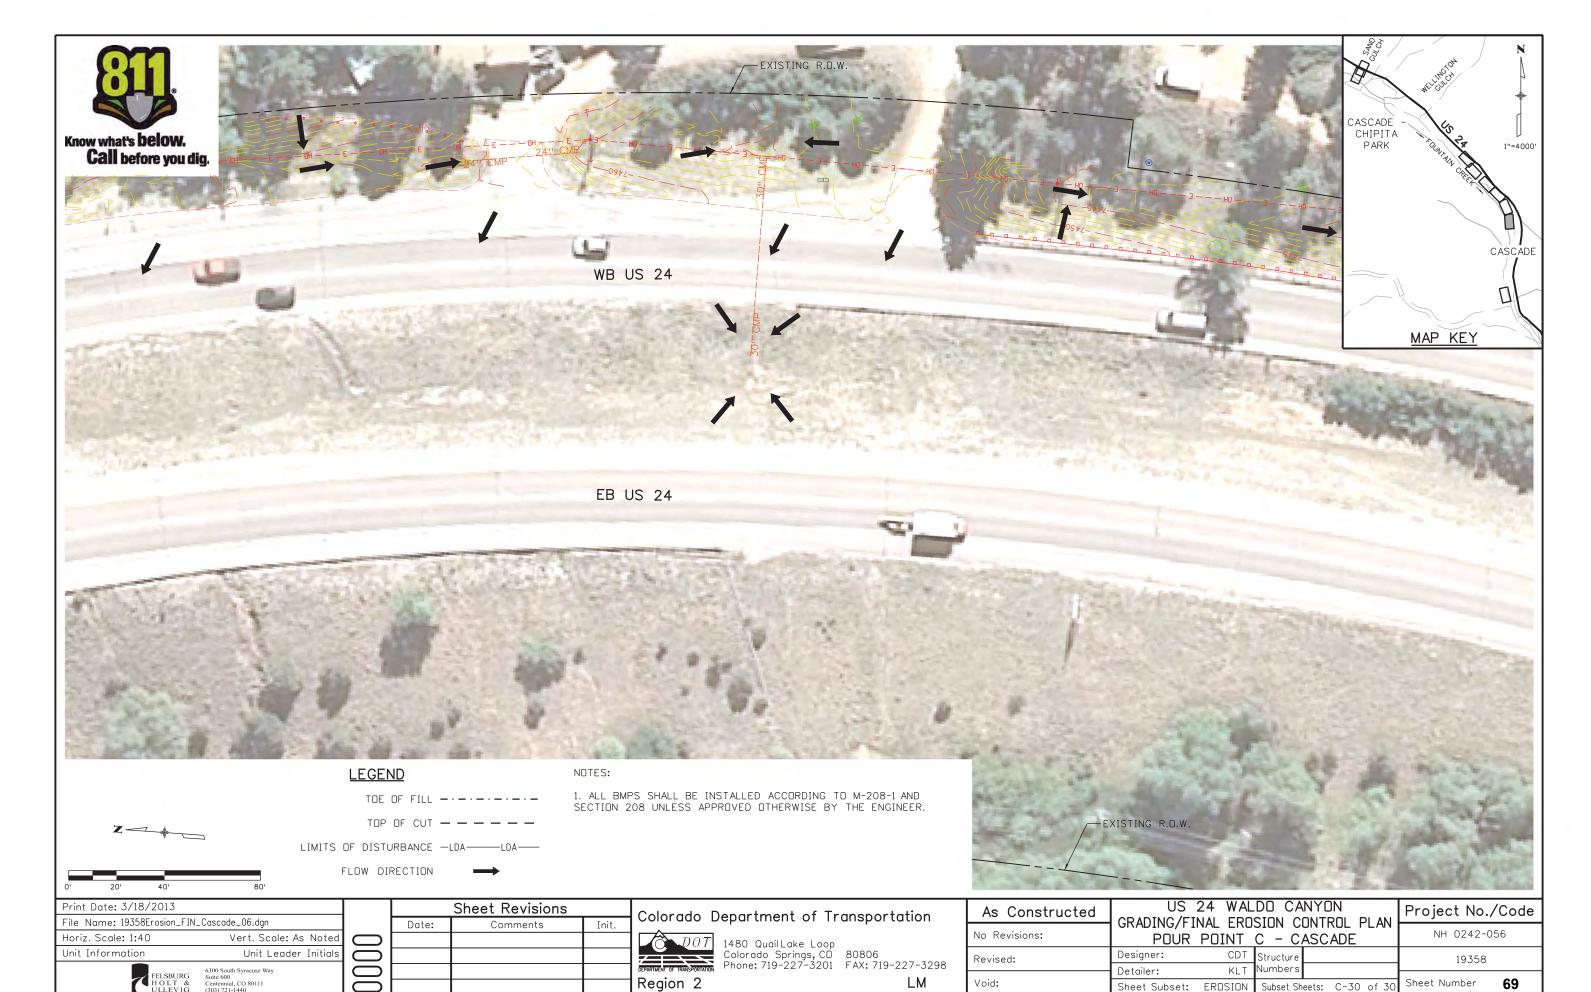

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POUR POINT H TABULATION

CONTRACT ITEM NO.	CONTRACT ITEM	UNIT	QUANTITY
201-00001	CLEARING AND GRUBBING	LS	1
202-00035	REMOVAL OF PIPE	LF	4
202-04002	CLEAN CULVERT	EA	1
203-01622	SWEEPING (WITH PICKUP BROOM)	HR	40
208-00034	GRAVEL BAG	LF	150
208-00045	CONCRETE WASHOUT STRUCTURE	EA	1
208-00070	VEHICLE TRACKING PAD	EA	1
208-00103	REMOVAL AND DISPOSAL OF SEDIMENT (LABOR)	HR	80
208-00105	REMOVAL AND DISPOSAL OF SEDIMENT (EQUIPMENT)	HR	40
208-00205	EROSION CONTROL SUPERVISOR	DAY	30
210-02900	RELAY RIPRAP	CY	15
601-01000	CONCRETE CLASS B	CY	15
601-03050	CONCRETE CLASS D (WALL)	CY	13
602-00000	REINFORCING STEEL	LB	750


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Horiz. Scale: 1:1	Vert. Scale: As Noted				
Unit Information	Unit Leader Initials				
FELSBURG HOLT & HULLEVIG	6300 South Syracuse Way Suite 600 Centennial, CO 80111)00			

Colorado	Department of Transportation
DOT	1480 QuailLake Loop

Region 2


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O Quail Lake Loop rado Springs, CD ne: 719-227-3201	80806 FAX: 719-227-3298


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Revised:	Designer:		Structure			19358	
	Detailer:	KLT	Numbers				
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POINT DATA TABLE - POUR POINT H - GRADING

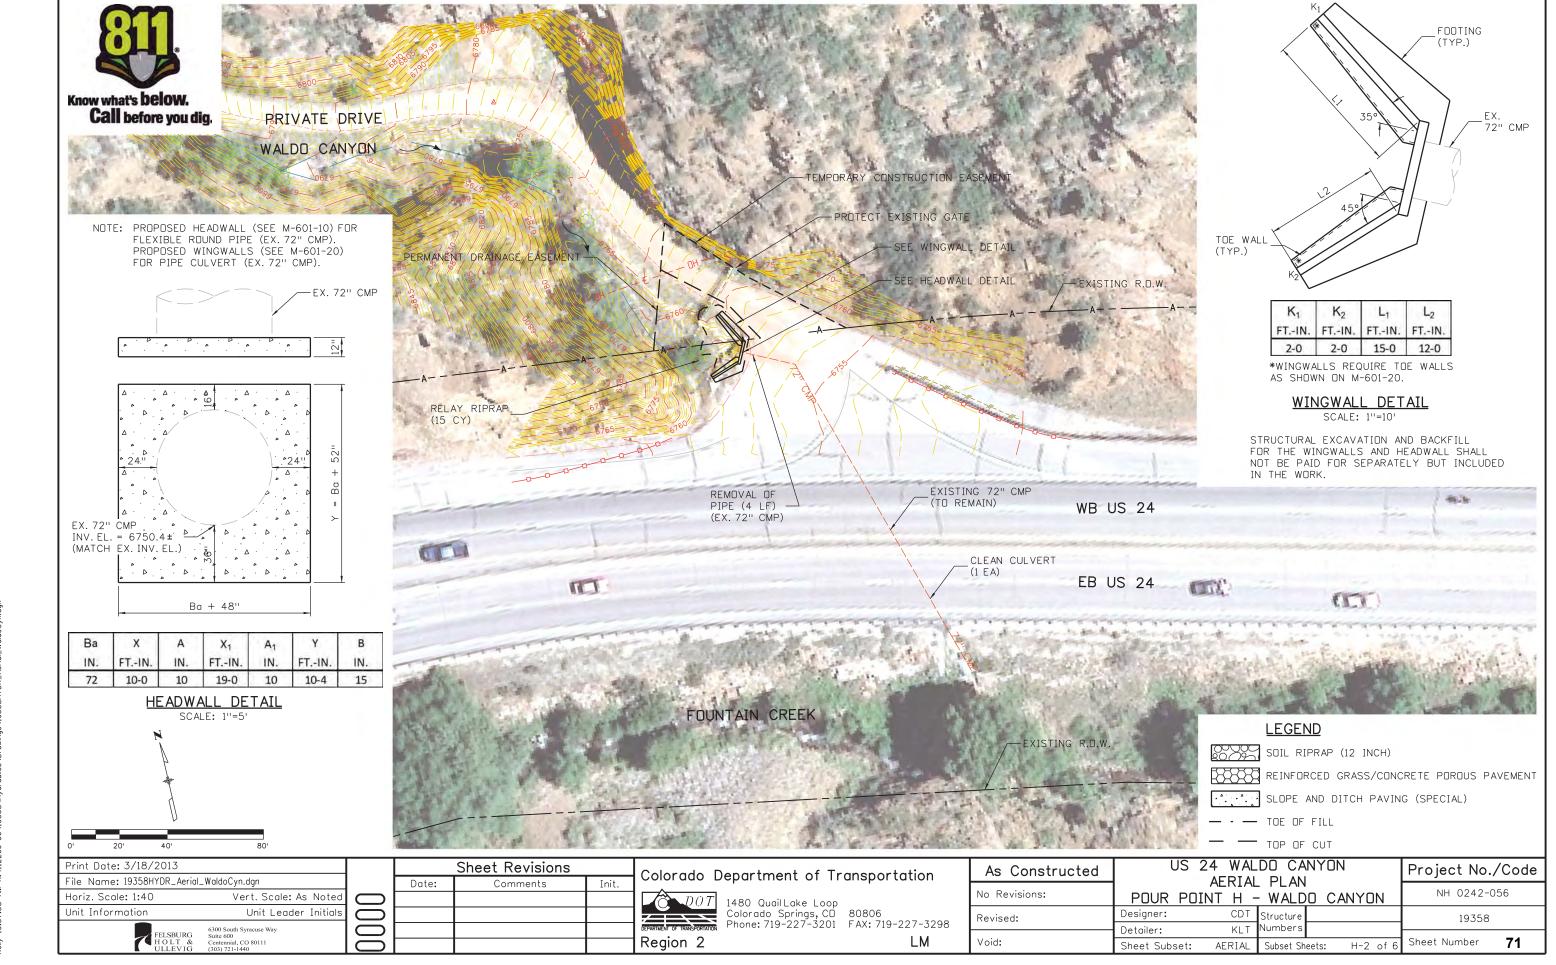POINT	NORTHING	EASTING	ELEVATION	DESCRIPTION
G1	381076.80	162767.89	6761.00	FINISHED GRADE
G2	381077.67	162770.42	6761.00	FINISHED GRADE
G3	381074.58	162777.68	6760.00	FINISHED GRADE
G4	381076.06	162775.87	6760.00	FINISHED GRADE
G5	381076.45	162773.00	6760.00	FINISHED GRADE
G6	381074.39	162767.04	6760.00	FINISHED GRADE
G7	381066.52	162768.74	6756.00	FINISHED GRADE
G8	381059.16	162764.20	6755.00	FINISHED GRADE
G9	381063.58	162766.35	6755.00	FINISHED GRADE
G10	381067.66	162778.20	6755.00	FINISHED GRADE
G11	381058.59	162767.26	6754.00	FINISHED GRADE
G12	381062.42	162769.12	6754.00	FINISHED GRADE
G13	381058.94	162777.44	6751.00	FINISHED GRADE
G14	381060.56	162782.13	6751.00	FINISHED GRADE
G15	381057.50	162776.74	6751.00	FINISHED GRADE
G16	381052.81	162778.36	6751.00	FINISHED GRADE
G17	381056.32	162770.80	6754.00	FINISHED GRADE
G18	381051.53	162768.22	6756.00	FINISHED GRADE
G19	381049.55	162768.90	6756.00	FINISHED GRADE





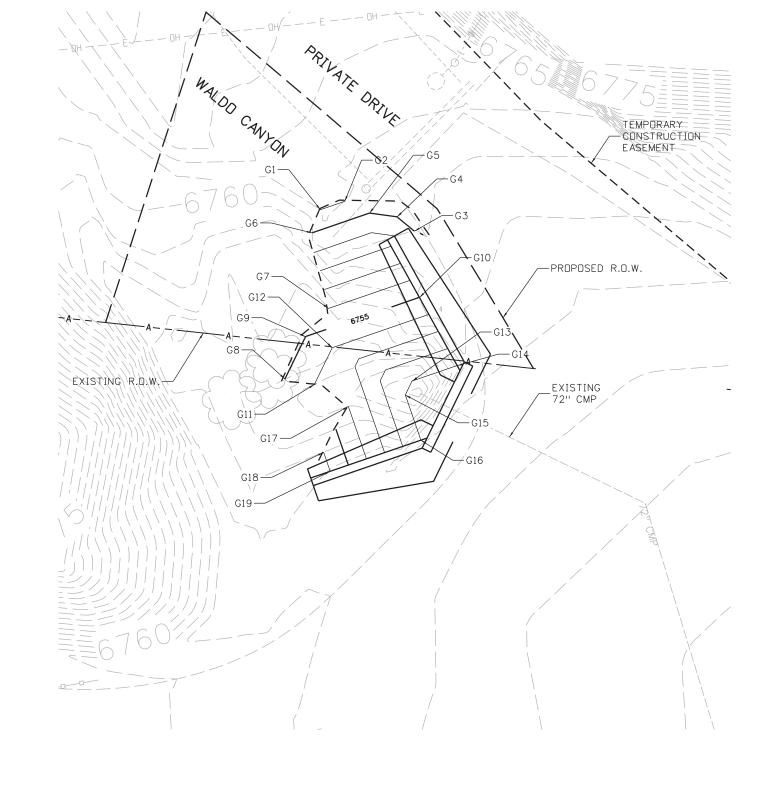
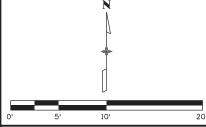
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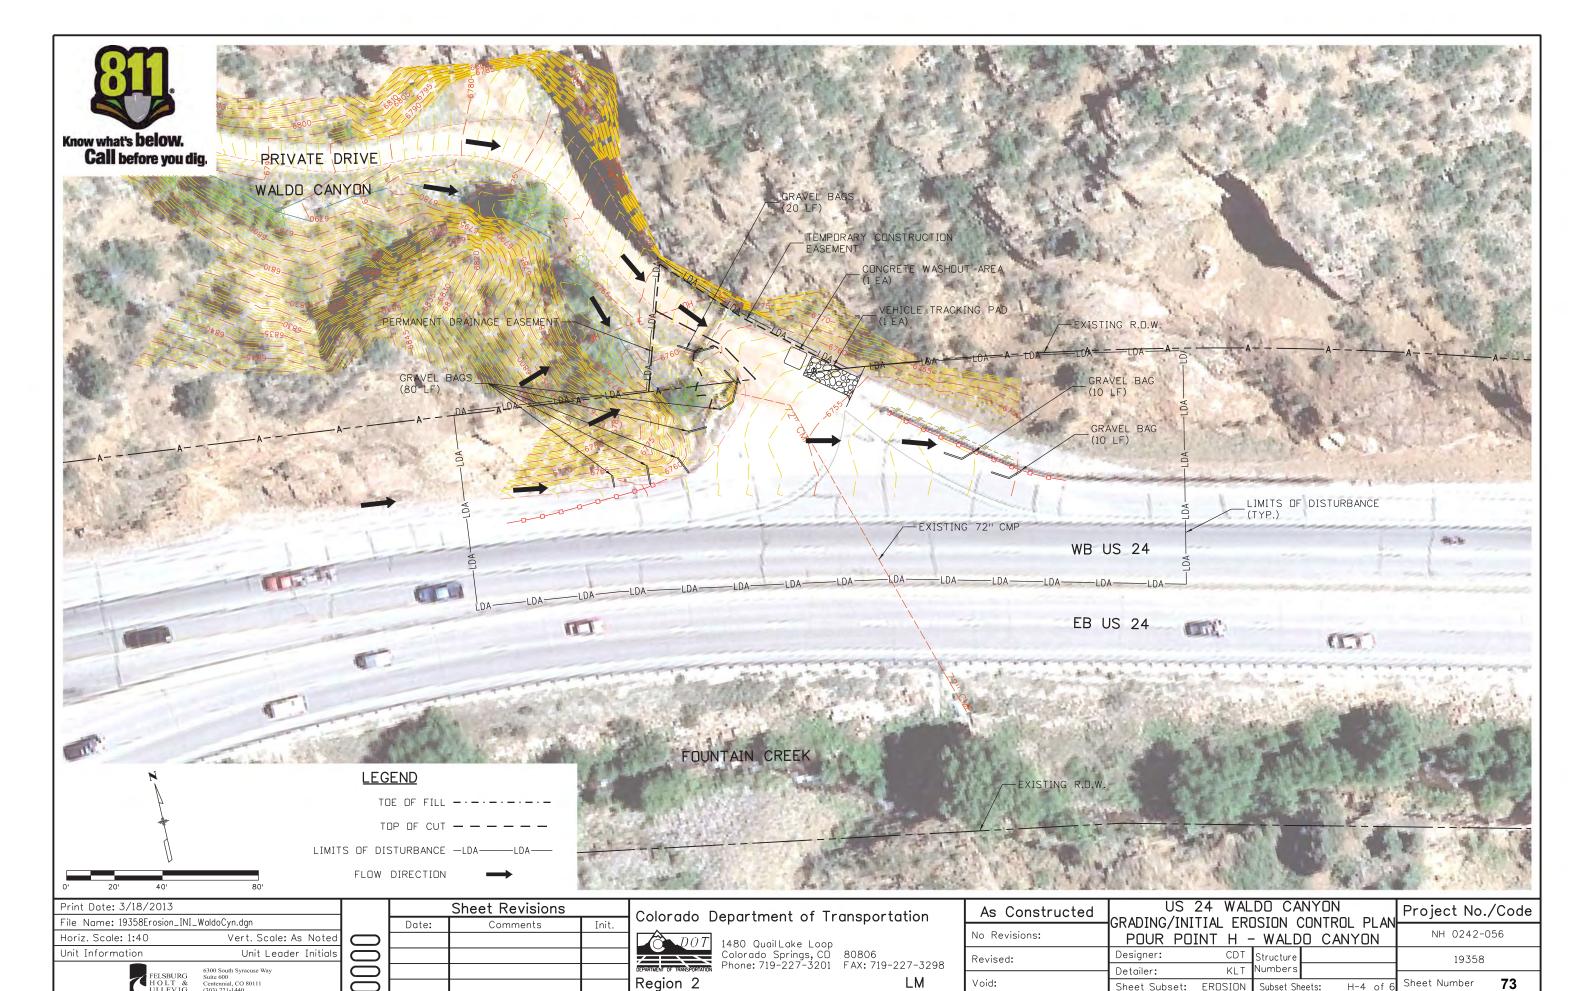
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Unit Information Unit Leader Initials	
FELSBURG 6300 South Syracuse Way Suite 600	
HOLT & Centennial, CO 80111 ULLEVIG (303) 721-1440	


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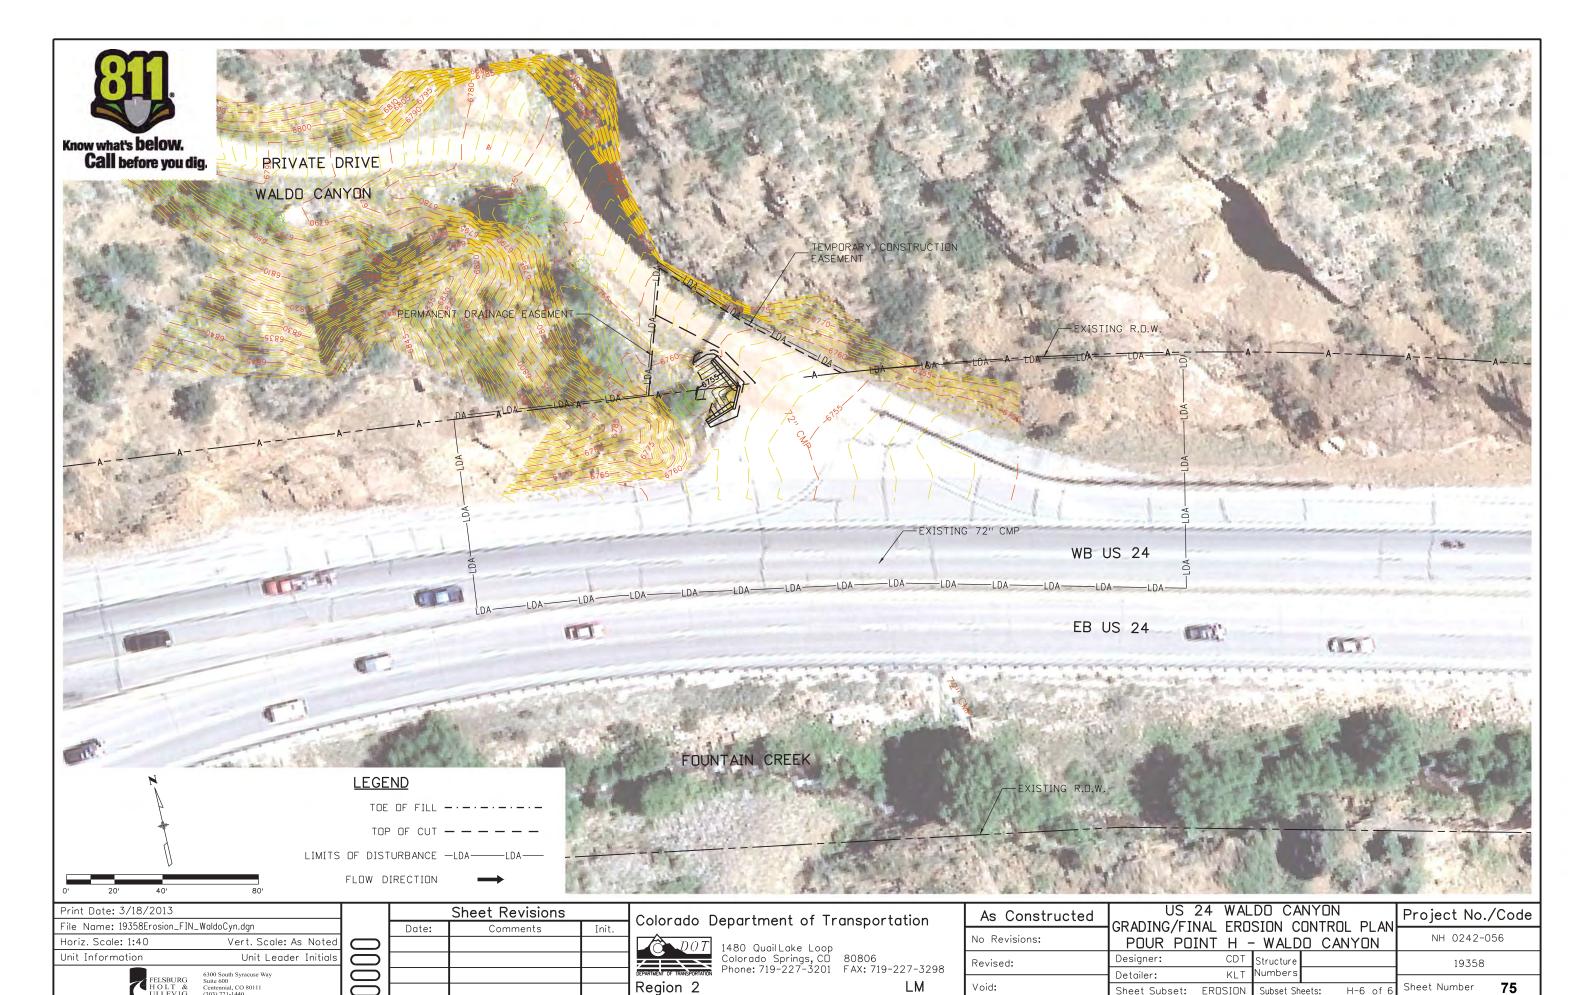
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	1480 Quail Lake Loop Colorado Springs, CD Phone: 719-227-3201	

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Revised:		Structure Numbers	19358
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POUR POINT J - TABULATION

CONTRACT ITEM NO.	CONTRACTITEM	UNIT	QUANTIT
201-00001	CLEARING AND GRUBBING	LS	1
202-00027	REMOVAL OF RIPRAP	SY	86
203-00010	UNCLASSIFIED EXCAVATION (COMPLETE IN PLACE)	CY	12916
203-00060	EMBANKMENT MATERIAL (COMPLETE IN PLACEO	CY	450
203-00598	ROCK SCALING	HR	60
203-01622	SWEEPING (WITH PICKUP BROOM)	HR	40
206-00000	STRUCTURE EXCAVATION	CY	450
206-00510	FILTER MATERIAL (CLASS A)	CY	200
207-00205	TOPSOIL	CY	202
208-00002	EROSION LOG (12 INCH)	LF	455
208-00034	GRAVEL BAG	LF	490
208-00041	ROCK CHECK DAM	FA	1
208-00045	CONCRETE WASHOUT STRUCTURE	EA	2
208-00070	VEHICLE TRACKING PAD	EA	2
208-00103	REMOVAL AND DISPOSAL OF SEDIMENT (LABOR)	HR	80
208-00105	REMOVAL AND DISPOSAL OF SEDIMENT (EQUIPMENT)	HR	40
208-00205	EROSION CONTROL SUPERVISOR	DAY	30
208-00301	TEMPORARY DIVERSION	LF	300
210-00475	RESET CLOSED CIRCUIT TELEVISION POLE	EA	1
210-00810	RESET GROUND SIGN	EA	1
212-00006	SEEDING (NATIVE)	AC	0.25
212-00032	SOIL CONDITIONING	AC	0.25
213-00002	MULCHING (WEED FREE)	AC	0.25
216-00041	SOIL RETENTION BLANKET (STRAW/COCONUT)	SY	563
304-06000	AGGREGATE BASE COURSE (CLASS 6)	CY	79
420-00102	GEOTEXTILE (EROSION CONTROL) (CLASS 1)	SY	540
504-06315	GROUND NAIL (15 FOOT)	EA	60
506-00010	RIPRAP (SPECIAL)	CY	35
506-00036	GROUTED RIPRAP (36 INCH) (SPECIAL)	CY	275
506-00218	RIPRAP (18 INCH)	CY	275
506-00412	SOIL RIPRAP (12 INCH)	CY	81
506-01020	GEOGRID REINFORCEMENT	SY	856
607-53172	FENCE CHAIN LINK (72 INCH)	LF	174
607-55100	WIRE MESH	SF	52330
609-21020	CURB AND GUTTER TYPE 2 (SECTION II-B)	LF	390
641-10000	SHOTCRETE	SY	139

INDEX		INDEX		222 222	
BOOK PAGE SHEET		SHEET	ITEM	PROJECT TOTALS	
			*EMBANKMENT MATERIAL (CIP) (FROM CROSS-SECTIONS) (FOR INFO ONLY) ACCESS ROAD STA. 0+00.00 TO STA. 04+46.03	CU. YDS.	
			SUBTOTAL	226	
			TOTAL	226	
			*UNCLASSIFIED EXCAVATION (FROM CROSS-SECTIONS) ACCESS ROAD STA. 0+00.00 TO STA. 04+46.03	CU. YDS.	
			SUBTOTAL	162	
			TOTAL FOR PAY QUANTITY	162	

COMPACTION (FOR INFORMATION ONLY) (MOISTURE & DENSITY CONTROL) EMBANKMENT (NET)	226
TOTAL	226
WETTING QUANTITIES (FOR INFORMATION ONLY) COMPACTION	M. GAL.
(226 x 0.040 M, GAL./yd) TOTAL	9
ACCESS ROAD QUANTITIES BALANCE (FOR INFORMATION ONLY)	CU. YDS;
EMBANKMENT (NET)	226
EMBANKMENT X FACTOR (1.15)	260
BALANCE TOTAL	260
UNCLASSIFIED EXCAVATION TO BE IMPORTED BY THE CONTRACTOR BALANCE TOTAL	162 98 260

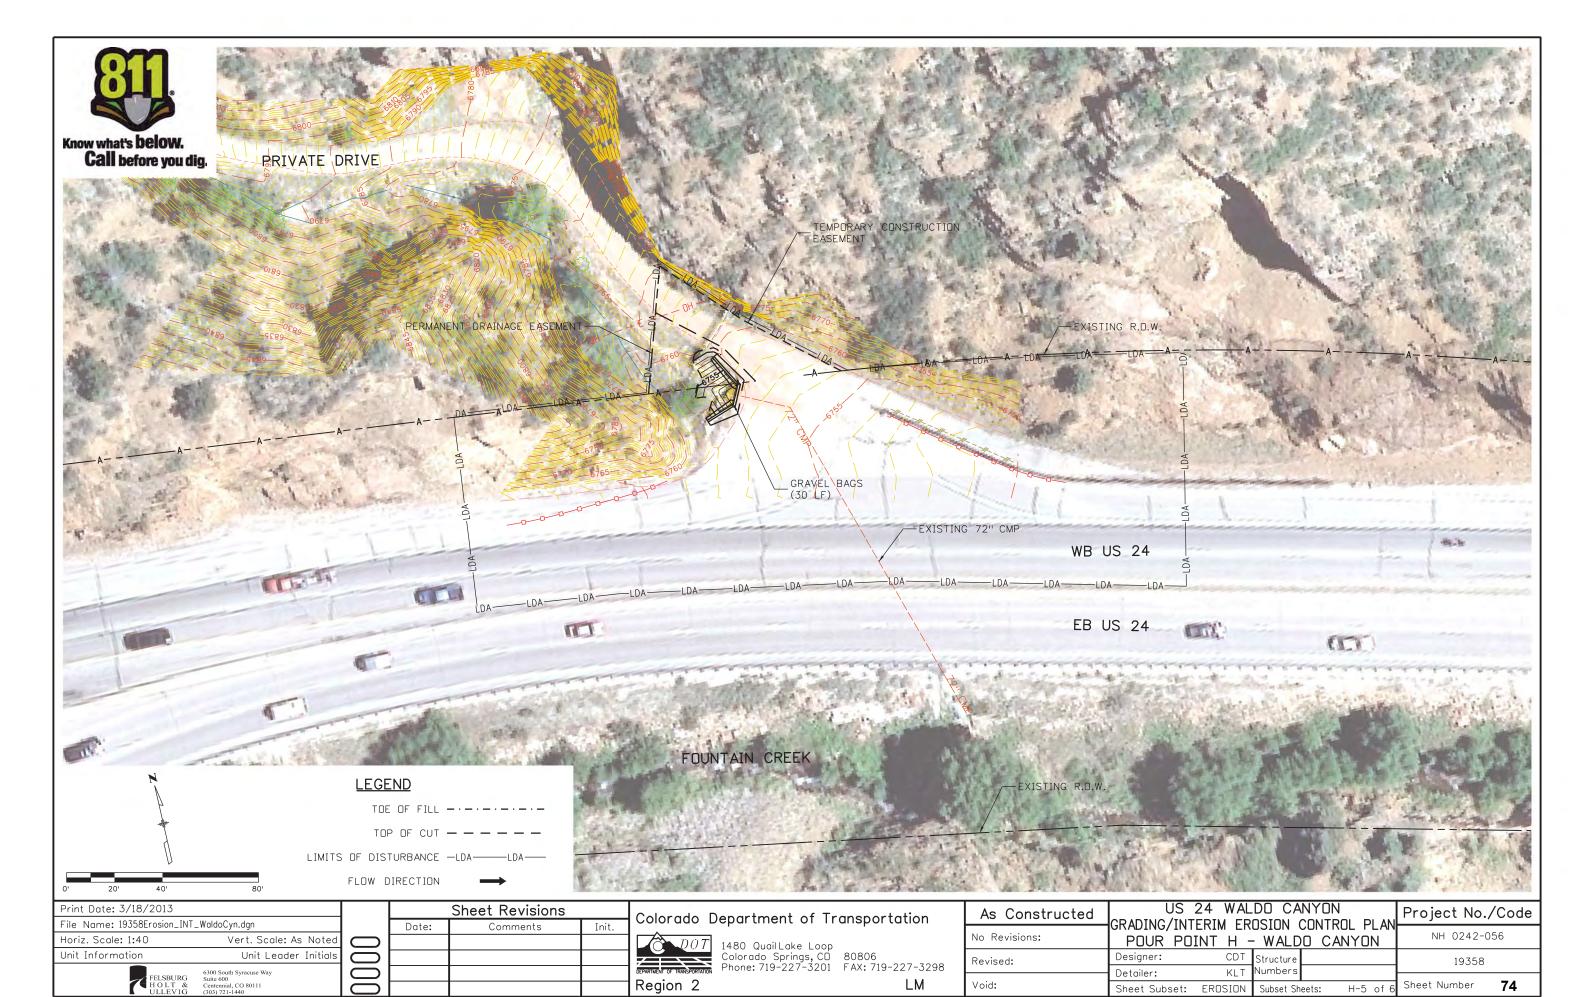
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Unit Information	Unit Leader Initials	(
FELSBURG HOLT & ULLEVIG	6300 South Syracuse Way Suite 600 Centennial, CO 80111 (303) 721-1440	(

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			DEPARTMENT OF TRANSPORTATION
			Region 2

Colorado D	epartment of Tr	ansportation
DOT	1480 QuailLake Loop Colorado Springs, CO Phone: 719-227-3201	

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	As Constructed	TABULATION		Project No./Code			
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	Revised:	Designer:	CDT	Structure		19358	
	Detailer:	KLT	Numbers				
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P17

C2 1+15.04 378347.3184 N 2°36'18" E 1+28.95 378361.2104 C3 1+32.66 378364.9059 N 6°51'19" E 1+47.70 378379.8446 C4 1+65.53 378397.6298 N 6°45'49" W 1+87.52 378419.4666 C5 1+90.95 378422.8574 N 10°41'44" W 2+09.86 378441.4396 C6 2+38.69 378466.7210 N 43°43'35" W 2+49.94 378474.8555 C7 2+69.29 378485.9345 N 65°53'41" W 2+91.11 378494.8469 C8 378498,7147 3+02.58 N 74°39'30" W 3+22,23 378503.9131 C9 3+24.81 378504.5500 N 76°37'49" W 3+48.88 378510.1174 C10 3+84.74 378523.2698 N 60°11'24" W 378553.7373 4+46.03 0+87.41 1*0₀ -ACCESS ROAD HCL

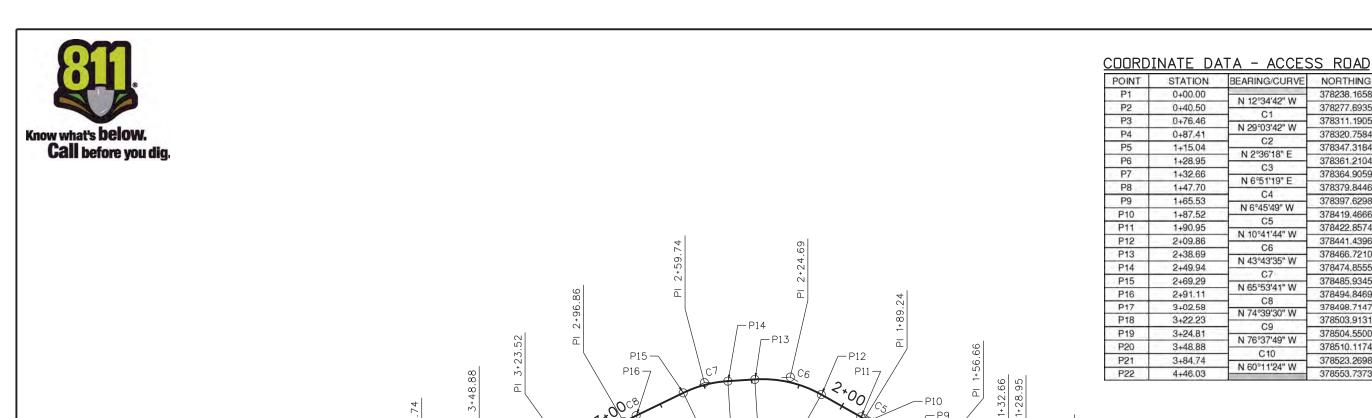∟P2

BEARING/CURVE

N 12°34'42" W

C1

N 29°03'42" W

NORTHING

378238.1658

378277.6935

378311,1905

378320.7584

EASTING

165043.9779

165035.1582

165022.4205

165017.1035

165010.8601

165011.4921

165011.7979

165013.5939

165013.6081

165011.0183

165010.4976

165006.9880

164993.9890

164986.2083

164970.4967

164950.5776

164939,7894

164920.8411

164918.3406

164894,9289

164861.6924

164808.5145

CURVE DATA - ACCESS ROAD CURVE RADIUS LENGTH TANGENT DELTA C1 16°29'00" 125 35.96 18.11 C2 31°40'00" 50 27.63 14.18 C3 4°15'01" 50 3.71 1.86 C4 13°37'08" 75 17.83 8.96 C5 3°55'55" 50 3.43 1.72 C6 33°01'52" 50 28.83 14.83 C7 22°10'05" 50 19.35 9.80 C8 8°45'50" 75 11.47 5.75 C9 1°58'19" 75 2.58 1.29 C10 16°26'25" 125 35.87 18.06

PT 2+38.69 PC 2+09.86

P5-

PI 1+01.59

0+76.46

0+40.50

0'	20'	40'	80'
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ULLEVIG (303) 721-1440				

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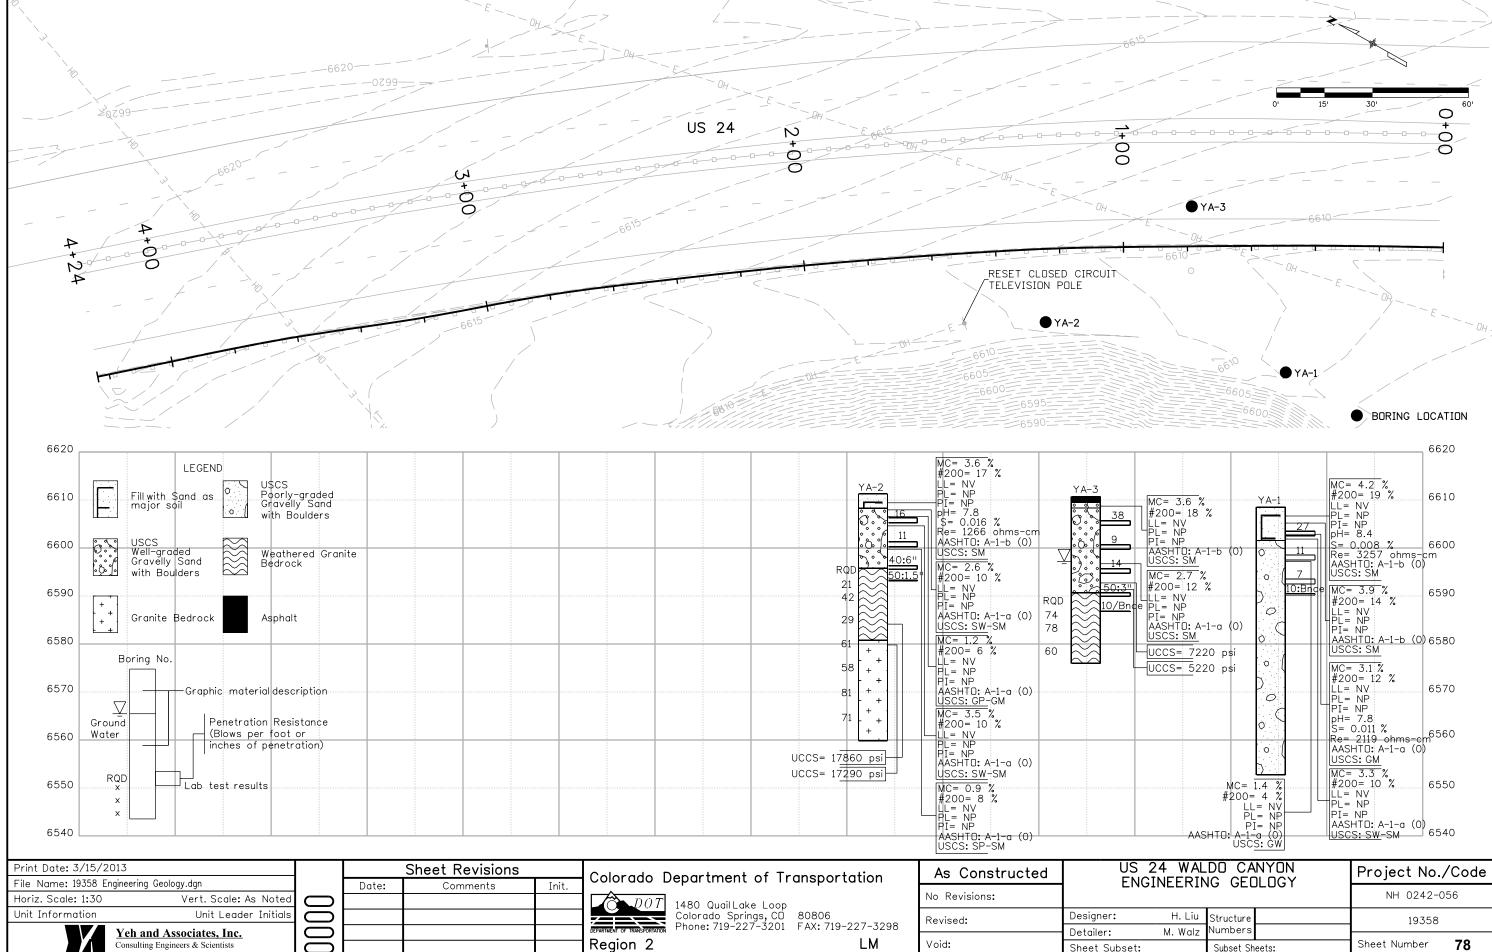
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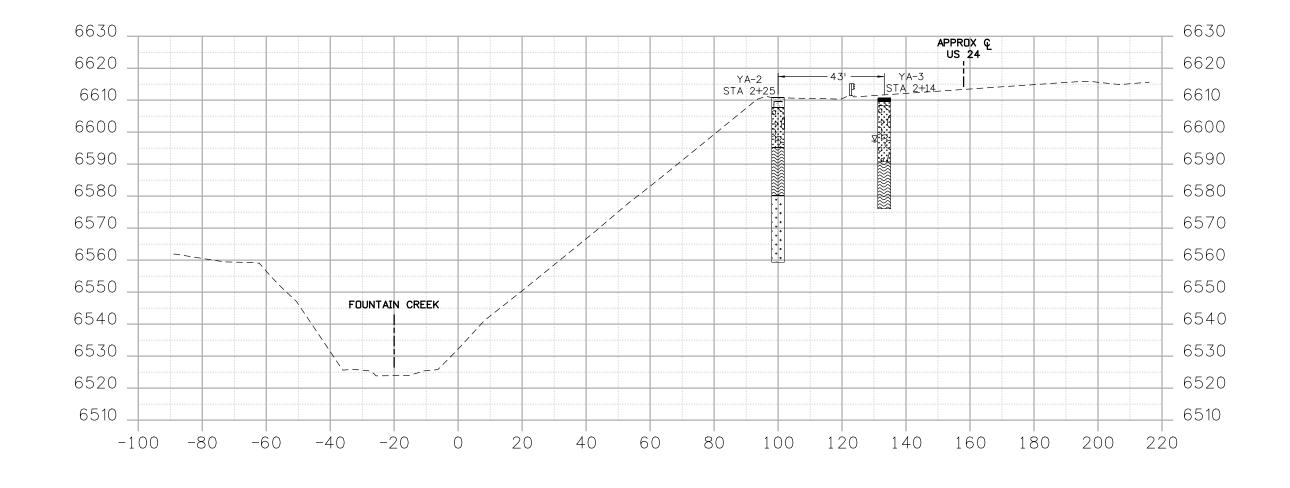
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DO	T 1480 Quaillake Loop	


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DEPARTMENT OF TRANSPORTATION	Pr
Region 2	

480 QuailLake Loop Colorado Springs, CO 80806 Phone: 719-227-3201 FAX: 719-227-3298 LM

As Constructed	US 24 WAL GENMETE	Project No./Code			
No Revisions:	POUR POINT J	NH 0242-056			
Revised:	Designer: CDT Detailer: KLT	Structure Numbers	19358		
Void:	Sheet Subset: ROADWAY	ļ	Sheet Number 77		






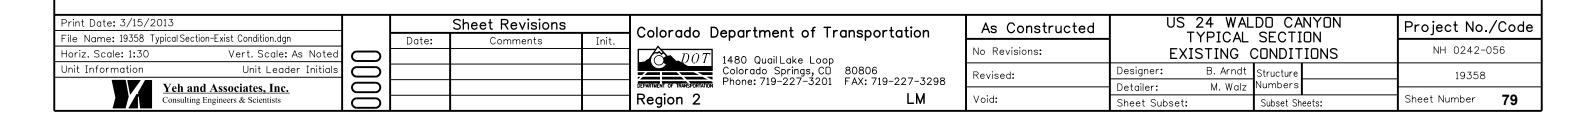



NOTE: SEE GRADING AND SECTION DETAIL

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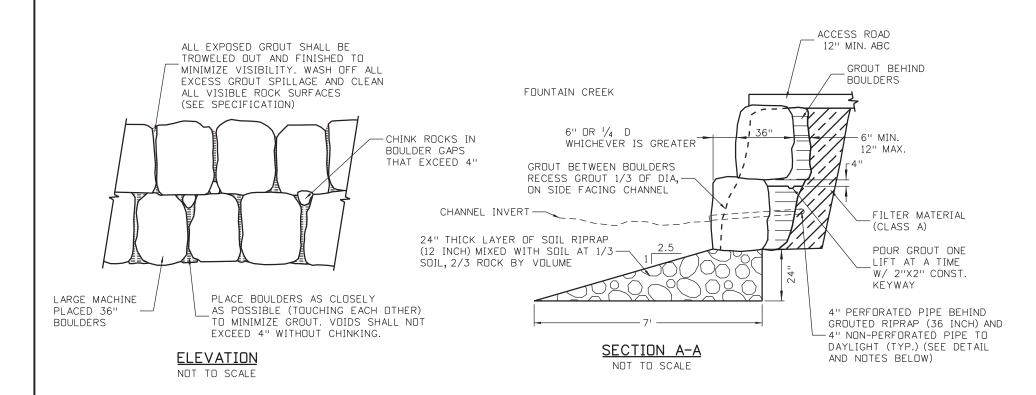
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Sheet Subset: ROADWAY

Sheet Number
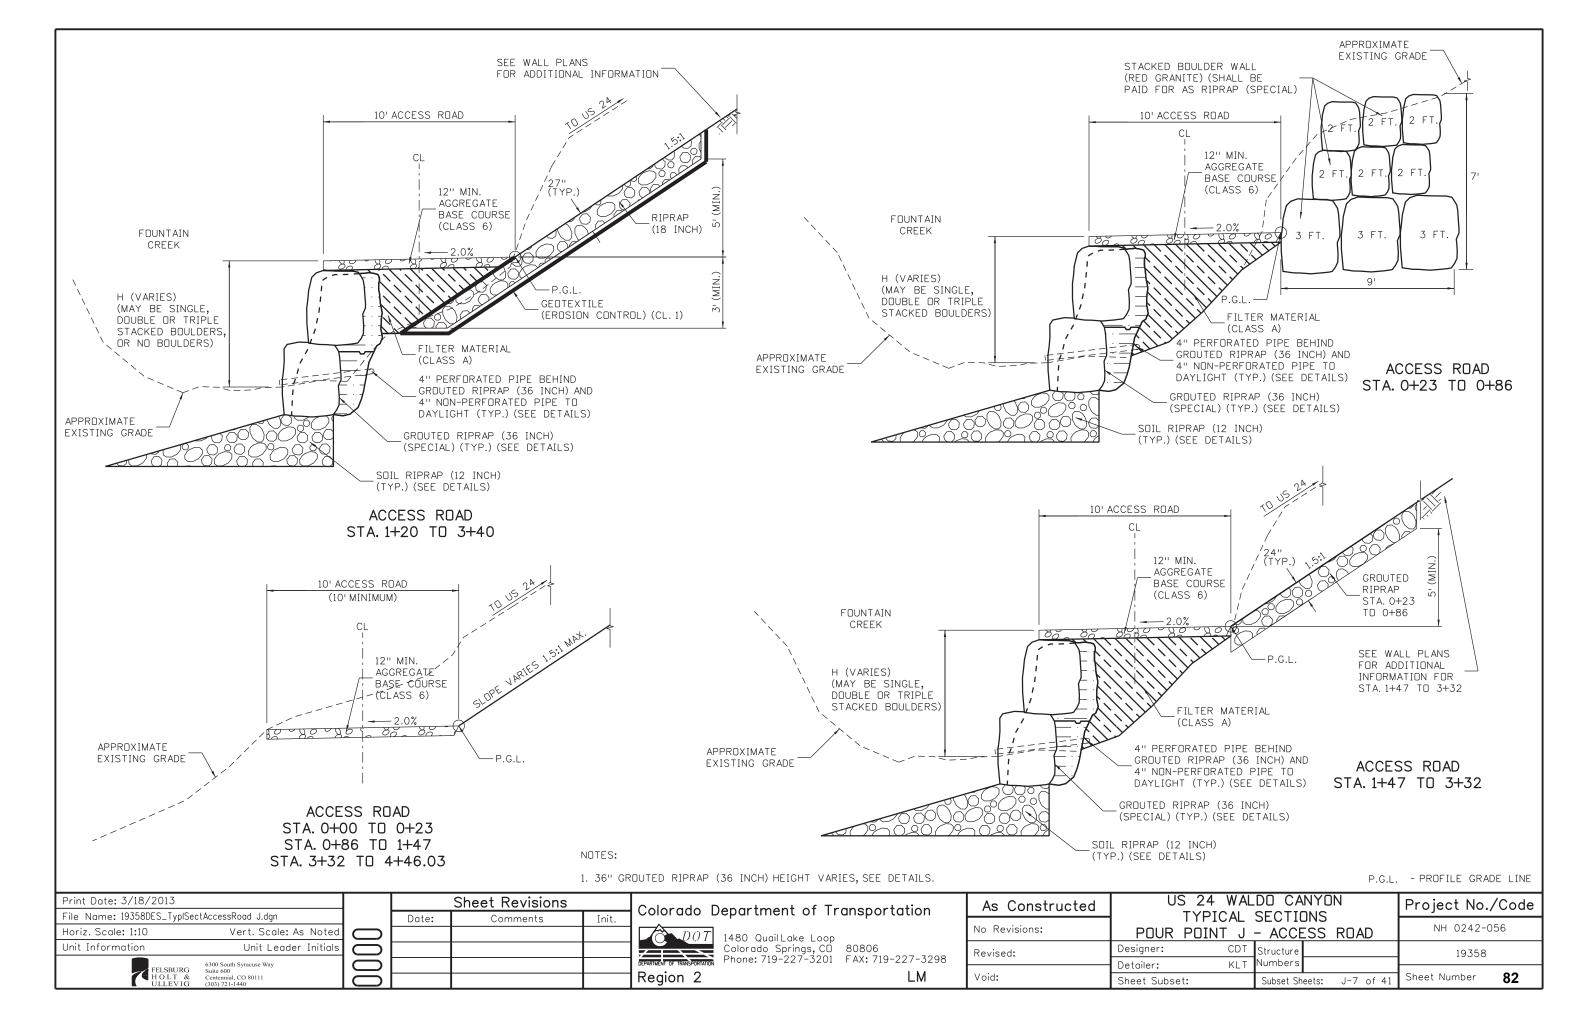
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Region 2

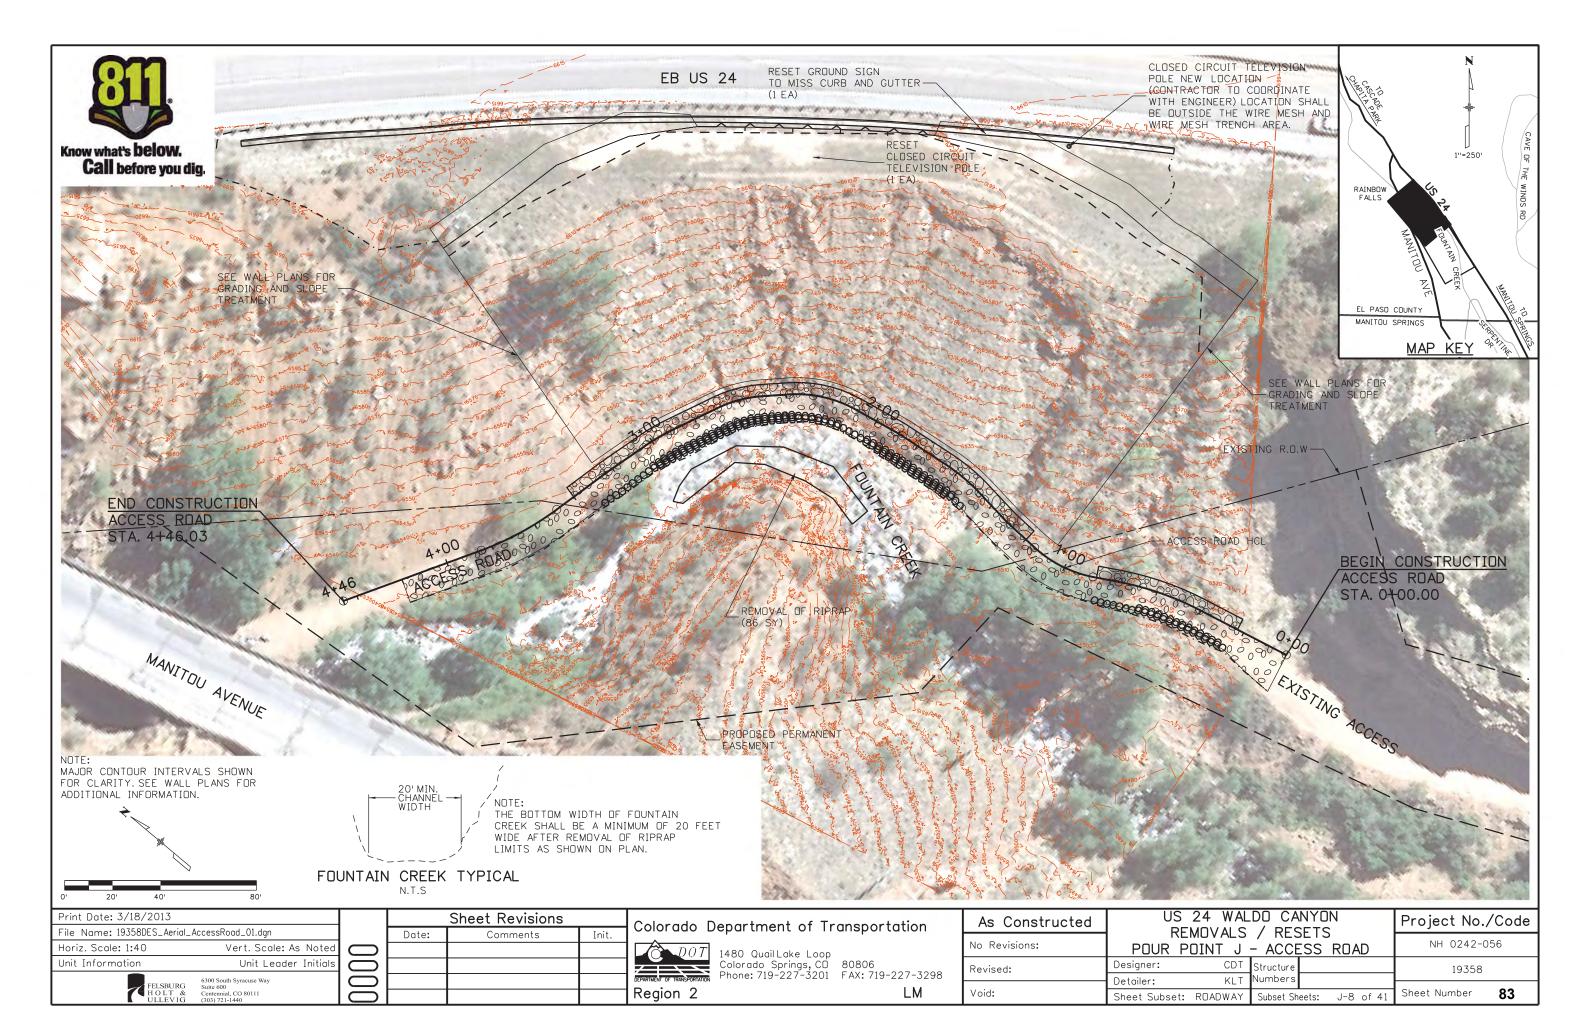

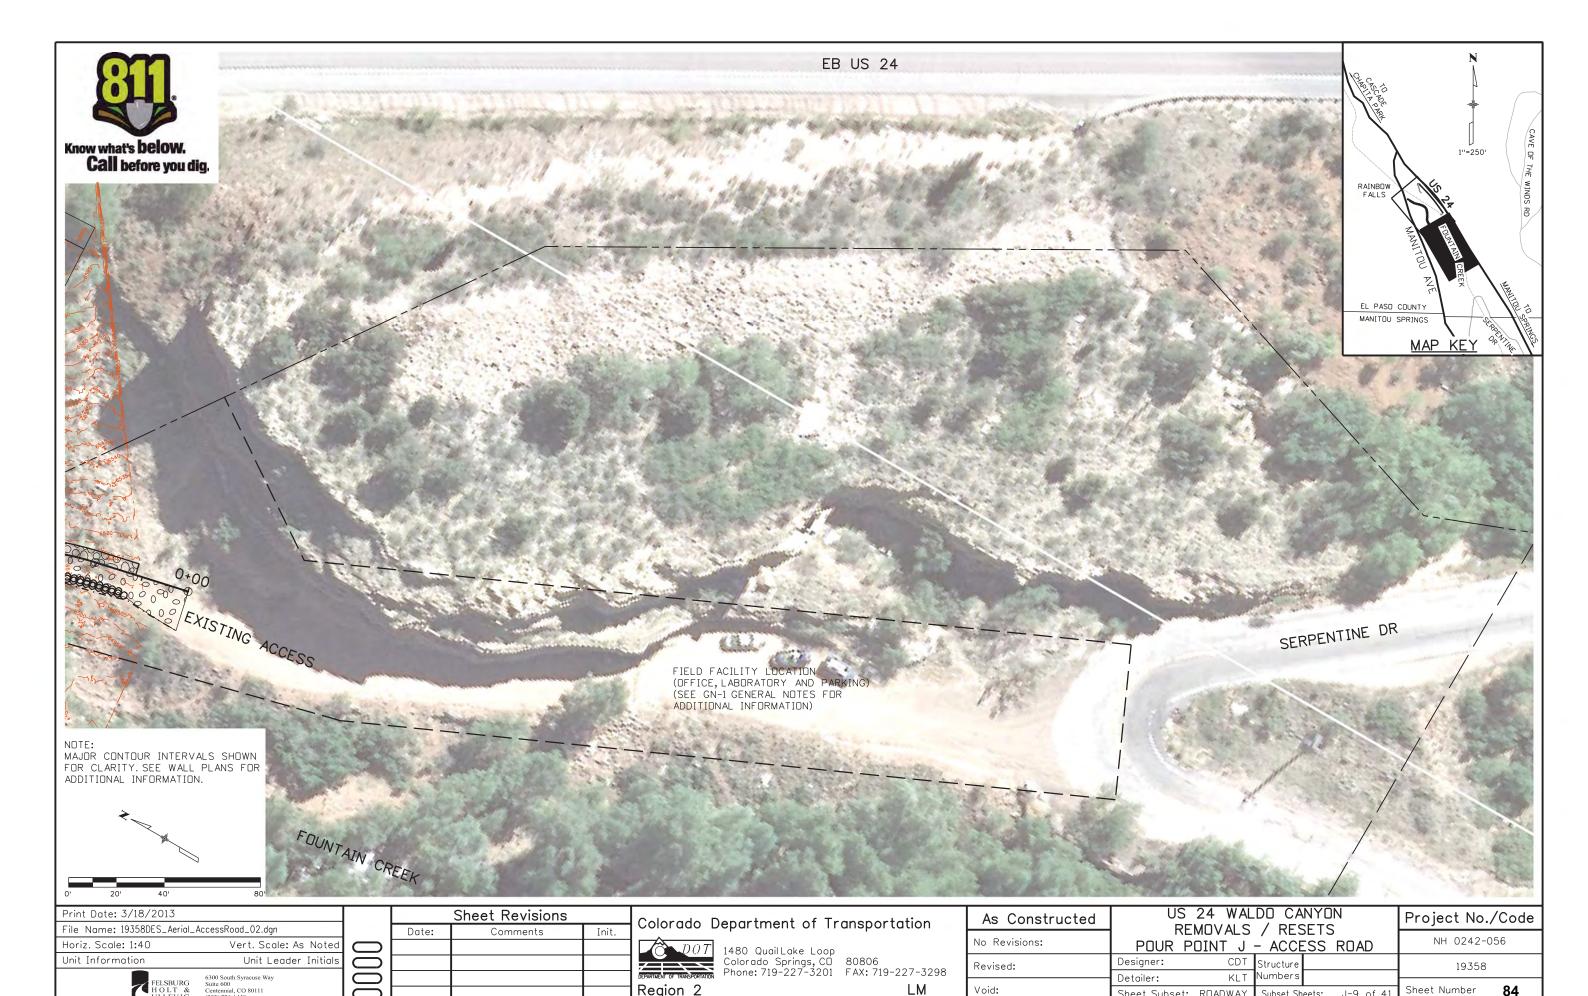EROSION CONTROL BLANKET (STRAW/COCONUT) (SEE EROSION CONTROL -PLANS FOR LOCATION AND QUANTITIES) FINISHED GRADE -DESIGN RIPRAP GRADE SOIL RIPRAP (d50) (SEE PLANS) (MIX SOIL AND RIPRAP) TOPSOIL 6" TYP. DEPTH= 2' MIN. SUBGRADE VARIES (SEE PLANS) PEPARE COMPACTED SUBGRADE PER SPECIFICATIONS OR PLACE ON UNDISTURBED SUBGRADE OR SLOPE VARIES GEOTEXTILE (EROSION CONTROL) (SEE PLANS)


SOIL RIPRAP (d50) TYPICAL SECTION NOT TO SCALE

SOIL RIPRAP (12 INCH) NOTES:

- SOIL RIPRAP DETAILS ARE APPLICABLE TO SLOPED AREAS. REFER TO THE PLAN FOR ACTUAL LOCATION AND LIMITS.
- 2. MIX UNIFORMLY 2/3 RIPRAP BY VOLUME WITH 1/3 OF APPROVED SOIL BY VOLUME FROM THE ENGINEER PRIOR TO PLACEMENT.
- 3. PLACE STONE-SOIL MIX TO RESULT IN SECURELY INTERLOCKED ROCK AT THE DESIGN THICKNESS. GRADE COMPACT AND LEVEL TO ELIMINATE ALL VOIDS AND ROCKS PROJECTING ABOVE DESIGN RIPRAP TOP GRADE.
- 4. CRIMP MULCH AS CALLED FOR IN THE PLANS AND SPECIFICATIONS.
- 5. TOPSOIL PAID FOR AS TOPSOIL (CY). SEE PLANS FOR ADDITIONAL INFORMATION.

GROUT PLACEMENT NOTES:

- 1. TRENCH BEHIND BOULDERS A MINIMUM OF 12" OR $\frac{1}{2}$ d50, WHICHEVER IS LESS.
- 2. PLACE AND VIBRATORY -COMPACT GROUT FOR BOTTOM ROW OF BOULDERS BEFORE PLACING AND GROUTING TOP ROW OF BOULDERS.
- 3. GROUT MAY BE MIXED ON SITE FROM ONE PART PORTLAND CEMENT AND SIX PARTS SAND, BY VOLUME (15% CEMENT).
- 4. EQUIPMENT FOR GROUTING OPERATIONS SHALL BE LOCATED SOUTH OF THE PROJECT NEAR THE CONSTRUCTION STAGING AREA ADJACENT TO SERPENTINE DR.
- 4" PERFORATED PIPE NOTES:
- 1. SEE M-605-1 FOR PIPE UNDERDRAIN TYPICAL SECTION.
- 2. ALL MATERIALS AND LABOR SHALL BE INCLUDED IN THE COST OF GROUTED RIPRAP (36 INCH) (SPECIAL).

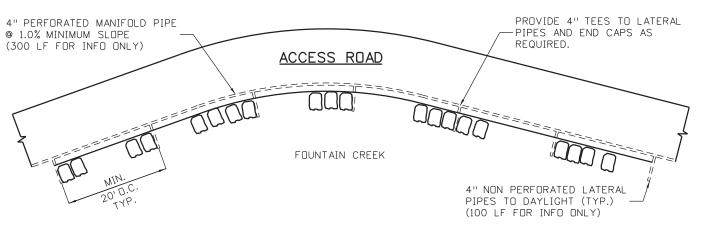


4" PERFORATED PIPE DETAIL


NOT TO SCALE

GROUTED RIPRAP (36 INCH) (SPECIAL) DETAILS

SOIL RIPRAP (d50) DETAILS

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Unit Information Unit Leader Initials				Colorado Springs, CD 80806		Revised:	Designer: CDT	Structure	19358
FELSBURG 600 South Syracuse Way				DEPARTMENT OF TRANSPORTATION Phone: 719-227-3201 FAX: 719-227-329	¹⁸		Detailer: KLT	Numbers	
HOLT & Centennial, CO 80111 ULLEVIG (303) 721-1440				Region 2 LM		Void:	Sheet Subset: ROADWAY	Subset Sheets: J-10 DF 41	Sheet Number 85

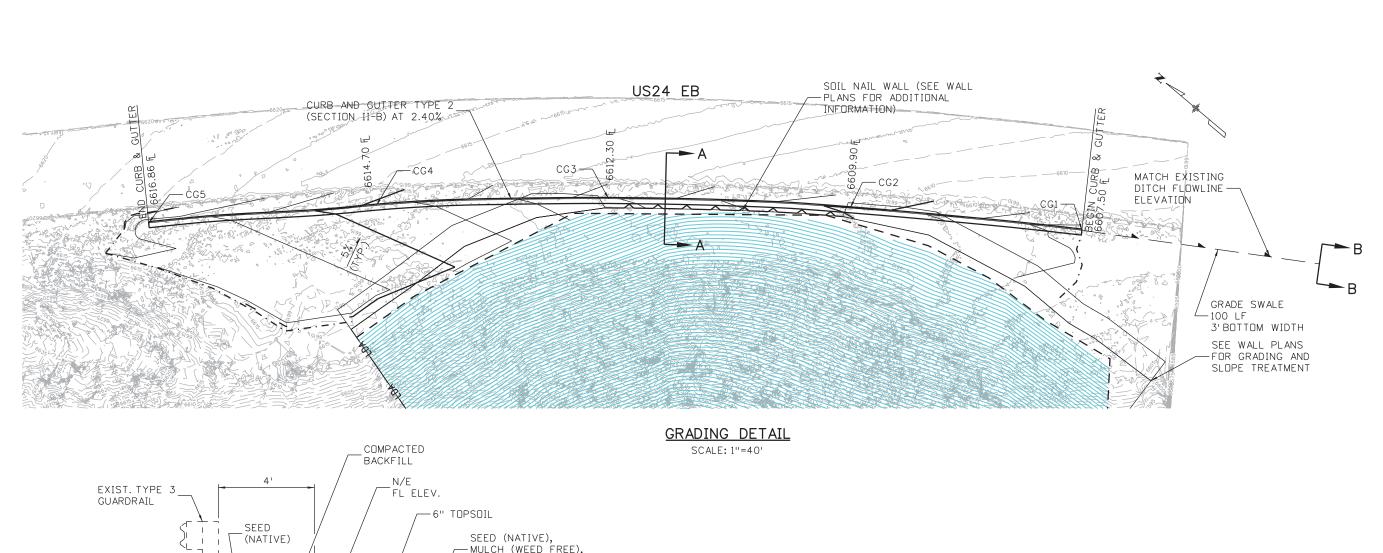

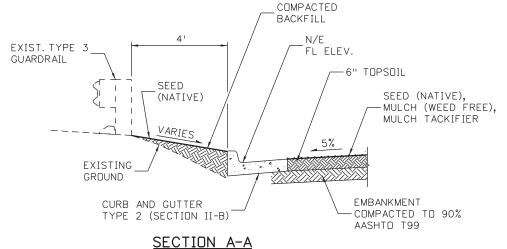

HORIZONTAL SCALE: 1"=10'

VERTICAL SCALE: 1"=10"

MATCH EXISTING DITCH FLOWLINE

SECTION B-B

N.T.S.

POINT DATA FOR CURB AND GUTTER

POINT	NORTHING	EASTING	ELEVATION	DESCRIPTION
CG1	165175.58	378409.65	6607.50	FINISHED GRADE - C&G FLOWLINE ELEVATION
CG2	165120.64	378489.65	6609.90	FINISHED GRADE - C&G FLOWLINE ELEVATION
CG3	165058.85	378569.31	6612.30	FINISHED GRADE - C&G FLOWLINE ELEVATION
CG4	164994.40	378641.67	6614.70	FINISHED GRADE - C&G FLOWLINE ELEVATION
CG5	164927.83	378709.67	6616.86	FINISHED GRADE - C&G FLOWLINE ELEVATION

Print Date: 3/18/2013		
File Name: 19358HYDR_Detail.	_AccessRoad_02.dgn	
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Unit Information	Unit Leader Initials	(
FELSBURG HOLT & ULLEVIG	6300 South Syracuse Way Suite 600 Centennial, CO 80111 (303) 721-1440	

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DEPARTMENT	$\overline{}$		1480 QuailLake Loop Colorado Springs, CO Phone: 719-227-3201	

As Constructed	US 24 WALDO CANYON GRADING DETAIL POUR POINT J - ACCESS ROAD			Project No./Code			
No Revisions:				NH 0242-056			
Revised:	Designer:		Structure Numbers			19358	
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GENERAL NOTES

- GROUND NAIL WALL IS INTENDED AS AN EMBANKMENT SLOPE STABILIZATION SYSTEM THAT WILL BE BACKFILLED IN FRONT OF THE FACING.
- ALL STEEL SHALL BE EPOXY-COATED OR GALVANIZED UNLESS OTHERWISE NOTED.
- 3. N DENOTES NON-COATED REINFORCING STEEL.

WIRE MESH

- WIRE MESH. WIRE MESH FOR FINAL SLOPE SHALL BE 8 X 10 DOUBLE TWIST HEXAGONAL NETTING, ZINC AND PVC COATED IN ACCORDANCE WITH ASTM A975-97 (2003). THE MINIMUM MESH WIRE DIAMETER SHALL BE 2.7 MM AND HAVE A TENSILE STRENGTH OF 75 KSI PER ASTM A 641 FOR SOFT TEMPER STEEL. CONTRACTOR SHALL SUBMIT SAMPLE COLOR FOR
- LACING WIRE AND FASTENERS. LACING WIRES, FASTENERS, TIES, CLIPS, AND CONNECTING WIRE SHALL BE SUPPLIED IN SUFFICIENT QUANTITY FOR SECURELY FASTENING ALL EDGES OF THE SLOPE PROTECTION WIRE MESH AS SHOWN IN THE PLANS AND SHALL BE IN ACCORDANCE WITH ASTM A 975-97(2003) PER PVC COATED GABION CHARACTERISTICS.
- MESH WILL BE MEASURED AND PAID BY THE SQUARE FOOT COMPLETED IN PLACE EXCLUSIVE OF THE AREA OF WIRE MESH USED IN ANY OVERLAPS. CONTRACTOR TO VERIFY QUANTITIES WITH ENGINEER PRIOR TO ORDERING MATERIALS.

GROUND NAIL WALL

- GROUND NAILS-ASTM A 519, HOLLOW INJECTION BAR, MINIMUM 1-1/2INCH (38mm) BAR WITH A MINIMUM YIELD STRENGTH OF 90 KIPS. BARS SHALL BE EPOXY COATED PER ASTM A-934 (PURPLE COATING).
- CONTRACTOR TO INSTALL 3 VERIFICATION TESTS AT LOCATIONS DESIGNATED IN PLANS OR AS APPROVED BY THE ENGINEER. VERIFICATION GROUND NAILS TO BE INSTALLED FULL DI WITH UPPER 10 FEET HAVING ADEQUATE BOND BREAKER TO TRANSFER LOADING TO BOTTOM 5 FEET OF GROUND NAIL. TESTING SHALL BE CONDUCTED AND ACCEPTED BY THE ENGINEER PRIOR TO PRODUCTION NAIL CONSTRUCTION.
- GROUT GROUT MAY BE NEAT-CEMENT OR WITH SAND, WITH TYPE II CEMENT IN ACCORDANCE WITH ASTM C150. WATER-CEMENT RATIO SHOULD BE BETWEEN 0.4 AND 0.6 AND GROUT SHOULD DEVELOP THE FOLLOWING STRENGTHS AT THE SPECIFIED CURE PERIODS.

 f'c=3,000 PSI MINIMUM 7 DAY
- END HARDWARE NUTS AND WASHERS SHALL BE IN ACCORDANCE WITH GROUND NAIL MANUFACTURER'S RECOMMENDATIONS BEARING PLATE SHALL BE IN ACCORDANCE WITH ASTM A36, GRADE 36. ALL NUTS, WASHERS AND BEARING PLATES SHALL BE EPOXY COATED IN ACCORDANCE WITH ASTM A934.
- SHOTCRETE IN ACCORDANCE WITH CDOT REVISED SECTION 641.
- UNLESS OTHERWISE NOTED ON THE PLANS, MINIMUM COVER OF SHOTCRETE REINFORCEMENT AND NAIL END HARDWARE SHOULD BE AS FOLLOWS:
 FACE EXPOSED TO WEATHER 2"
 FACE EXPOSED TO SOIL 3"
- 7. WELDED WIRE MESH SHALL BE IN ACCORDANCE WITH ASTM A185. FY=65,000 PSI
- WALERS AND VERTICAL BEARING BARS SHALL BE IN ACCORDANCE WITH ASTM A615. FY=60,000 PSI
- STRIP DRAINS CONSIST OF 12" WIDE DIMPLED CORES WRAPPED IN GEOTEXTILE IN ACCORDANCE WITH SPECIAL PROVISIONS.

<u>GROUND NAIL WALL SPECIAL NOTES</u>

- THE CONTRACTOR IS RESPONSIBLE FOR MAINTAINING SLOPE STABILITY ABOVE AND BELOW THE GROUND NAIL WALL DURING CONSTRUCTION.
- THE CONTRACTOR IS RESPONSIBLE FOR FIELD LOCATING ALL NEARBY UTILITIES. CONFLICTING UTILITIES MAY REQUIRE GROUND NAIL WALL REDESIGN, AT ENGINEER'S DISCRETION.
- THE BOND STRENGTHS (Q_d) SHOWN ON THE PLANS ARE THE MINIMUM ASSUMED FOR DESIGN.
- GROUND NAIL LENGTHS SHOWN ON THE PLANS ARE THE MINIMUM LENGTHS REQUIRED.
- 5. PRIOR TO BEGINNING EXCAVATION FOR THE GROUND NAIL WALL, THE CONTRACTOR SHALL:
 - A. SURVEY THE LAYOUT LINE AND TOP OF WALL LINE.
 - CONFIRM THE LINES, GRADES, AND EXCAVATION LIMITS SHOWN ON THE PLANS.
 - THE CONTRACTOR SHALL MODIFY THE PLAN WALL PROFILES USING THE FIELD SURVEY INFORMATION AND SUBMIT TO THE ENGINEER FOR REVIEW AND APPROVAL.

GROUND NAIL WALL CONSTRUCTION SEQUENCE

- EXCAVATE ONE LIFT TO A MAXIMUM DEPTH OF FIVE (5) FEET. BOULDERS, COBBLES AND/OR BEDROCK MAY BE ENCOUNTERED AT ANY DEPTH OF THE EXCAVATION OR DURING DRILLING. IF SLOUGHING GROUND CONDITIONS ARE ENCOUNTERED, GROUND NAILS SHALL BE DRILLED AND INSTALLED THROUGH A TEMPORARY STABILIZING BERM OR PLACEMENT OF A SACRIFICIAL REINFORCED SHOTCRETE FLASH COAT SHALL BE USED TO TEMPORARILY STABILIZE EXCAVATION PRIOR TO DRILLING GROUND NAILS, CARE SHOULD BE TAKEN DURING EXCAVATION THAT NO GROUND IS LOST FROM BEHIND THE EXISTING SHOTCRETE.
- PROVIDE A PRODUCTION NAIL LOCATION PLAN TO THE ENGINEER FOR REVIEW. INSTALL GROUND NAILS AT THE SPACINGS AND TO THE LENGTHS SHOWN ON THE PLANS. INJECT GROUT CONTINUOUSL AS GROUND NAIL IS DRILLED/INSERTED. THE TOP ROW OF GROUND NAILS SHALL BE WITHIN 2.5 FEE OF THE TOP OF THE WALL. THE BOTTOM ROW OF NAILS SHALL BE WITHIN 2 FEET OF THE BOTTOM OF THE WALL. THE TOLERANCE FOR GROUND NAIL LOCATIONS SHALL BE 6 INCHES.
- THE DRILL HOLE SHALL BE GROUTED CONTINUOUSLY DURING DRILLING. CONTINUOUS GROUT FLOW SHALL BE OBSERVED AT THE SURFACE. IF LOSS OF GROUT CIRCULATION OCCURS, DRILLING ADVANCEMENT SHOULD BE STOPPED AND GROUT PUMPING SHALL CONTINUE UNTIL GROUT RETURN IS RE-ESTABLISHED. IF GROUT RETURN DOES NOT RE-ESTABLISH. THE BAR SHALL BE REMOVED AND THE ENGINEER SHOULD BE NOTIFIED. THE COMPLETE GROUND NAIL INSTALLATION, INCLUDING DRILLING, NAIL PLACEMENT AND GROUTING SHALL OCCUR WITHIN THE SAME WORK SHIFT. DRILL HOLES SHALL NOT BE LEFT OPEN OVERNIGHT FOR COMPLETION DURING A SUBSEQUENT SHIFT.
- INSTALL SHOTCRETE TO THE MINIMUM THICKNESS SHOWN ON THE DRAWINGS AND TO ATTAIN THE MINIMUM COVERAGES SPECIFIED HEREIN. GIVE SPECIAL ATTENTION TO FILLING THE VOID IN THE BORE HOLE ABOVE THE GROUT LINE. COLD WEATHER PROTECTION MEASURES MAY BE NECESSARY.
- INSTALL THE GROUND NAIL END HARDWARE AFTER THE SHOTCRETE HAS BEEN INSTALLED. WHILE THE SHOTCRETE IS STILL WET, EMBED THE PLATE INTO THE SHOTCRETE SURFACE UNTIL THERE IS NO VOID BEHIND THE PLATE. HAND TIGHTEN THE NUT. APPLY ADDITIONAL SHOTCRETE TO ATTAIN MINIMUM COVERAGE FOR THE GROUND NAIL AND END HARDWARE.
- ONCE THE GROUT AND SHOTCRETE OF THE CURRENT LIFT HAVE ATTAINED 50% OF THEIR SPECIFIED STRENGTHS, REPEAT CONSTRUCTION SEQUENCE TO THE BOTTOM OF THE WALL.
- 8. AT THE BOTTOM LIFT, CONSTRUCT GEOCOMPOSITE STRIP DRAINS AS SHOWN ON THE DRAWINGS.

GROUND NAIL WALL DESIGN PARAMETERS

1. THE FOLLOWING VALUES HAVE BEEN USED FOR DESIGN PARAMETERS:


Ф GRANULAR ON-SITE SOIL

ANGLE OF INTERNAL FRICTION COHESION UNIT WEIGHT DESIGN SHEAR RESISTANCE BOND STRESS (ALLOWABLE) Q_d

LIMITATIONS FOR ROCKFALL SYSTEM

ROCKFALL AND ROCKFALL EVENTS ARE SPORADIC AND UNPREDICTABLE. CAUSES CAN INCLUDE, BUT ARE NOT LIMITED TO, FACTORS SUCH AS ANIMAL, HUMAN, CONSTRUCTION, ENVIRONMENTAL, WEATHER, AND/OR EARTHQUAKES. BECAUSE OF THE MULTIPLICITY OF FACTORS AFFECTING ROCKFALL DYNAMICS, ROCKFALL CANNOT BE PREDICTED AND IS NOT AN EXACT SCIENCE THAT GUARANTEES THE SAFETY OF INDIVIDUALS AND PROPERTY. HOWEVER, BY THE APPLICATION OF SOUND ENGINEERING PRINCIPLES TO A RANGE OF ROCKFALL DYNAMICS, THE RISK OF INJURY AND PROPERTY LOSS CAN BE REDUCED BY THE USE OF PROPERLY DESIGNED ROCKFALL MITIGATION FEATURES IN IDENTIFIED RISK AREAS. CONSEQUENTLY, NEITHER THE ROCKFALL HAZARD IN TERMS OF PROBABILITY OF A ROCKFALL AT ANY SPECIFIC LÓCATION, NOR THE RISK TO PEOPLE OR FACILITIES FROM SUCH EVENTS, IS ASSESSED IN THE DESIGN.

PERIODIC INSPECTION AND MAINTENANCE OF ROCKFALL MITIGATION FEATURES IS NECESSARY TO ENSURE THE DESIRED PROTECTION LEVEL IS NOT DEGRADED BY IMPACT DAMAGE WHICH EXCEEDS THE DESIGN LIMITS OF THE MESH SYSTEM INCLUDING, BUT NOT LIMITED TO, EXTREMELY WET SNOW AVALANCHES OR LARGE DEBRIS FLOW EVENTS.

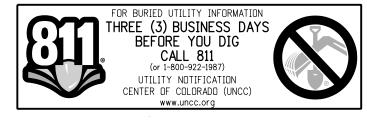


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Yeh and Associates, Inc.				DEPARTMENT OF TRANSPORTATION
Consulting Engineers & Scientists				Region 2


Colorado Department of Transportation




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GNL= GROUND NAIL LENGTH

⊕ 15' SACRIFICIAL GROUND NAIL LOCATIONS (BOND BREAKER IN UPPER 10' OF BAR)

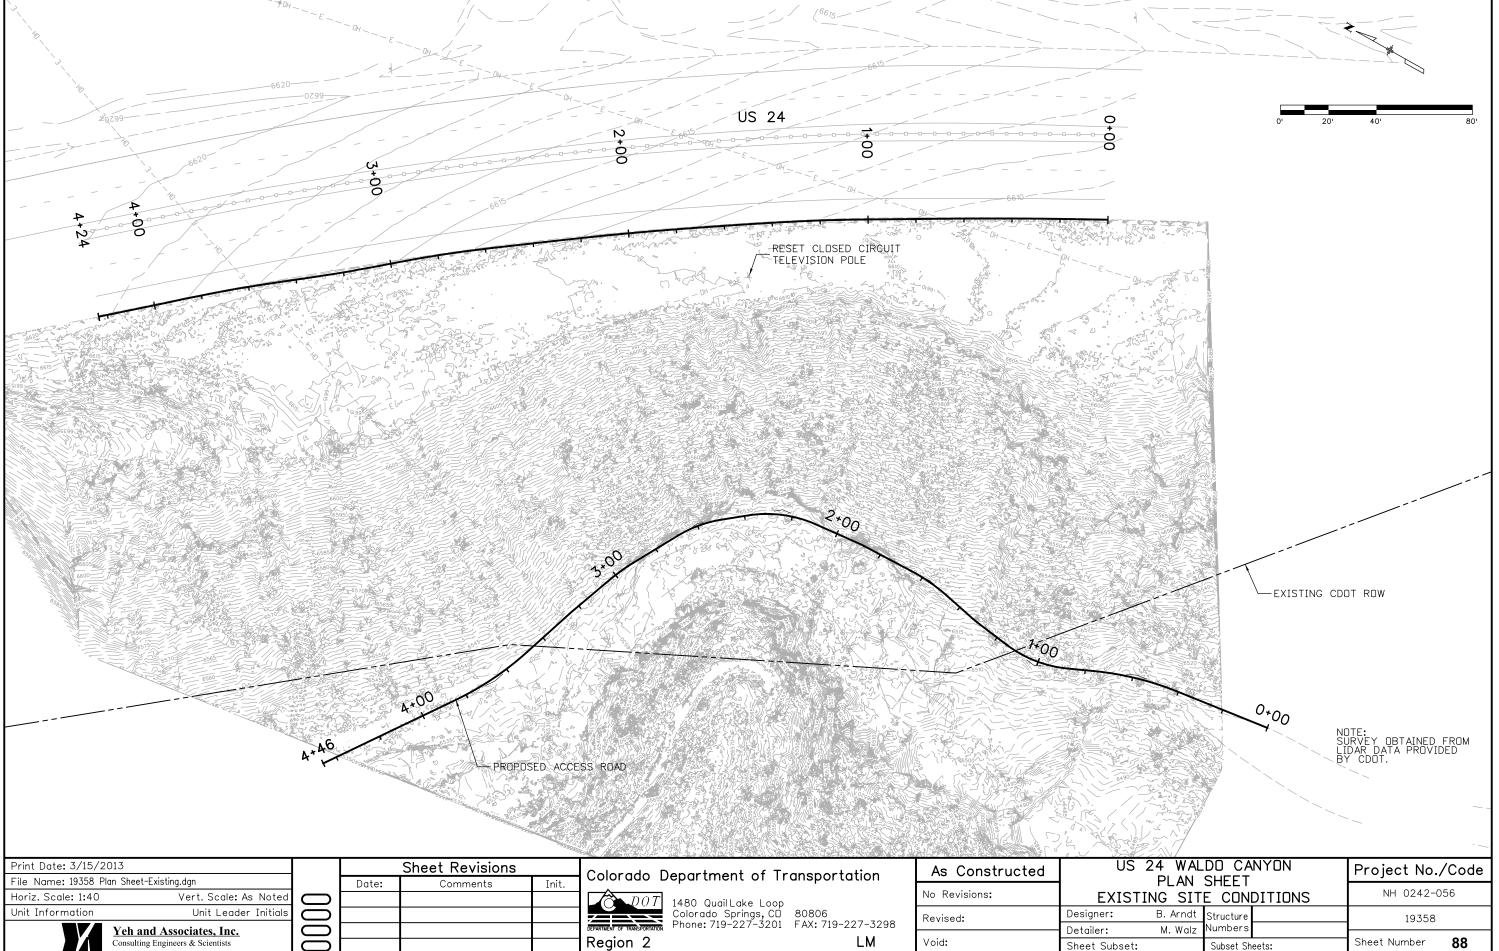Yeh and Associates, Inc.
Consulting Engineers & Scientists

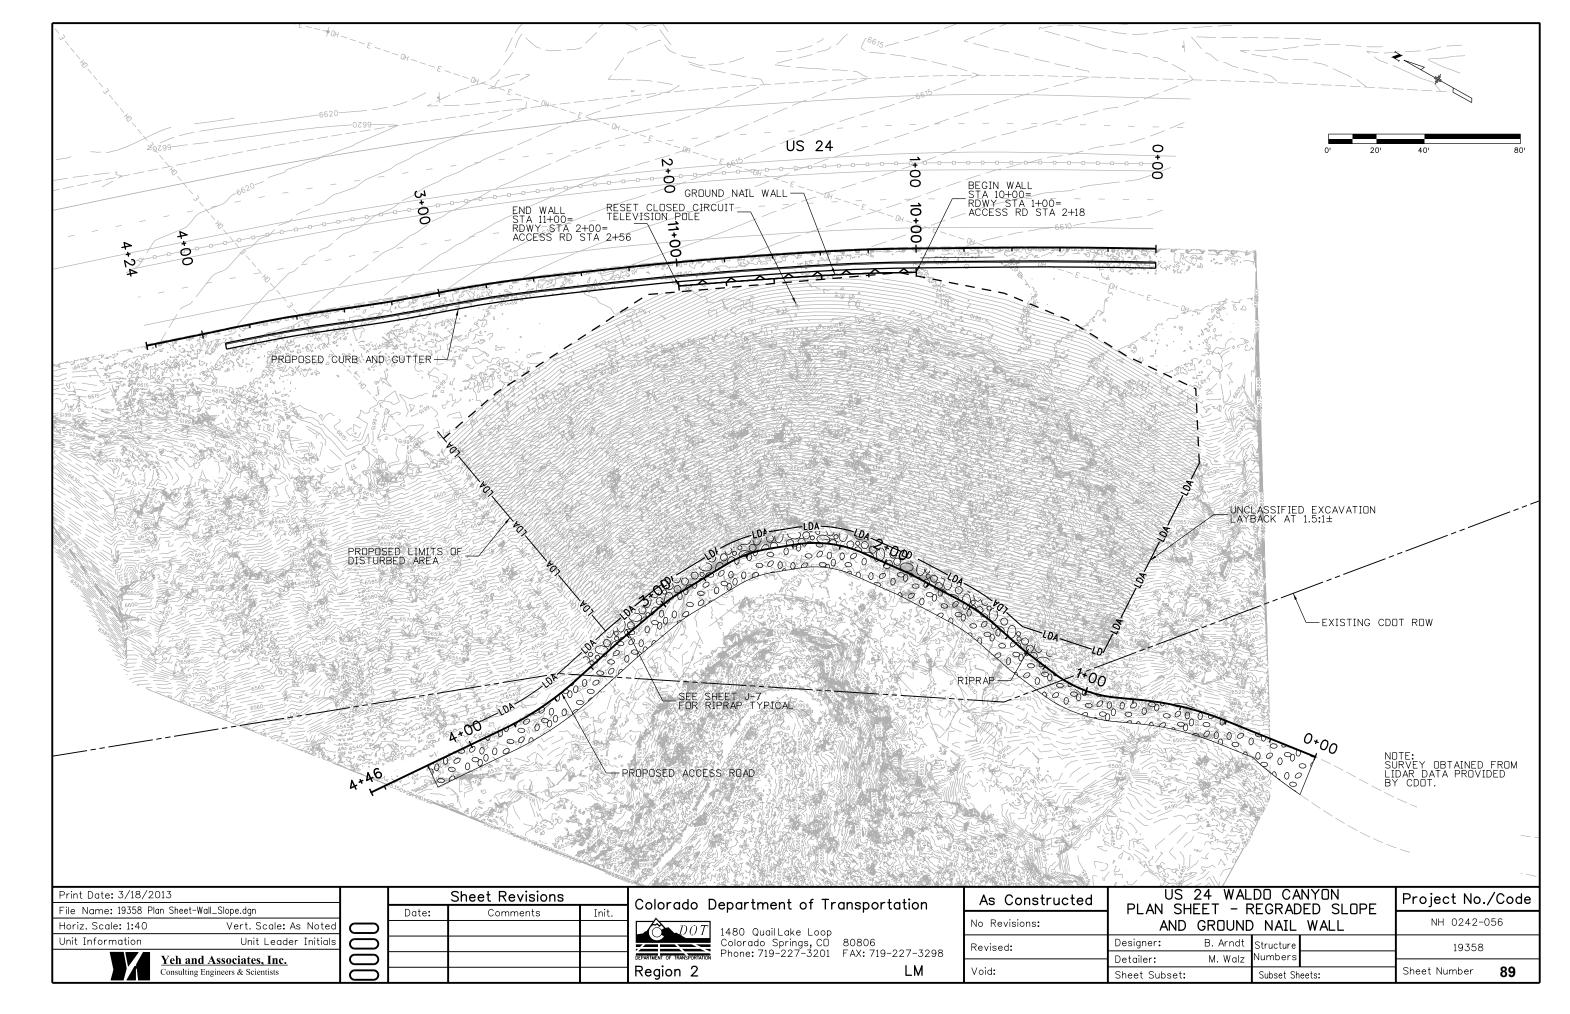Vert. Scale: As Noted

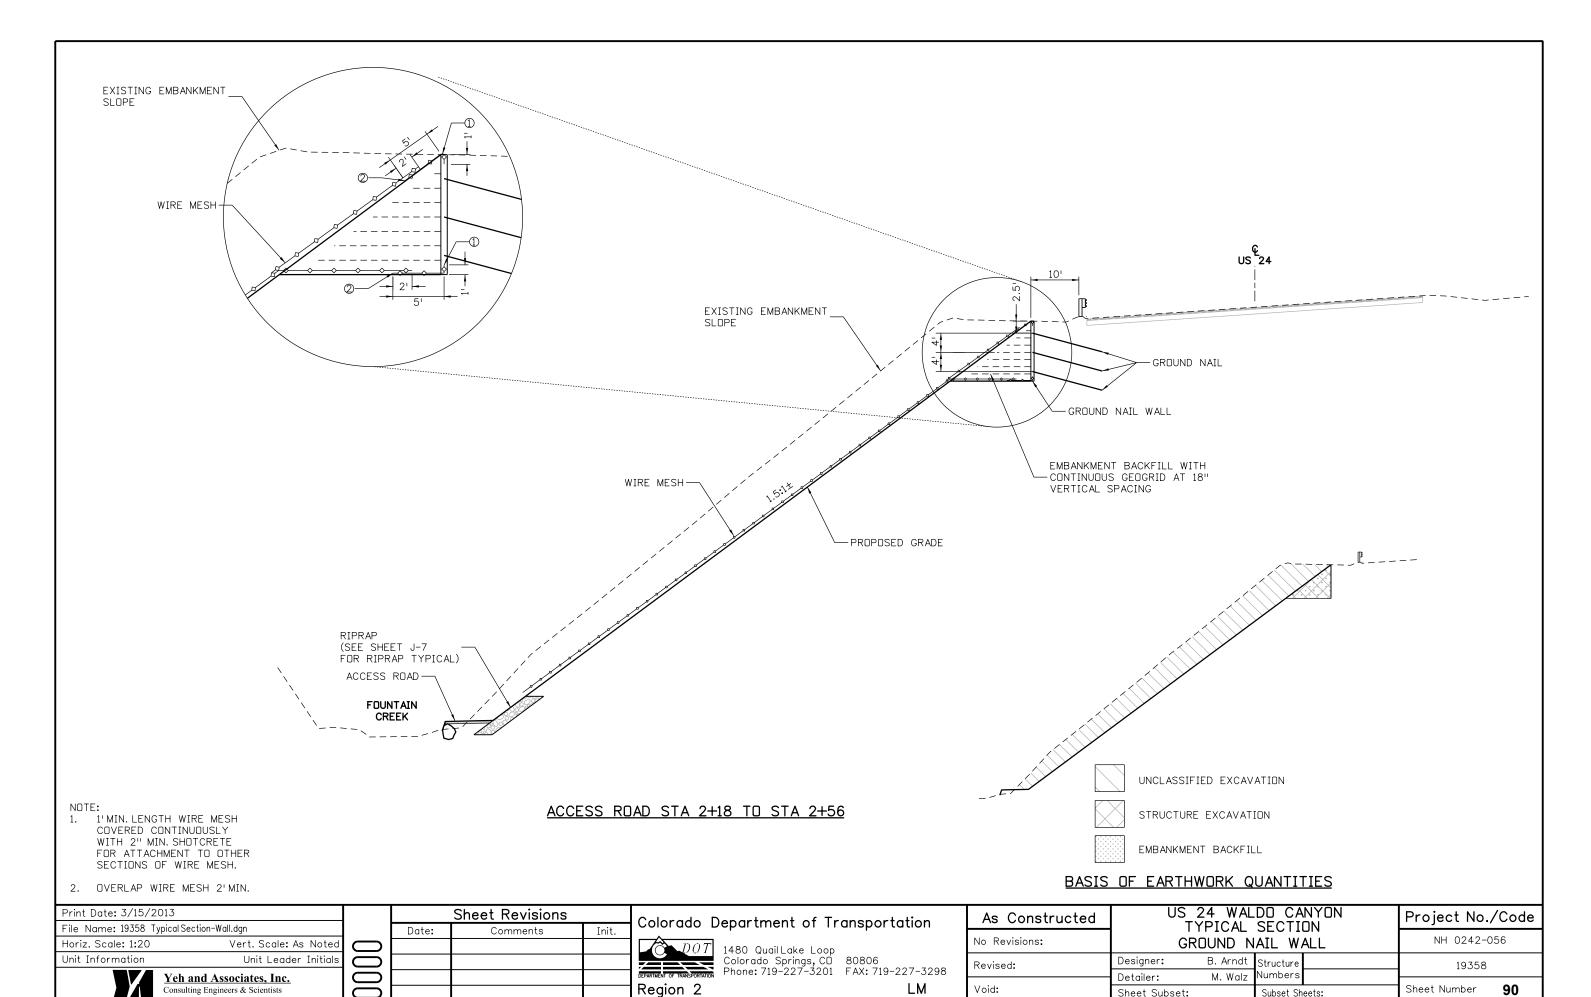Unit Leader Initials

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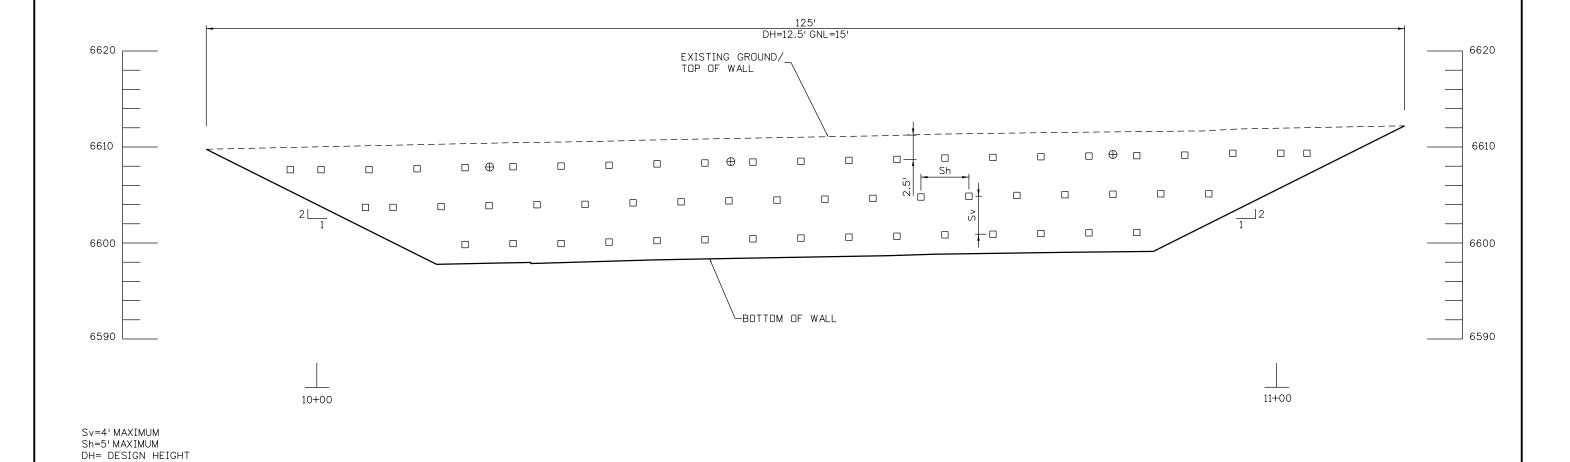
☐ 15' GROUND NAIL

Print Date: 3/15/2013

Horiz. Scale: 1:10

Unit Information

File Name: 19358 SN Elevation.dgn



Colorado Department of Transportation

1480 QuailLake Loop Colorado Springs, CD 80806 Phone: 719-227-3201 FAX: 719-227-3298 US 24 WALDO CANYON WALL ELEVATION

B. Arndt Structure

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M. Walz

Designer:

Detailer:

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As Constructed

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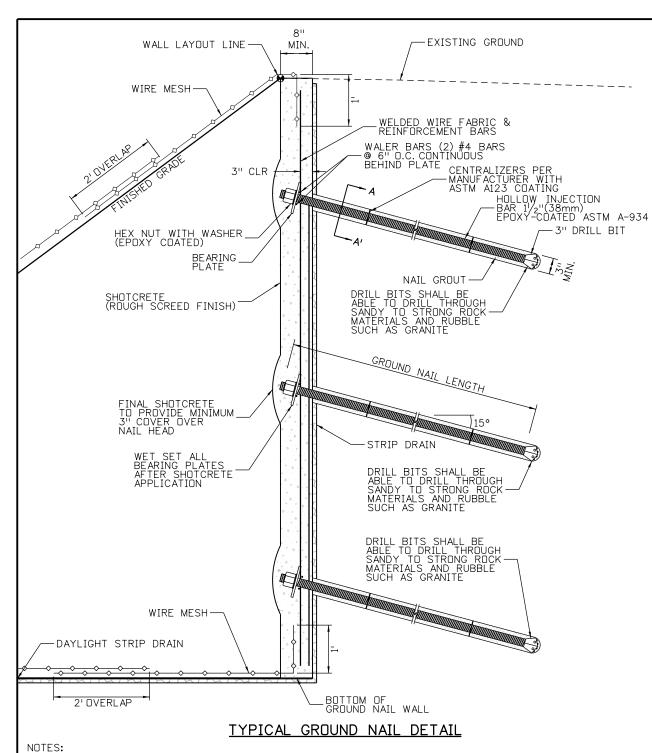
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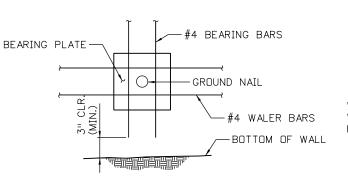


SHALL BE INSTALLED THROUGHOUT THE ENTIRE SHOTCRETE FACING, INCLUDING THE FACING BEYOND THE GROUND NAILS. 2. MAXIMUM EDGE DISTANCE OF 3 FT FOR


REINFORCEMENT OF THE SHOTCRETE FACING

- EACH ROW OF GROUND NAILS AT END OF WALL.


4. 3" MIN. COVER ON ALL REINFORCING EXPOSED TO GROUND.




TYPICAL REINFORCEMENT BOTTOM ROW OF GROUND NAILS

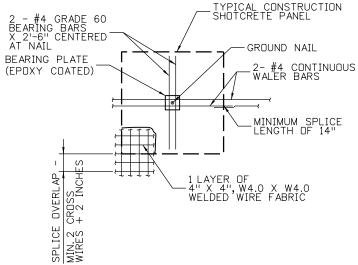


TYPICAL SHOTCRETE FACING PANEL REINFORCEMENT

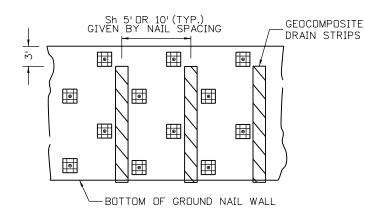


TYPICAL STRIP DRAIN DETAIL

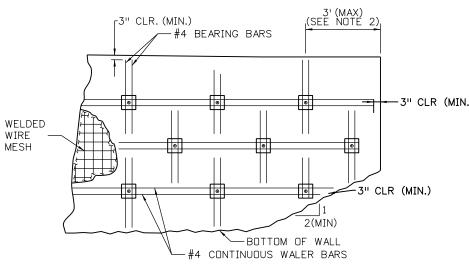

TYPICAL SHOTCRETE FACING REINFORCEMENT - END OF WALL (NOTE 1)

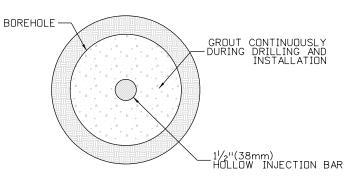

GROUND NAIL CROSS SECTION A-A'

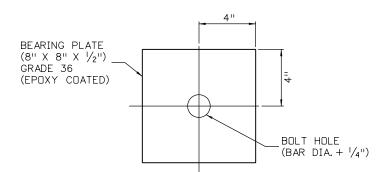

BEARING PLATE DETAIL

3.	THE	MINIMUM	SHOTCRETE	THICKNESS	IS	8	IN.
	FOR	WALL FA	CE.				

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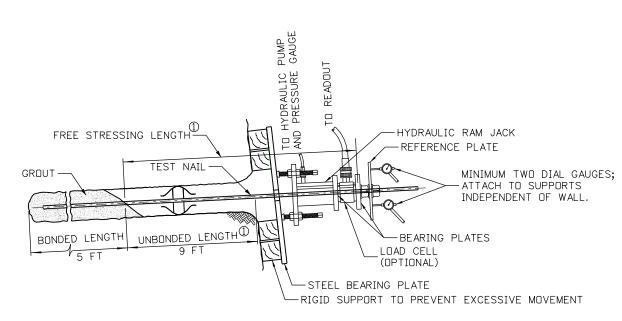
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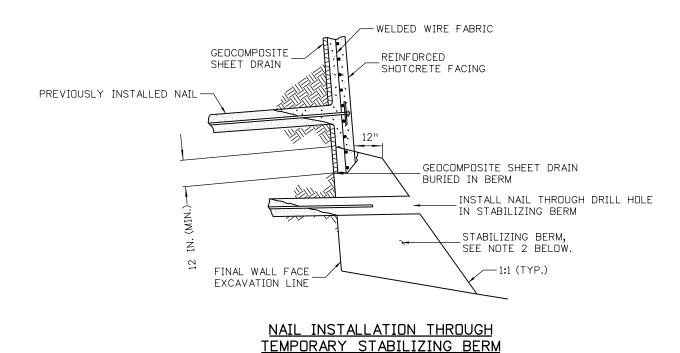
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80 QuailLake Loop Norado Springs, CD 80806 one: 719-227-3201 FAX: 719-227-3298 LM

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VERIFICATION GROUND NAIL TEST SETUP



(USE IN CASE OF SLOUGHING GROUND)

NOTES

- I. VERIFICATION NAILS WILL HAVE BONDED, UNBONDED AND FREE STRESSING LENGTHS. PRODUCTION NAILS WIL BE BONDED FOR THE FULL NAIL LENGTH.
- 2. EXCAVATE STABILIZING BERM TO FINAL WALL FACE EXCAVATION LINE FOR SHOTCRETE PLACEMENT. CONTRACTOR SHALL CAREFULLY EXCAVATE STABILIZING BERM TO AVOID HITTING GROUND NAILS BURIED IN THE BERM.

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Consul	ting Engineers & Scientists			

Colorado Department of Transportation




1480 Quail Lake Loop Colorado Springs, CD 80806 Phone: 719-227-3201 FAX: 719-227-3298


Region 2

US 24 WALDO CANYON GROUND NAIL DETAILS Project No./Code As Constructed NH 0242-056 No Revisions: B. Arndt Structure Designer: Revised: 19358 Numbers M. Walz Detailer: Void: Sheet Number 93 Sheet Subset: Subset Sheets:

GROUND NAIL TESTING NOTES:


- 1. SEE SPECIFICATIONS FOR TESTING REQUIREMENTS.
- 2. THE TEST SUPPORT SYSTEM (EG. CRIBBING, CHAIRS, BEARING PLATES, ETC.)
 SHALL BE SUFFICIENT TO COMPLETE THE TEST WITHOUT EXCESSIVE DEFLECTION
 OR BEARING FAILURE. IF TEST SETUP IS NOT ADEQUATE FOR TEST, CONTRACTOR
 SHALL PROPOSE SYSTEM TO ENGINEER.

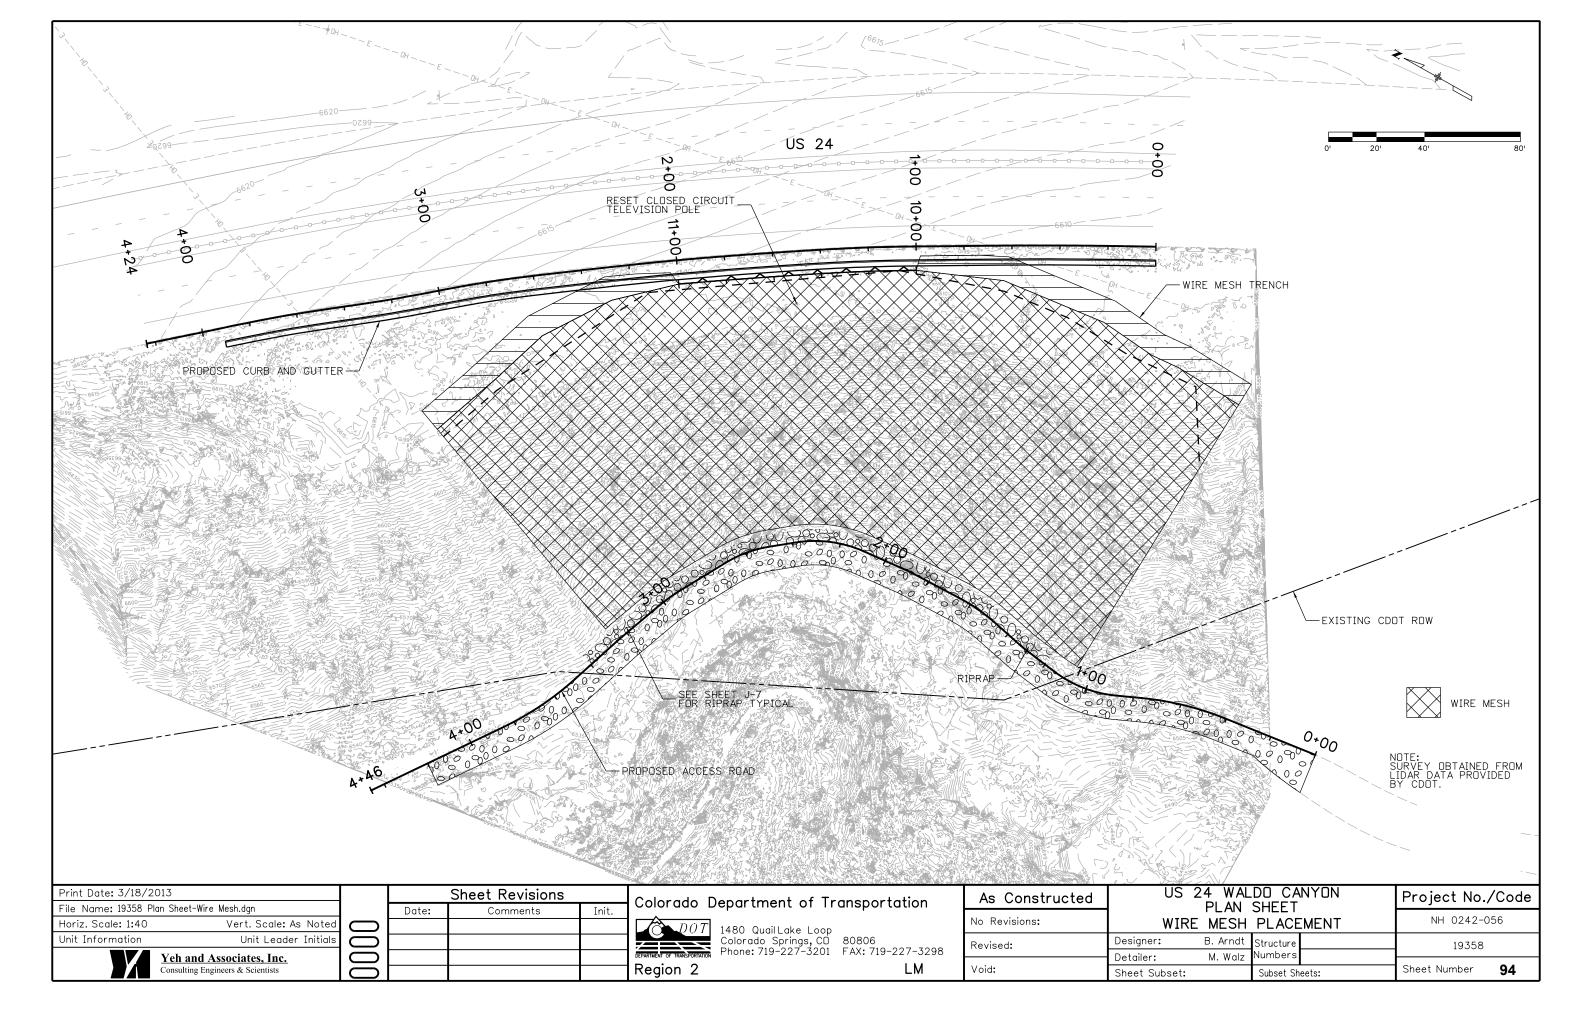


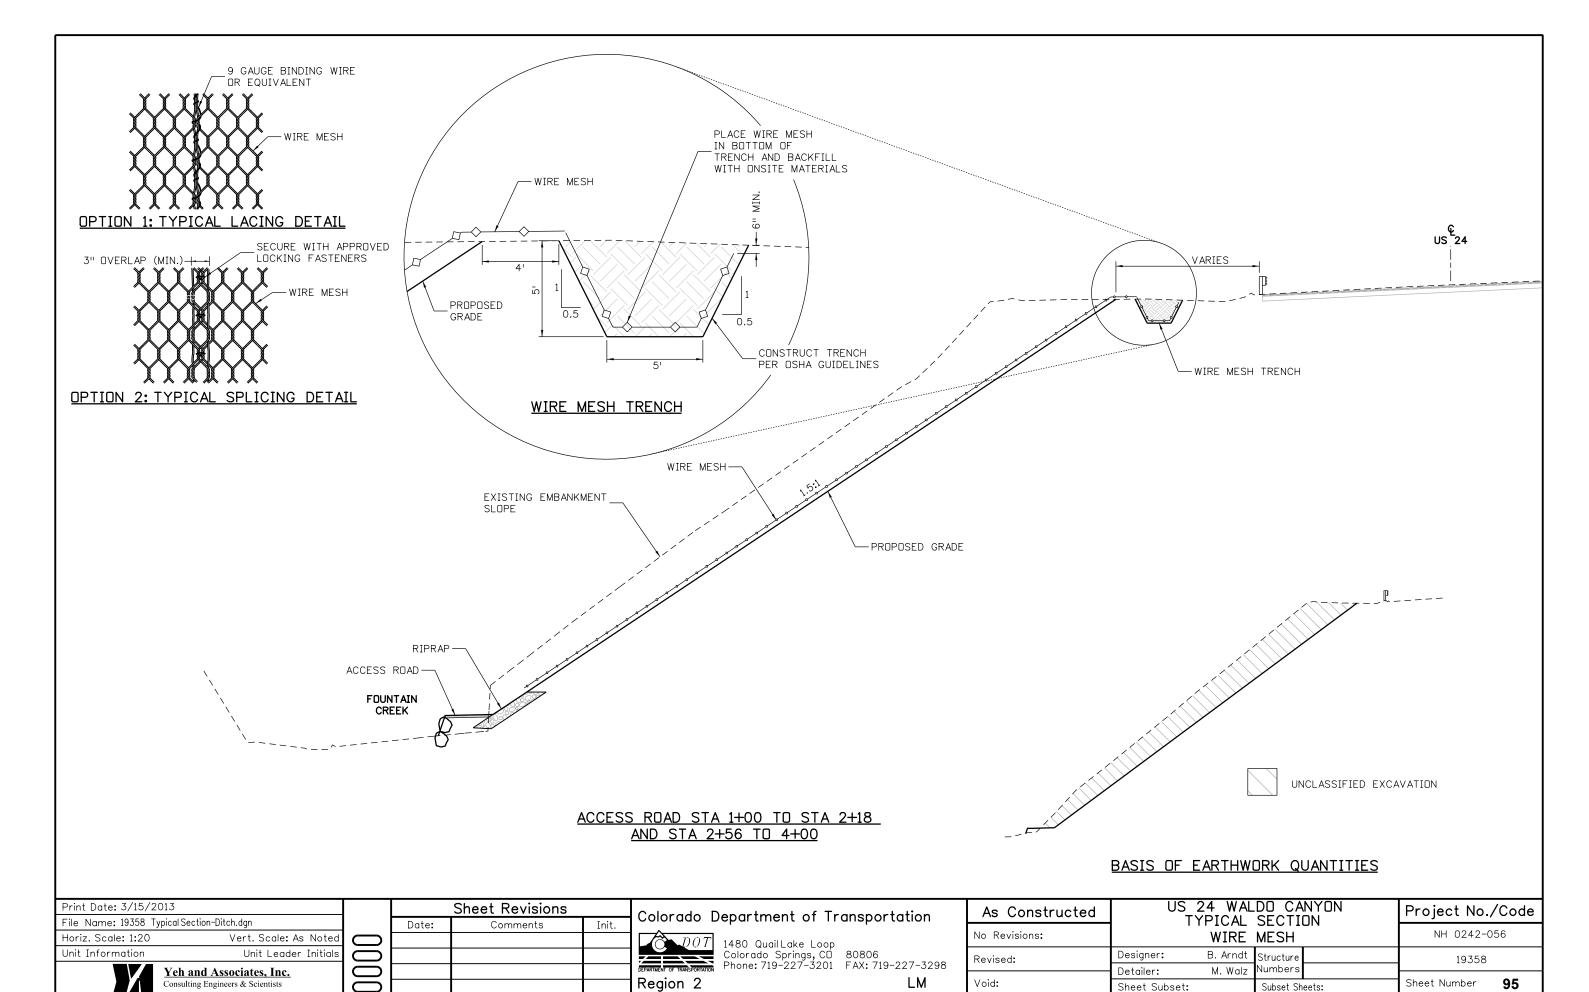

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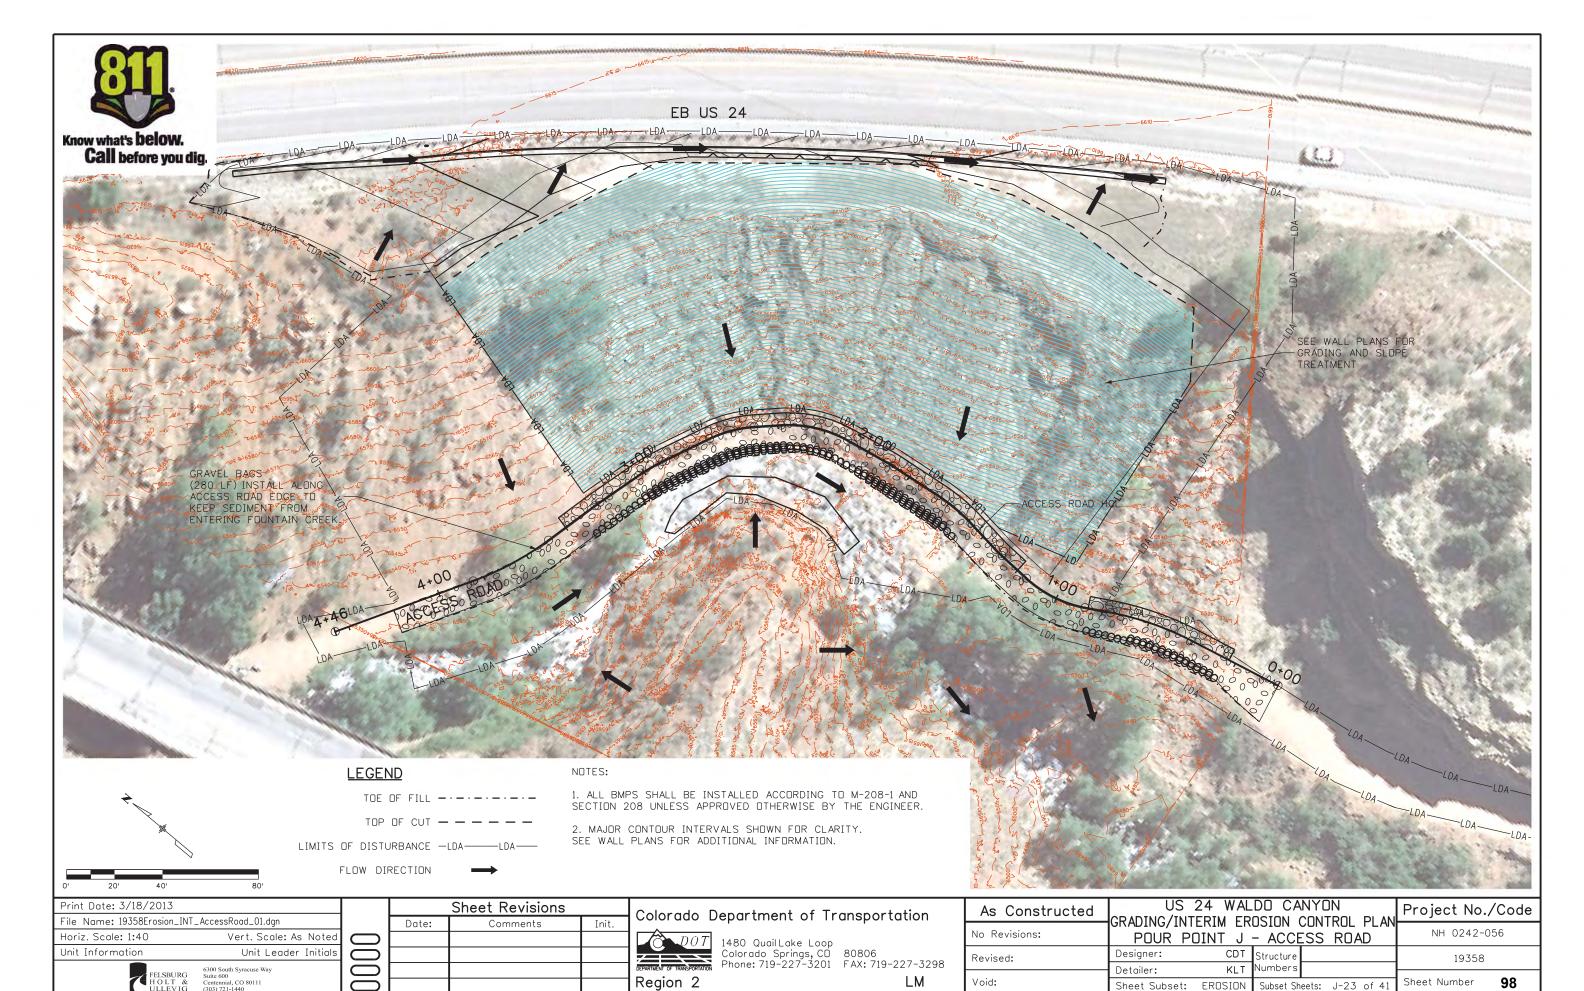
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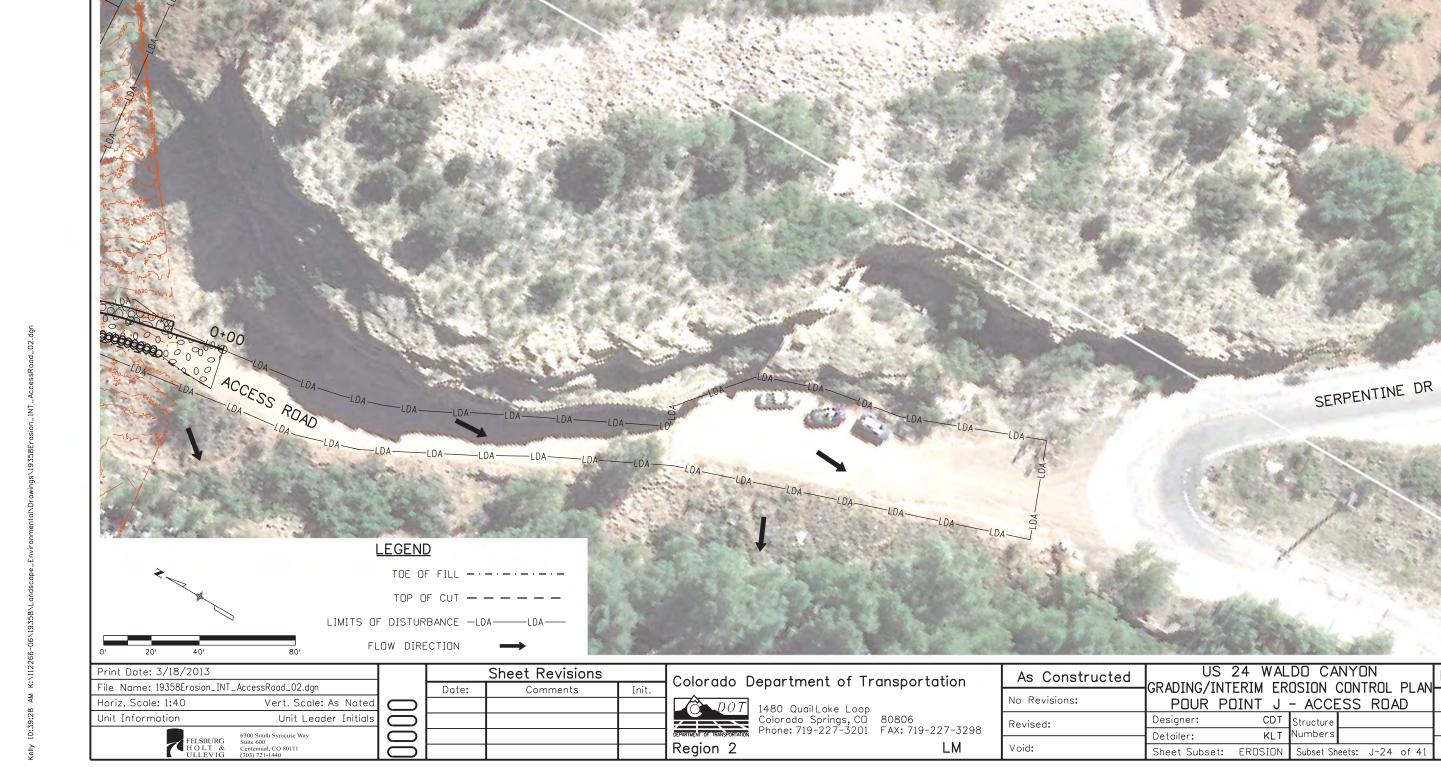
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EB US 24

NOTES:

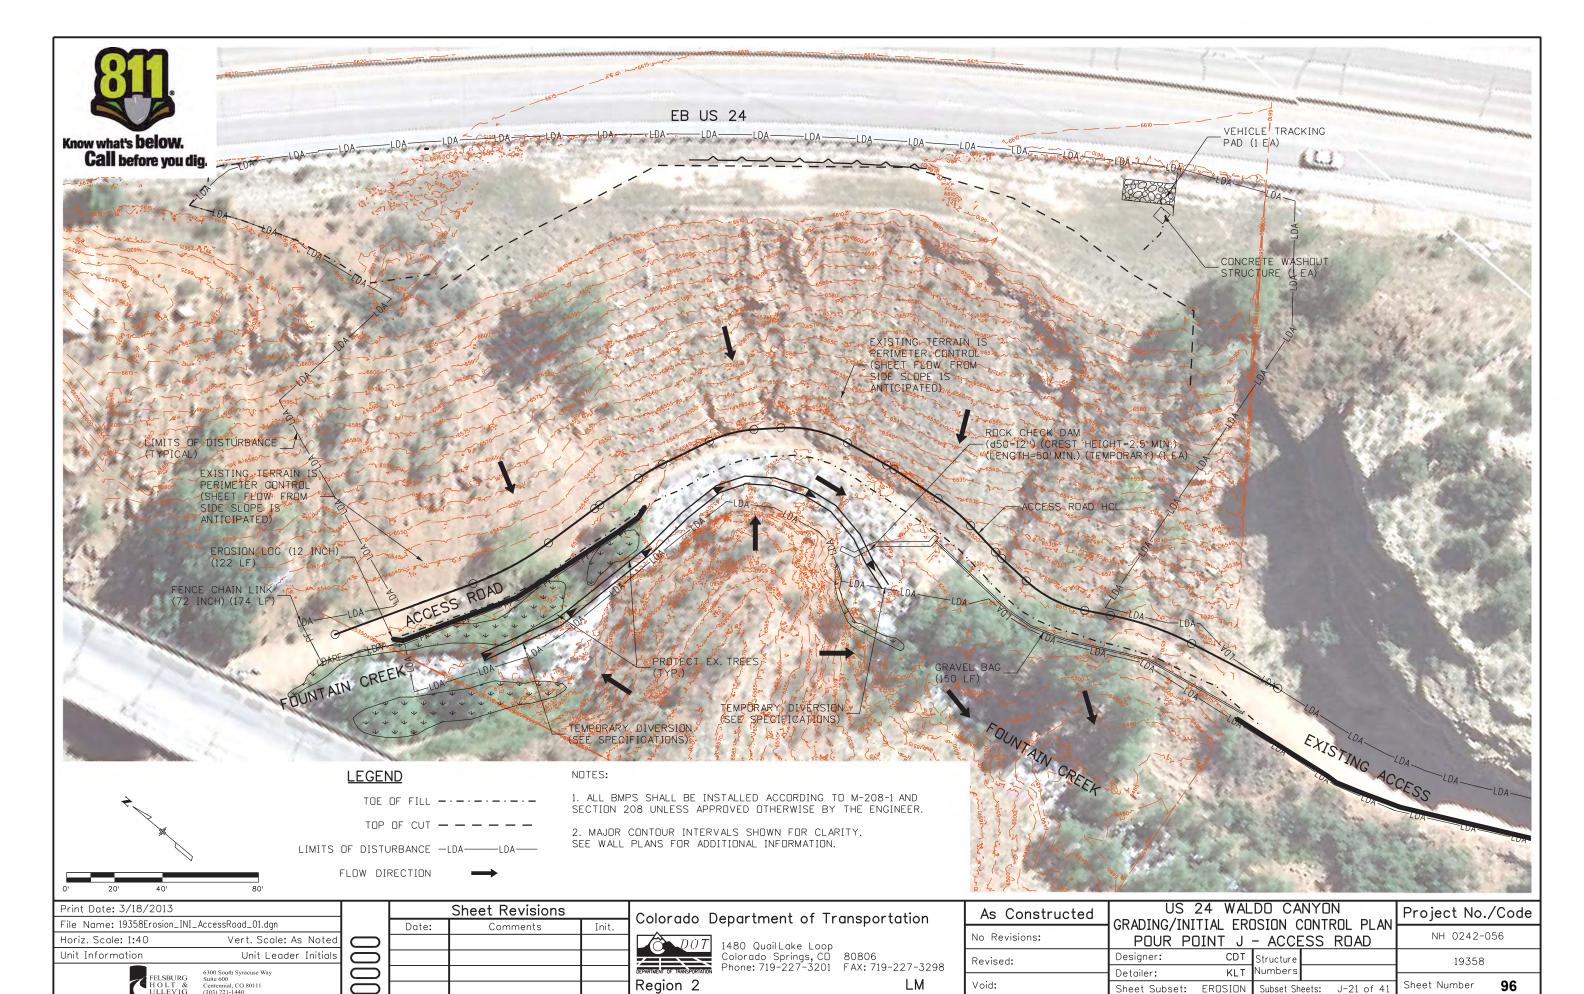1. ALL BMPS SHALL BE INSTALLED ACCORDING TO M-208-1 AND SECTION 208 UNLESS APPROVED OTHERWISE BY THE ENGINEER.
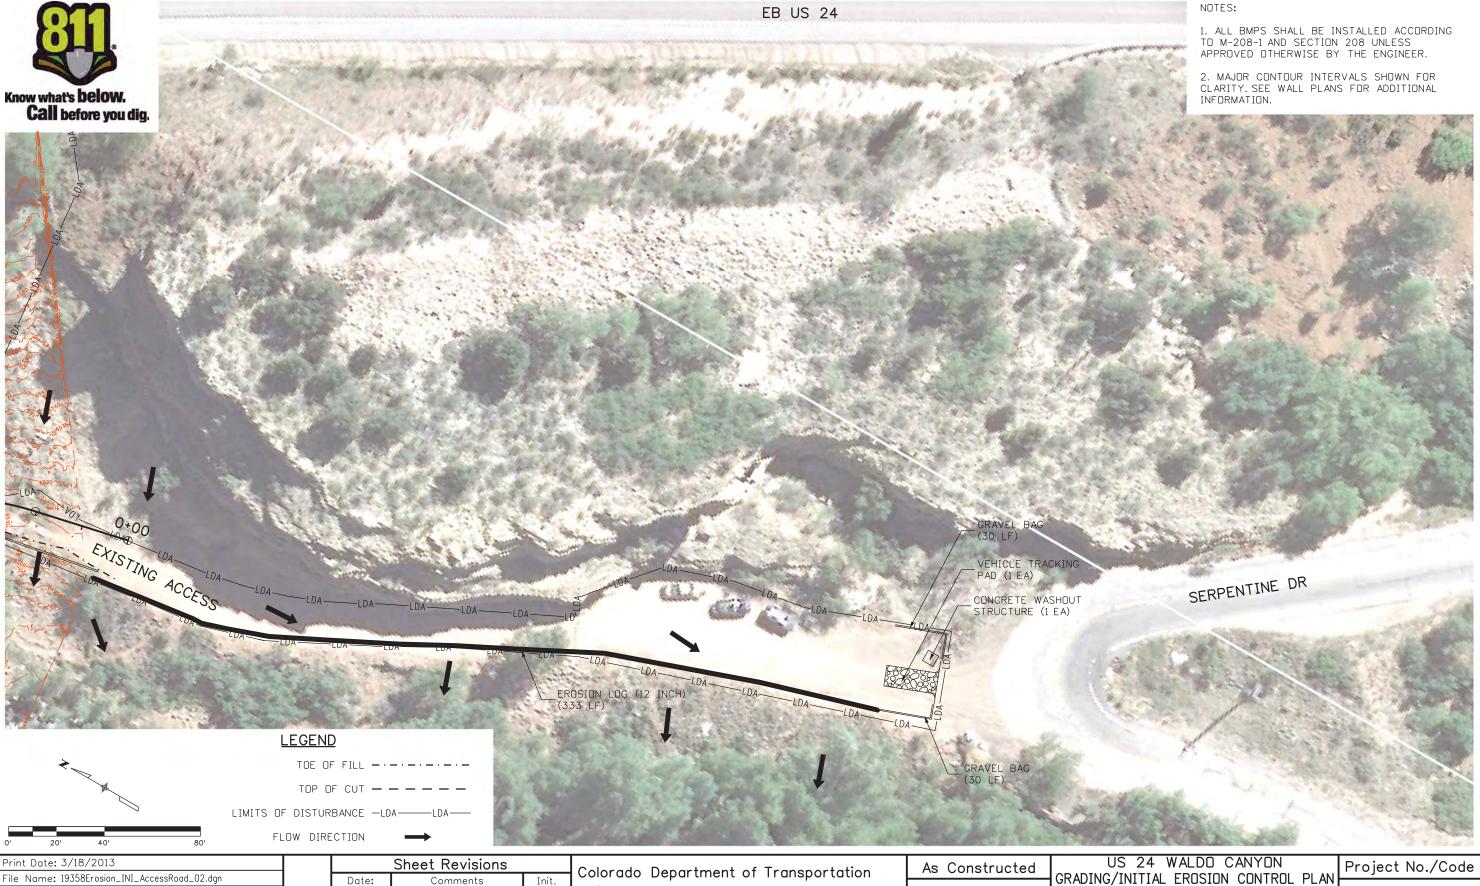
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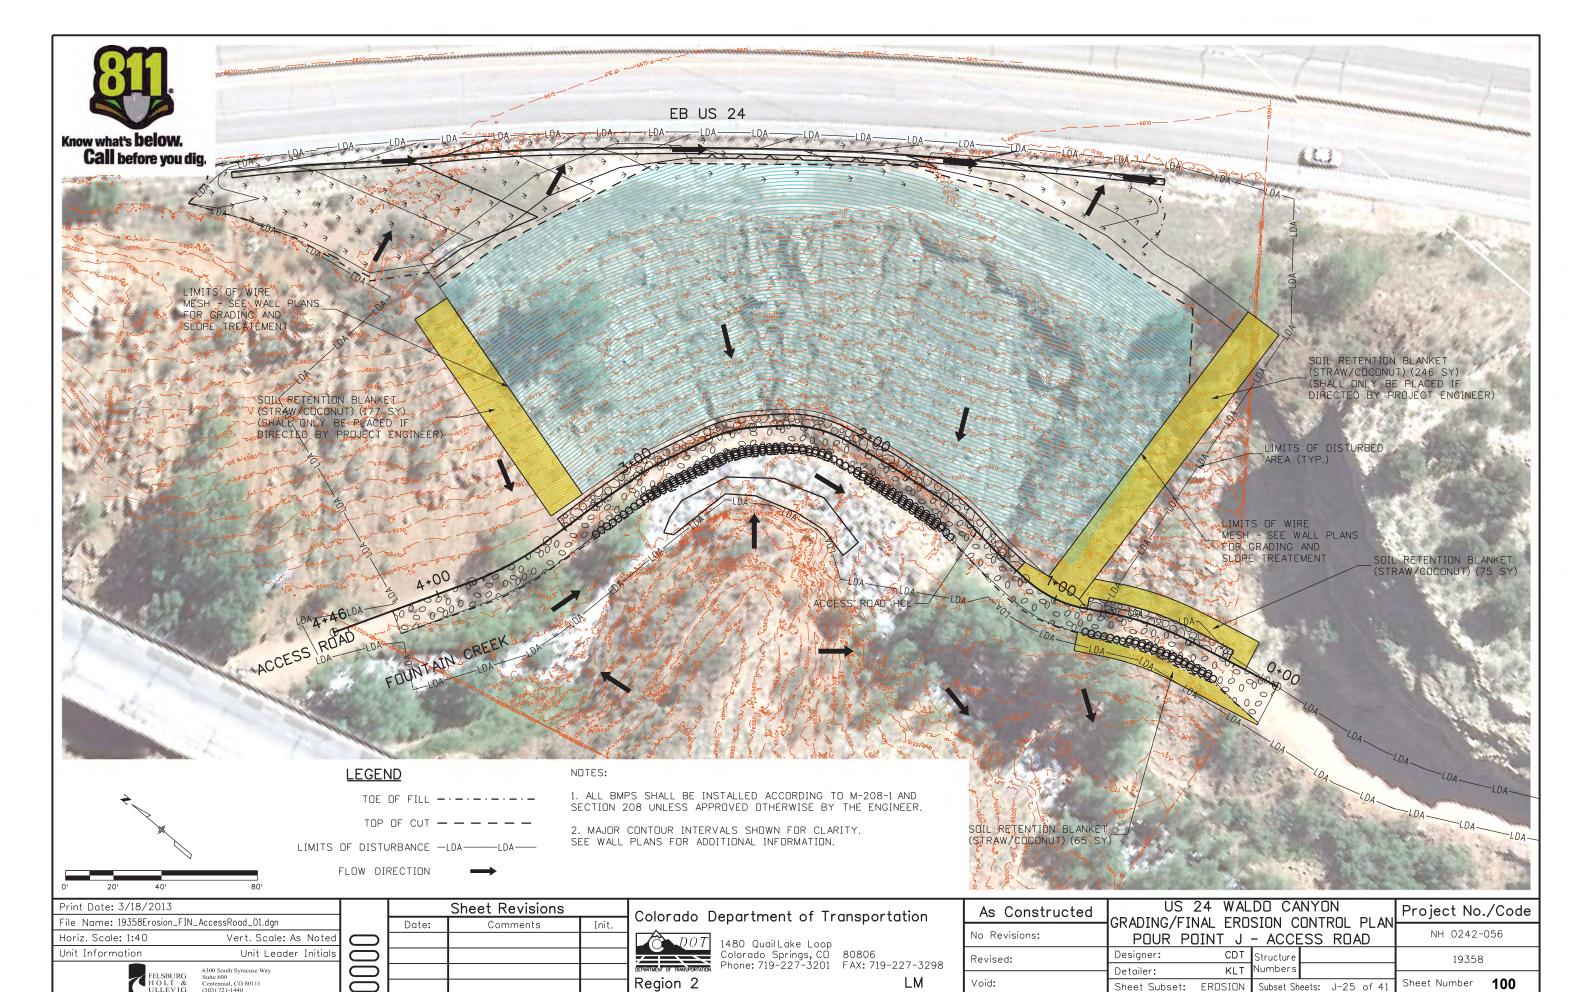
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2. MAJOR CONTOUR INTERVALS SHOWN FOR CLARITY. SEE WALL PLANS FOR ADDITIONAL INFORMATION.


Know what's **below**. Call before you dig.



Know what's **below**.

Call before you dig.

EB US 24

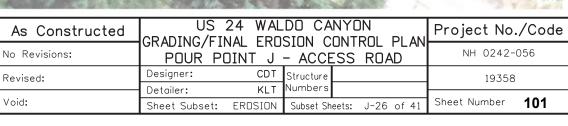


NOTES:


INFORMATION.

1. ALL BMPS SHALL BE INSTALLED ACCORDING TO M-208-1 AND SECTION 208 UNLESS APPROVED OTHERWISE BY THE ENGINEER.

2. MAJOR CONTOUR INTERVALS SHOWN FOR CLARITY. SEE WALL PLANS FOR ADDITIONAL

SERPENTINE DR

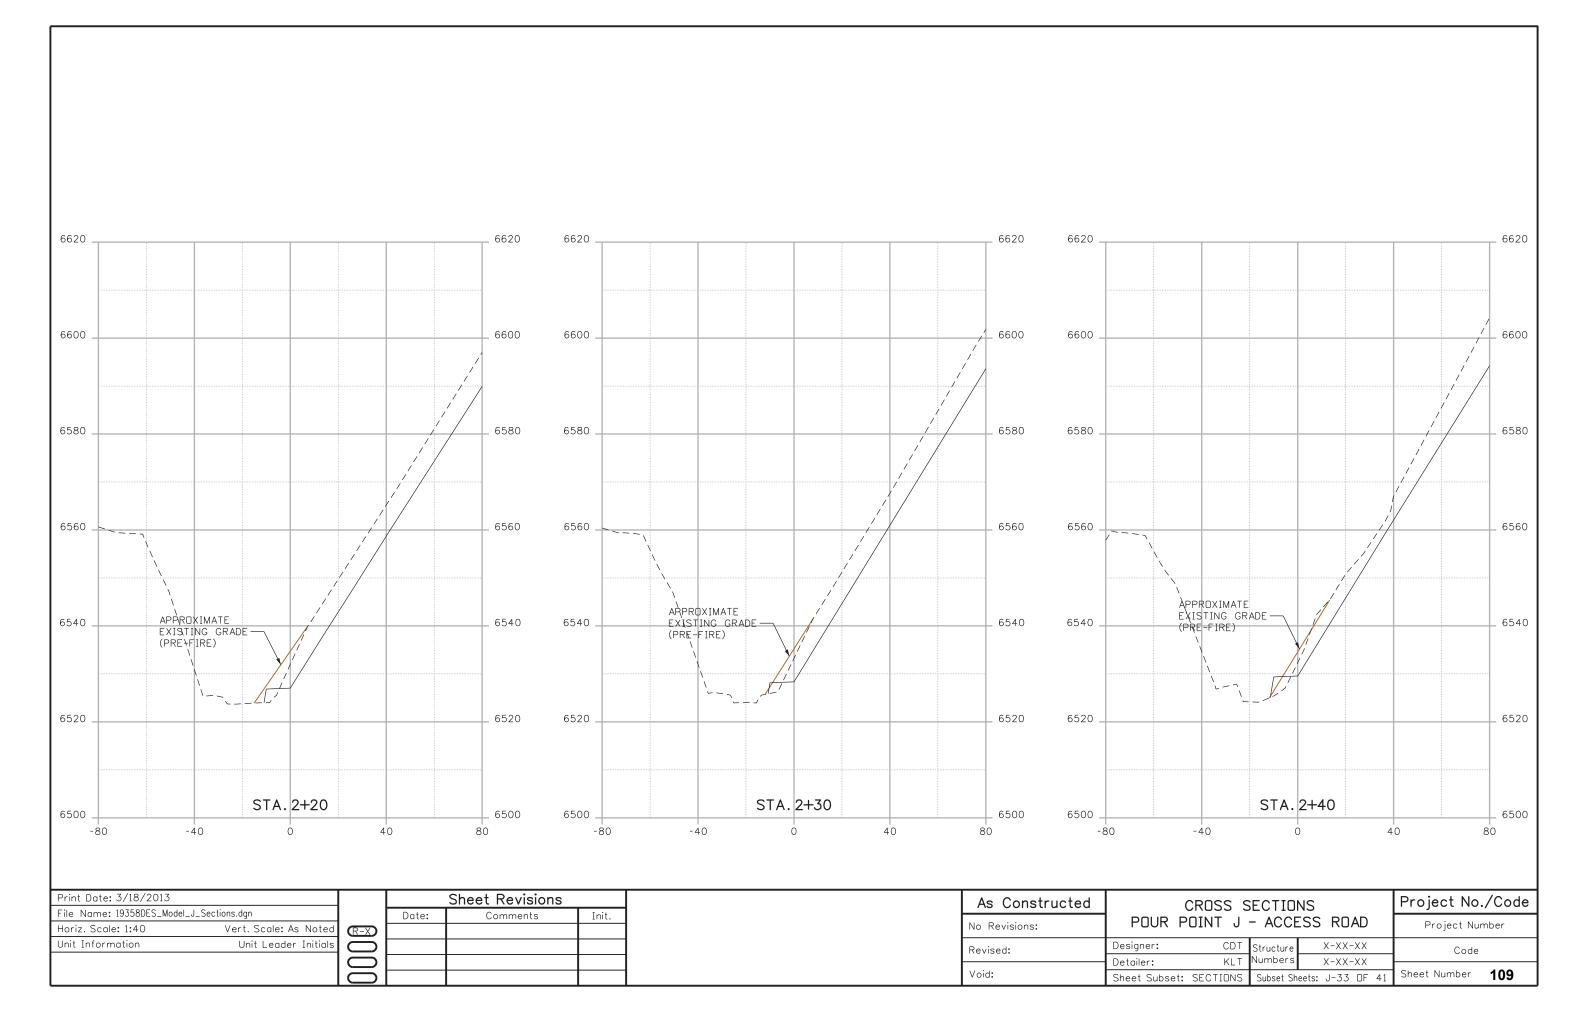

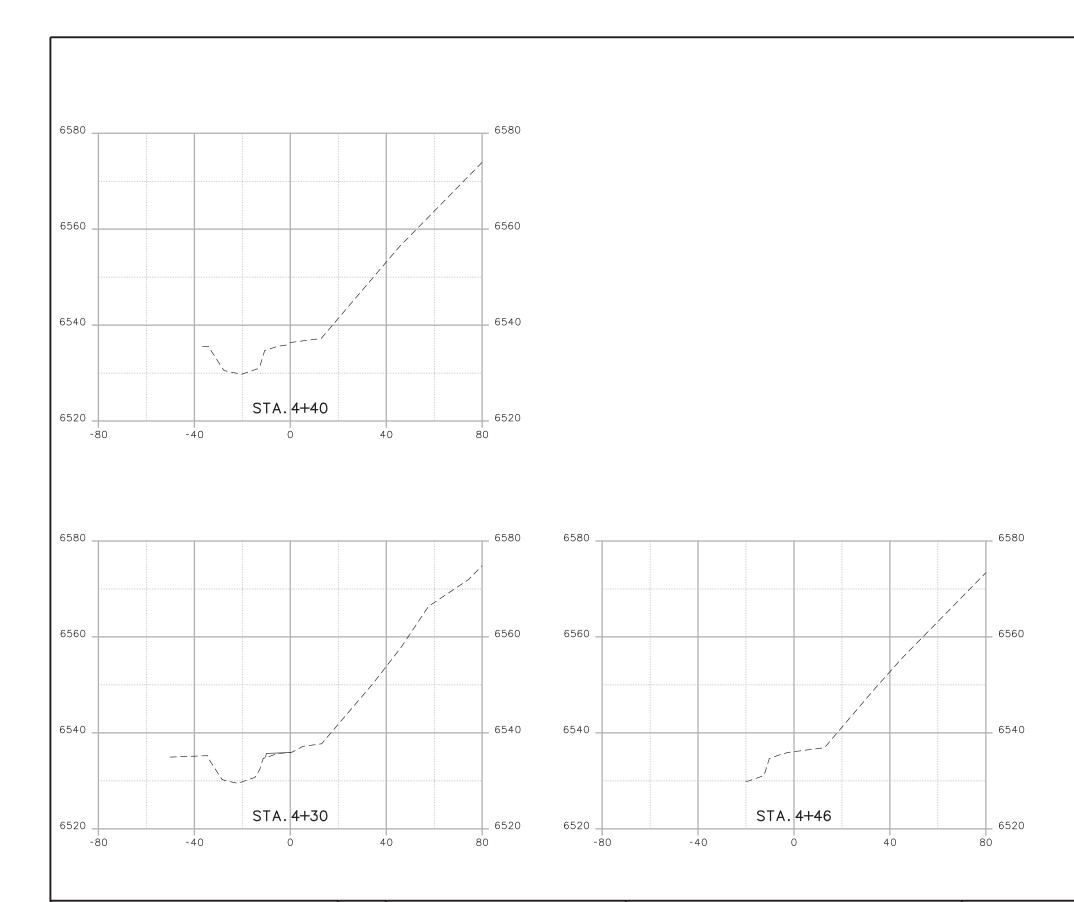

Scale: 1:40 Vert. Scale: As Noted Formation Unit Leader Initials Opening Pour Pour Pour Pour Pour Pour Pour Pour	me: 19358DES_Model_J_Sections.dgn Scale: 1:40	ate: 3/18/2013	l '		Sheet Revisions	
t Information Unit Leader Initials Revised: Designer: CDT	t Information Unit Leader Initials Designer: CDT Revised: Detailer: KLT	Name: 19358DES_Model_J_Sections.dgn	<i>i</i> '	Date:	Comments	Init.
Unit Information Unit Leader Initials Designer: CDT	Unit Information Unit Leader Initials Designer: CDT Revised: Designer: CDT Detailer: KLT	Horiz. Scale: 1:40 Vert. Scale: As Noted	(R-X)			
	Detailer: KLT					1
	O Detailer. Net	-				1

Project No./Code

Project Number

Code

Sheet Number 116

Phone: (719) 546-5496 FAX: (719) 546-5414

Right of Way Plans Unit: 2152

Sheet Revisions Sheet Revisions Sheet Revisions

COLORADO DEPARTMENT OF TRANSPORTATION Control Diagram Sheet

Project Number: 14173 Project Location: U.S. Hwy. 24

 Project Location:
 Manitou to Cascade

 Project Code:
 Last Mod. Date
 Subset Sheets
 Sheet No.
 Total No. of Sheet


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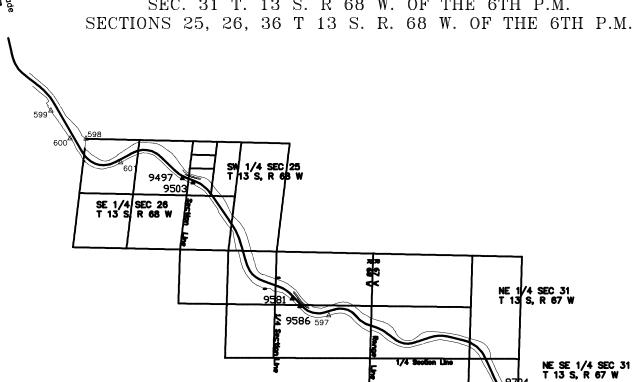
U.S. HIGHWAY 24

IN EL PASO COUNTY

SECTIONS 5, 6 T 14 S. R. 67 W. OF THE 6TH P.M. SEC. 31 T. 13 S. R 68 W. OF THE 6TH P.M.





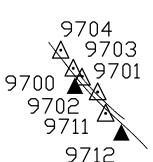

PROJECT COORDINATES

NAME	NORTHING	EASTING	ELEVATION	DESCRIPTION
9581 9712 9503 9700 9497 9586 CDNYERS QUILLEN 9711 9701 9702 9703	381949.066 378731.759 384884.427 379262.309 384994.933 381749.838 401915.887 374992.798 378855.569 379261.637 379096.042	158856.89 164906.292 156340.484 164380.867 156072.267 159044.454 141761.702 168814.069 164769.391 164679.488 164403.557	6992.634 6618.344 7146.085 6625.027 7157.701 6984.54 7924.853 6438.849 6622.303 6620.89 6606.506 6626.13	CDUT Control Monument, 3 1/2' Alum. Cap at M.P. 295.81 CDUT Control Monument, 3 1/2' Alum. Cap at M.P. 297.12 CDUT Control Monument, 3 1/2' Alum. Cap at M.P. 295.03 CDUT Control Monument, 3 1/2' Alum. Cap at M.P. 295.03 CDUT Control Monument, 3 1/2' Alum. Cap at M.P. 294.97 CDUT Control Monument, 3 1/2' Alum. Cap at M.P. 294.97 CDUT Control Monument at M.P. 290.2 NGS Control Monument at M.P. 298.15 CDUT Secondary Control, nall/shiner

[Project Cooordinates (ft) + (northing (1,000,000) or easting (3,000,000) reduction)] x (combined scale factor (0.9996090023) = State Plane Coordinates (ft) (Central Zone - 0502 NAD83)].

QUILLEN A

NE SE 1/4 SEC 31 T 13 S, R 67 W

GEODETIC COORDINATES

NAME	LATITUDE NAD-83	LONGITUDE NAD-83	ELLIPSOID HEIGHT (M)	CONVERGANCE	SCALE FACTOR	NORTHING CO SPC (FT)	EASTING CO SPC (FT)	ORTHO HEIGHT (FT)	NAME	DESCRIPTION
QUILLEN	38ø 51' 36.05163" N	104ø 54' 41.39062" W	1946.554	0ø 22' 16.18481"	0.999944710	1374992.798	3168814.069	6438.849	QUILLEN	NGS CONTROL MONUMENT
9712	38ø 52′ 13.24263 ′ N	104ø 55′ 30.47601″ W	2001.412	0ø 21'45.22716"	0.999943972	1378731.759	3164906.292	6618.343	9712	CDOT TYPE 2 CONTROL MONUMENT
9700	38ø 52′ 18.51767″ N	104ø 55′ 37.07471 ″ W	2003.467	0ø 21'41.06543"	0.999943870	1379262.309	3164380.868	6625.026	9700	CDOT TYPE 2 CONTROL MONUMENT
9586	38ø 52′ 43,42352 ′ N	104ø 56′ 44.33287°W	2113.228	0ø 20' 58.64642"	0.999943397	1381749.838	3159044.455	6984.540	9586	CDOT TYPE 2 CONTROL MONUMENT
9581	38ø 52' 45,40335' N	104ø 56' 46,68849"W	2115.701	0ø 20° 57.16075"	0.999943360	1381949.066	3158856.890	6992.634	9581	CDOT TYPE 2 CONTROL MONUMENT
9503	38ø 53' 14,55730' N	104ø 57' 18.27559" W	2162.559	0ø 20' 37.23910"	0.999942826	1384884.427	3156340.484	7146.085	9503	CDOT TYPE 2 CONTROL MONUMENT
9497	38ø 53' 15,66506' N	104ø 57' 21.65813" W	2166.109	0ø 20° 35.10576"	0.999942806	1384994.933	3156072.267	7157,702	9497	CDOT TYPE 2 CONTROL MONUMENT
CUNYERS	38ø 56′ 03.66464″ N	105ø 00' 21.41541' W	2400.355	0ø 18' 41.73472"	0.999940120	1401915.887	3141761.702	7924.900	CONYERS	NGS CONTROL MONUMENT

GENERAL NOTES

- 1.) This Control Survey Diagram is for the use of the Colorado Department of Transportation. This survey is NOT a complete Land or Right of Way survey, nor is the Control Diagram Sheet a Land or Right of Way Survey Plat.
- 2.) The Control Survey represented by this Control Survey Diagram meets Colorado Department of Transportation minimum horizontal control tolerances for a Type B Survey (+/- 0.25° at a 95% level of certainty).
- 3.) All coordinates listed are based on G.P.S. observations taken in October of 2002.
- 4.) No guarantee as to the accuracy of the information contained hereon is implied or expressed unless this copy bears an original signature and seal of the Professional Land Surveyor certifying this Survey Control

NOTICE: According to Colorado Law you must commence any legal action based upon any defect in this survey within three years after you first discover such defect. In no event may any action based upon any defect in this survey be commenced more than ten years from the date of the certification shown hereon.

BASIS OF BEARING

The basis of bearing for project reference is a line from CDOT Control Monument 9581 to CDOT Control Monument 9586 having a bearing of S 43° 16' 22" E at a distance of 273.63 feet.

SURVEY SYMBOL TABLE

Control Monument / Project

Secondary Monument / Project

SURVEYOR CERTIFICATE

I hereby state that this survey was performed under my supervision and checking, for and on the behalf of the Colorado Department of Transportation, and to the best of my knowledge, the information presented hereon is true and correct.

DAT	E

P.O. Box 536 905 Erie Avenue Pueblo, CO 81002 Phone: 719-546-5438 FAX: 719-54	Colorado Dep	artment of Tran	sportation
Pagian 2	DOT DEPARTMENT OF TRANSPORTATION	905 Erie Avenue Pueblo, CD 81002	FAX: 719-546-
Negion 2	Region 2		TTA

P.O. Box 536 905 Erie Avenue Pueblo, CD 81002 Phone: 719-546-5438 FAX: 719-546-5702

QUARTER, SIXTEENTH,

AND SECTION CORNERS

BENCH MARK

1

RIGHT OF WAY

QUARTER, SIXTEENTH, AND SECTION CORNERS

O USGS

USGS MARKER

⊡

ROW

MARKER

RIGHT OF WAY

●N 10.38 E 3.81 EL 0.00

HIGH ACCURACY REFERENCE

NETWORK CONTROL MONUMENT

MARKER

SECTION CORNER

PROPERTY PIN

⊙ wc

SET FASEMENT

MONUMEN1

⊖ FED

FEDERAL MONUMENT

LOCAL OR PLSS

MONUMENT

PROJECT CONTROL

ACCESS CONTROL LINE

RIGHT OF WAY LINE

BARRIER ACCESS CONTROL LINE

CITY LIMIT LINE (EXISTING)

COUNTY LINE (EXISTING)

QUARTER SECTION LINE

SIXTEENTH SECTION LINE

TOWNSHIP LINE (EXISTING)

STATE LINE (EXISTING)

SECTION LINE

TOP OF CUT

TOE OF FILL

VIRGIN RIGHT OF WAY LINE (PROPOSED)

MONUMENT

▲ N 9.88 E 3.81 EL 0.00

BLM MARKER

1

TEMPORARY

EASEMENT POINT

WC

SECONDARY CONTROL

SURVEY/ROW

TERRAIN

MONUMENT

WITNESS CORNER

N 10.13
 E 3.81
 EL 0.00

DENSIFICATION

PERMANENT, PROPERTY, SLOPE, & UTILITY EASEMENT LINE

—P ——

PROPERTY BOUNDARY LINE (EXISTING AND PROPOSED)

TEMPORARY EASEMENT LINE (EXISTING)

CONTROL MONUMENT

O NOAA

NOAA MARKER

TTA

Sheet Revisions Sheet Revisions

Sheet Revisions Farnsworth LORADO SPRINGS, COLORADO 80 19) 590-9194 / (719) 590-9111 Fa

EA-4


EA-5

	RI RI	<u>.GHIUFWA</u>	<u>Y</u>					
Title Sheet								
roject Number: NH 0242-056								
Project Location: U.S. 24 Fire Mitigation - Cascade								
EL PASO COUNTY, COLORADO								
oject Code:	Last Mod. Date	Subset	Sheet No.	Sheet Total				
19358	03-06-13	1.00 of 1.00	1.00	13				

DEPARTMENT OF TRANSPORTATION STATE OF COLORADO

RIGHT OF WAY PLANS OF PROPOSED PROJECT NO. NH 0242-56 STATE HIGHWAY NO. 24 EL PASO COUNTY

Lineal Units = U.S. Survey Feet

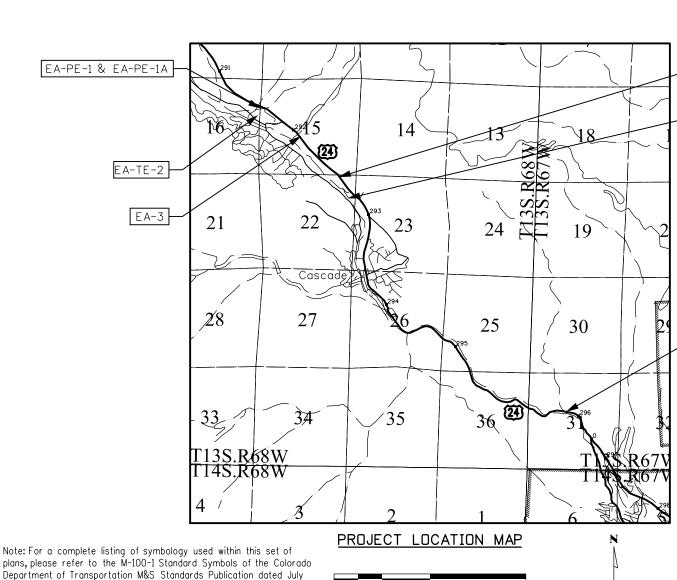

2006. Existing features are shown as screened weight (gray scale), except as noted with the word (existing). Proposed or new features

are shown as full weight without screening, except as noted with the

word (proposed).

SHEET NO. INDEX OF SHEETS

Title Sheet 1.01-1.02 (2) Exhibit EA-PE-1 & EA-PE-1A 2.01-2.02 (2) Exhibit EA-TE-2 3.01-3.02 (2) Exhibit EA-3 4.01-4.02 (2) Exhibit EA-4 5.01-5.02 (2) Exhibit EA-5 6.01-6.02 (2) Exhibit EA-PE-6 & EA-TE-6

(13) Total Sheets

Scales of Original 11x17 Drawings Plan Sheets 1"=100" Ownership Map 1"=1000"

Basis of Bearings: Bearings are Colorado State Plane, Central Zone, NAD 83/92, based on a line between NGS station "CONYERS" PID - JK1354, a steelrod encased in PVC with NGS logo cap set in 1.6' concrete post near mile post 290.2, and NGS station "QUILLEN" PID - JK1385, a drill hole in sandstone near mile post 298.15. Said line bears S45°08'14"E per CDOT control diagram for project number 14173.See www.ngs.noaa.gov for data sheets containing detailed location information

- 1. This Right-of-Way Plan is not a boundary survey of the adjoining property and is prepared for the Colorado Department of Transportation purposes only.
- 2. For title information, The Colorado Department of Transportation relied on Title Commitments prepared by H. C. Peck & Associates.
- 3. This plan set is subject to change and may not be the most current set. It is the user's responsibility to verify with CDOT that this set is the most current. The information contained on the attached drawing is not valid unless this copy bears an original signature of the Professional Land Surveyor hereon named.

NOTICE: According to Colorado law you must commence any legal action based upon any defect in this survey within three years after you first discover such defect. In no event may any action based upon any defect in this survey be commenced more than ten years from the date of the certification shown hereon.



SURVEYOR STATEMENT (R.O.W. MONUMENTS)

Fredrick L. Easton , a professional land surveyor licensed in the State of Colorado, do hereby state to the Colorado Department of Transportation that based upon my knowledge, information and belief, adequate research, calculations and evaluation of survey evidence were performed and the Right-of-Way monuments depicted on this Right-of-Way Plan were set under my responsible charge in accordance with applicable standards of practice defined by Colorado Department of Transportation publications. This statement is not a guaranty or warranty, either expressed or implied.

PLS No. 37948

EA-PE-6 & EA-TE-6

ORADO LICENS 1 PROPERTY ON ALL LANDS

DAY OF . . . 20_____ OF THE COUNTY LAND SI______ . RECEPTION NU FILING CERTIFICATION:
DEPOSITED THIS ____
IN BOOK ______ C
SURVEYS AT PAGE ____

_	nom
	DOT

P.O. Box 536 905 Erie Avenue Pueblo, CO 81002 Phone: 719-546-5438 FAX: 719-546-5702

Sheet Revisions			Sheet Revisions
Description	Initials	Date	Description

Sheet Revisions			
Description	Initials	Farnsworth	
		Farnsworth GROUP	F
		4755 FORGE ROAD, SUITE 150	F
		COLORADO SPRINGS, COLORADO 80907 (719) 590-9194 / (719) 590-9111 Fax	Г

RIGHT OF WAY

EXHIBIT EA-PE-1 & EA-PE-1A


Project Number: NH 0242-056

Project Location: U.S. 24 Fire Mitigation - Cascade

EL PASO COUNTY, COLORADO

Project Code: Last Mod. Date Subset Sheet No. Sheet Total

Region 2

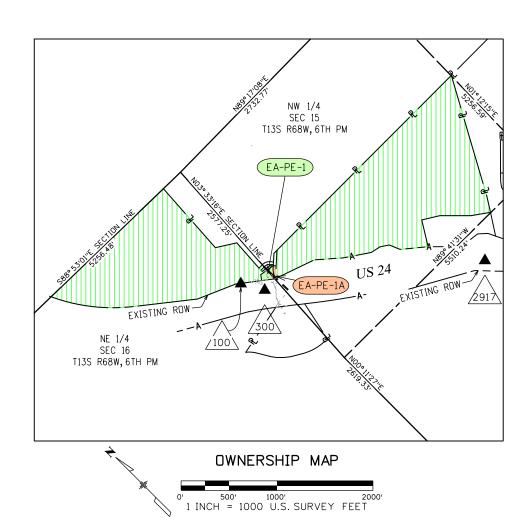

	PROJECT CONTROL TABLE											
Point No. Project Coordinates		Elev(ft)										
Point No.	Northing(ft)	Easting(ft)	(NAVD88)	Description								
100	397916.25	145713.32	7654.78	18" #5 REBAR W/RPC "FARNSWORTH CONTROL POINT"								
300	397692.95	145841.94	7650.50	MAG. NAIL IN ASPHALT SHOULDER OF HWY 24								
2917	147683.17	396289.12	7477.22	C.D.O.H. C.M. M.P. 291.7								
CONYERS	401915.89	141761.70	7924.85	SMOOTH STEEL ROD IN LOGO BOX 'CONYERS 1991'								
QUILLEN	374992.80	168814.07	6438.85	3 25IN DIA BRASS CAP IN STONE OURCROPING 'QUILLEN 1992'								

SECTIONS 15 & 16 T13S, R68W, 6TH PM EL PASO COUNTY, CO

General Notes:

- 1. This Right-of-Way Exhibit is not a complete boundary survey of all adjoining owners and is prepared for the Colorado Department of Transportation purposes only.
- 2. Notice: According to Colorado law, you must commence any legal action based upon any defect in this survey within three years after you first discover such defect. In no event may any action based upon such defect in this survey be commenced more than ten years from the date of certification hereon.
- 3. Existing right-of-way lines were established using CDDT Project No. F024-2(1) Sec. 1 Right-of-Way Plans. Aliquot section corners and lines are per CDDT Control Diagram Sheet for Project CX 04-0024-45.
- 4. For title information Farnsworth Group, Inc. relied on title commitments prepared by H. C. Peck and Associates.

CODRDINATE DATUM: Project coordinates are modified Colorado State Plane Central Zone NAD '83/(92) coordinates. The combined elevation/scale factor used to modify the coordinates from state plane to project coordinates is 1.0003911506. The resulting project coordinates are truncated by 3,000,000sft in the Northing and 1,000,000sft in the Easting after converting from state plane coordinates to project coordinates. The CHARN is based on the NAD '83(92) datum.

Project Coordinates Northing US Survey Feet = (State Plane Coordinate Northing * 1.0003911506 - 3,000,000) * (3937/1200).

Project Coordinates Easting US Survey Feet = (State Plane Coordinate Easting * 1.0003911506 - 1,000,000) * (3937/1200).

Basis of Elevations: Project elevations are based on NAVD 88 values published on the CDDT Control Diagram Sheet, Project No. 141173, dated Feb 19, 2003.

PROPERTY ONLL LAND SHE

	R.O.W. TABULATION OF PROPERTIES IN EL PASO COUNTY - U.S. NO. 24										
				The second	Area I	n Square Fee	et (Acres)		Book and Page No. And/Or	Title Commitment	Remarks
Parcel No.	Ownership Name and Mailing Address	Site Address	Location T-13-S R-68-W, 6TH PM	Area Of Parcel	Existing ROW	Net Area	Remainder Left	Remainder Right	Reception No.	No.	
EA-PE-1	TWIN ROCKS INVESTMENT GROUP, LLC,		SECTIONS 15 & 16	13,552 SQ FT				337,324 SQ FT		05490A2013	for the purpose of construction and
	A COLORADO LIMITED LIABILITY COMPANY			(0.311 AC)			-	(77.439 AC)	The state of		maintenance of drainage structures
EA-PE-1A	6225 WELLINGTON GULCH		SECTION 15	3,910 SQFT				346966 SQ FT	1	1	for ingress and egress
	CASCADE, CO 80809			(0.090 AC)				(77.660 AC)			

Region 2


P.O. Box 536 905 Erie Avenue Pueblo, CD 81002 Phone: 719-546-5438 FAX: 719-546-5702

	Sheet Revisions			Sheet Revisions			Sheet Revisions
е	Description	Initials	Date	Description	Initials	Date	Description
5-13	Revised Design References	SDP					

Farnsworth 55 FORGE ROAD, SUITE 150 DLORADO SPRINGS, COLORADO 80º

RIGHT OF WAY EXHIBIT EA-PE-1 & AE-PE-1A Project Number: NH 0242-056 Project Location: U.S. 24 Fire Mitigation - Cascade

EL PASO COUNTY, COLORADO 19) 590-9194 / (719) 590-9111 Fax

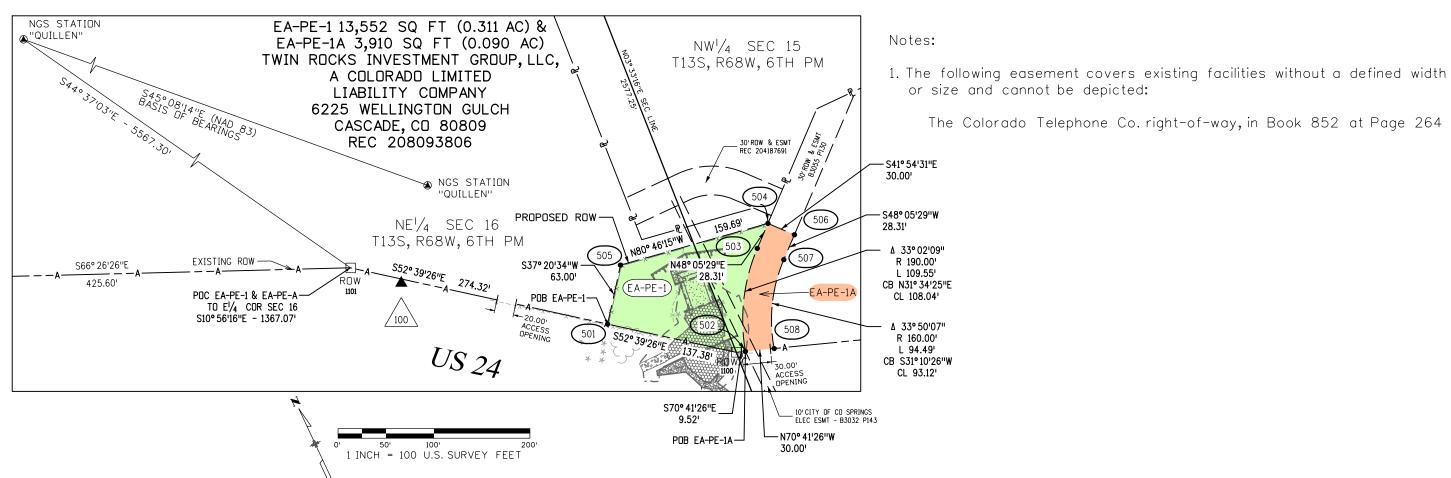

FOUND R.O.W. MONUMENT COORDINATE TABLE Easting(ft) Description

1.5" AL CAP - LS 12043

1.5" AL CAP - LS 12043

ROW

Point No.

1100

1101

Northing(ft)

397703.28

397952.90

TABULATION OF PERMANENT EASEMENT MONUMENTS TO BE SET					
Point No.	Northing(ft)	Easting(ft)	Description		
501	397786.62	145890.09	CDOT TYPE VI MONUMENT		
502	397700.14	146008.30	CDOT TYPE VI MONUMENT		
503	397792.18	146064.87	CDOT TYPE VI MONUMENT		
504	397811.09	146085.93	CDOT TYPE VI MONUMENT		
505	397836.70	145928.31	CDOT TYPE VI MONUMENT		
506	397788.77	146105.97	CDOT TYPE VI MONUMENT		
507	397769.86	146084.90	CDOT TYPE VI MONUMENT		
508	397690.18	146036.70	CDOT TYPE VI MONUMENT		

145999.32


145672.15

Basis of Bearings: Bearings are Colorado State Plane, Central Zone, NAD 83/92, based on a line between NGS station "CONYERS" PID - JK1354, a steelrod encased in PVC with NGS logo cap set in 1.6' concrete post near mile post 290.2, and NGS station "QUILLEN" PID - JK1385, a drill hole in sandstone near mile post 298.15. Said line bears \$45° 08'14"E per CDOT control diagram for project number 14173.

See www.ngs.noaa.gov for data sheets containing detailed location information.

SURVEYOR STATEMENT (R.O.W. MONUMENTS)

Fredrick L. Easton , a professional land surveyor licensed in the State of Colorado, do hereby state to the Colorado Department of Transportation that based upon my knowledge, information and belief, adequate research, calculations and evaluation of survey evidence were performed and the Right-of-Way monuments depicted on this Right-of-Way Plan were set under my responsible charge in accordance with applicable standards of practice defined by Colorado Department of Transportation publications. This statement is not a quaranty or warranty, either expressed or implied.

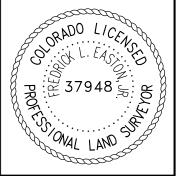

DOT

P.O. Box 536 905 Erie Avenue Pueblo, CO 81002 Phone: 719-546-5438 FAX: 719-546-5702

	Sheet Revisions			Sheet Revisions	
?	Description	Initials	Date	Description	Initials
		_			-
					-

Sheet Revisions

Description Initials

Farnsworth

GROUP


COLORADO SPRINGS, COLORADO 80907

19) 590-9194 / (719) 590-9111 Fa

Project Code: Lost Mod. Date

Projec

Region 2

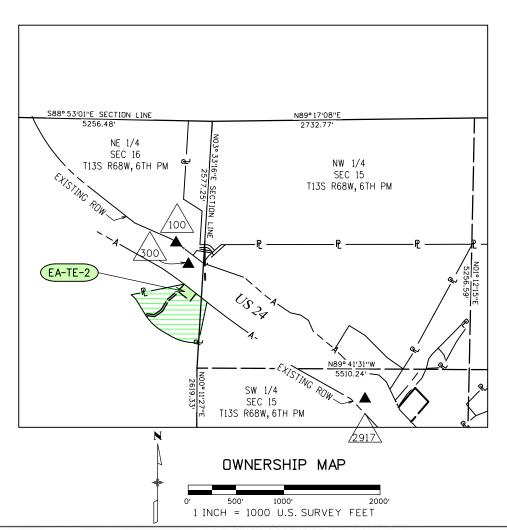

	PROJECT CONTROL TABLE						
Point No.	Project Coordinates		Elev(ft)				
	Northing(ft)	Easting(ft)	(NAVD88)	Description			
100	397916.25	145713.32	7654.78	18" #5 REBAR W/RPC "FARNSWORTH CONTROL POINT"			
300	397692.95	145841.94	7650.50	MAG. NAIL IN ASPHALT SHOULDER OF HWY 24			
2917	147683.17	396289.12	7477.22	C.D.O.H. C.M. M.P. 291.7			
CONYERS	401915.89	141761.70	7924.85	SMOOTH STEEL ROD IN LOGO BOX'CONYERS 1991'			
QUILLEN	374992.80	168814.07	6438.85	3.25IN DIA BRASS CAP IN STONE OURCROPING 'QUILLEN 1992'			

SECTION 16 T13S, R68W, 6TH PM EL PASO COUNTY, CO

General Notes:

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- 3. Existing right-of-way lines were established using CDOT Project No. F024-2(1) Sec. 1 Right-of-Way Plans. Aliquot section corners and lines are per CDOT Control Diagram Sheet for Project CX 04-0024-45.
- 4. For owner information Farnsworth Group, Inc. relied on documents provided by H. C. Peck and Associates.

CODRDINATE DATUM: Project coordinates are modified Colorado State Plane Central Zone NAD '83/(92) coordinates. The combined elevation/scale factor used to modify the coordinates from state plane to project coordinates is 1.0003911506. The resulting project coordinates are truncated by 3,000,000sft in the Northing and 1,000,000sft in the Easting after converting from state plane coordinates to project coordinates. The CHARN is based on the NAD '83(92) datum.

Project Coordinates Northing US Survey Feet = (State Plane Coordinate Northing * 1.0003911506 - 3,000,000) * (3937/1200).

Project Coordinates Easting US Survey Feet = (State Plane Coordinate Easting * 1.0003911506 - 1,000,000) * (3937/1200).

Basis of Elevations: Project elevations are based on NAVD 88 values published on the CDOT Control Diagram Sheet, Project No. 141173, dated Feb 19, 2003.

R.O.W. TABULATION OF PROPERTIES IN EL PASO COUNTY - U.S. NO. 24 **Book and Page** Title Area In Square Feet (Acres) No. And/Or Commitment Remarks Ownership Name and Mailing Location Parcel No. Site Address Reception No. No. T-13-S R-68-W, 6TH PM Existing Remainder Remainder Address Net Area Area Of Parcel ROW Right Left SCHOOL DISTRICT NO 14 9230 CHIPITA PARK RD 25,163 SQ FT AE-TE-2 **SECTION 16** FOR CONSTRUCTION OF OUTLET PROTECTION 405 EL MONTE PL (05.578 AC) FOR EXISTING BOX CULVERT MANITOU SPRINGS, CO 80829-2502

3/6/2013 sparker 12:20:36 PM P:\2012\01214

DOT

P.O. Box 536 905 Erie Avenue Pueblo, CO 81002 Phone: 719-546-5438 FAX: 719-546-5702

	Sheet Revisions			Sheet Revisions		
)ate	Description	Initials	Date	Description	Initials	Г
-06-13	Revised Design Reference	SDP				

Sheet Revisions

Description

Initials

Sheets

GROUP

4755 FORGE ROAD, SUITE 150

COLORADO SPRINGS, COLORADO 80907
(7/19) 590-9194 / (7/19) 590-9111 Fox

RIGHT OF WAY

EXHIBIT EA-TE-2

Project Number: NH 0242-056


Project Location: U.S. 24 Fire Mitigation - Cascade

EL PASO COUNTY, COLORADO

Project Code: Last Mod. Date Subset Sheet No. Sheet Total

Region 2

	POI E!/4 C S08° 39'46"E	A 0° 21'32" R 5604.1' L 35.09' CB S52° 45'43"E CL 35.09' OR SEC 16 - 884.55' N40° 14'32"E 41.80' R 615	
N53° 32'35"E 24.09'	NE 1/4 SEC 16 T13S, R68W, 6TH PM N55° 23'24"E 87.98' 12'06'E 69.66'	605	602 602 8 AC)
A 2°14'41" R 511.15' L 20.02' CB N33° 40'48"W CL 20.02'	611 612 606 606 606 607 N81° 12′06″W 69.28″	405 EL MONTE P MANITOU SPRINGS, CO 808 REC 493165	

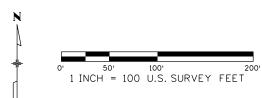

Basis of Bearings: Bearings are Colorado State Plane, Central Zone, NAD 83/92, based on a line between NGS station "CONYERS" PID - JK1354, a steelrod encased in PVC with NGS logo cap set in 1.6' concrete post near mile post 290.2, and NGS station "QUILLEN" PID - JK1385, a drill hole in sandstone near mile post 298.15. Said line bears S45° 08'14"E per CDOT control diagram for project number 14173. See www.ngs.noaa.gov for data sheets containing detailed location information.

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XXX	


Point No.	Northing(ft)	Easting(ft)	Description
601	397485.24	145798.17	
602	397388.69	145922.20	
603	397309.98	145860.52	
604	397402.57	145742.37	
605	397314.40	145638.71	
606	397203.03	145571.00	
607	397146.11	145488.53	
608	397156.71	145420.06	
609	397146.77	145406.61	
610	397163.43	145395.50	
611	397177.75	145414.88	
612	397167.09	145483.72	
613	397217.06	145556.13	
614	397327.54	145623.30	
615	397453.33	145771.17	

⊙ XXX

TABULATION OF Calculated Points						
Point No.	Northing(ft)	Easting(ft)	Description			
905	397464.00	145826.11				

SURVEYOR STATEMENT (R.O.W. MONUMENTS)

I, Fredrick L. Easton, a professional land surveyor licensed in the State of Colorado, do hereby state to the Colorado Department of Transportation that based upon my knowledge, information and belief, adequate research, calculations and evaluation of survey evidence were performed and the Right-of-Way monuments depicted on this Right-of-Way Plan were set under my responsible charge in accordance with applicable standards of practice defined by Colorado Department of Transportation publications. This statement is not a guaranty or warranty, either expressed or implied.

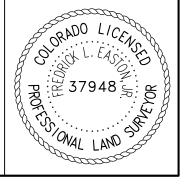

PLS No. 37948

3/6/2013 sparker 12:20:53 PM P:\2012\0121426-US24 WG

DOT

P.O. Box 536 905 Erie Avenue Pueblo, CO 81002 Phone: 719-546-5438 FAX: 719-546-5702

ı		Sheet Revisions			Sheet Revisions	
Date	Initials	Description	Date	Initials	Description	:
	-					

Sheet Revisions			
Description	Initials	BOOMERS Farncy Orth	
		Farnsworth SCENISS GROUP	Pro
		4755 FORGE ROAD, SUITE 150 COLORADO SPRINGS, COLORADO 80907	Pro
	l	(719) 590-9194 / (719) 590-9111 Fax	

RIGHT OF WAY

EXHIBIT EA-3

Project Number: NH 0242-056


Project Location: U.S. 24 Fire Mitigation - Cascade

EL PASO COUNTY, COLORADO

Project Code: Last Mod. Date Subset Sheet No. Sheet Total

Region 2

SECTION 15 T13S, R68W, 6TH PM EL PASO COUNTY, CO

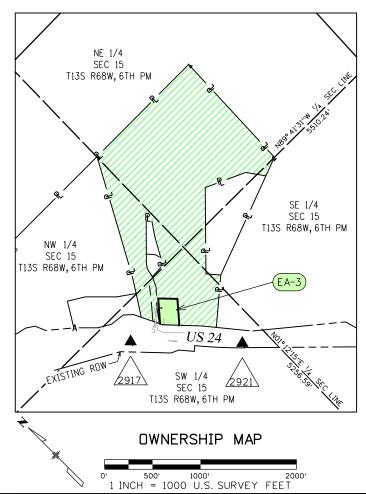

	PROJECT CONTROL TABLE							
Point No.	Project Coordinates		⊟ev(ft)	Description				
Point No.	Northing(ft)	Easting(ft)	(NAVD88)	Description				
2917	396289.12	147683.17	7477.22	C.D.O.H. C.M. M.P. 291.7				
2921	395454.64	148495.48	7468.19	C.D.O.H. C.M. M.P. 292.1				
CONYERS	401915.89	141761.70	7924.85	SMOOTH STEEL ROD IN LOGO BOX'CONYERS 1991'				
QUILLEN	374992.80	168814.07	6438.85	3.25IN DIA BRASS CAP IN STONE OURCROPING QUILLEN 1992				

General Notes:

- 1. This Right-of-Way Exhibit is not a complete boundary survey of all adjoining owners and is prepared for the Colorado Department of Transportation purposes only.
- 2. Notice: According to Colorado law, you must commence any legal action based upon any defect in this survey within three years after you first discover such defect. In no event may any action based upon such defect in this survey be commenced more than ten years from the date of certification hereon.
- 3. Existing right-of-way lines were established using CDOT Project No. F024-2(1) Sec. 1 Right-of-Way Plans. Aliquot section corners and lines are per CDOT Control Diagram Sheet for Project CX 04-0024-45.
- 4. For title information Farnsworth Group, Inc. relied on title commitments prepared by H. C. Peck and Associates.

COURDINATE DATUM: Project coordinates are modified Colorado State Plane Central Zone NAD '83/(92) coordinates. The combined elevation/scale factor used to modify the coordinates from state plane to project coordinates is 1.0003911506. The resulting project coordinates are truncated by 3,000,000sft in the Northing and 1,000,000sft in the Easting after converting from state plane coordinates to project coordinates. The CHARN is based on the NAD '83(92) datum.

Project Coordinates Northing US Survey Feet = (State Plane Coordinate Northing * 1.0003911506 - 3,000,000) * (3937/1200).

Project Coordinates Easting US Survey Feet = (State Plane Coordinate Easting * 1.0003911506 - 1,000,000) * (3937/1200).

Basis of Elevations: Project elevations are based on NAVD 88 values published on the CDOT Control Diagram Sheet, Project No. 141173, dated Feb 19, 2003.

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3/6/2013	

	R.O.W. TABULATION OF PROPERTIES IN EL PASO COUNTY - U.S. NO. 24						L. 100.244	2.00			
Used	Ownership Name and Mailing		Location T-13-S R-68-W, 6TH PM	Area In Square Feet (Acres)					Book and Page No. And/Or	Title Commitment	Remarks
Parcel No.	Address	Site Address		Area Of Parcel	Existing ROW	Net Area	Remainder Left	Remainder Right	Reception No.	No.	
EA-3	KAHLM, LLC, A COLORADO										
	LIMITED LIABILITY COMPANY		SECTION 15	54,839 SQ FT				2,525,483 SQ FT		05489A2013	
1	5975 WELLINGTON RD			(1.259 AC)				(57.977 AC)			
	CASCADE, CO 80809-1025										

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P.O. Box 536 905 Erie Avenue Pueblo, CO 81002 Phone: 719-546-5438 FAX: 719-546-5702

	Sheet Revisions			Sheet Revisions		
te	Description	Initials	Date	Description	Initials	
6-13	Revised Design References	SDP				
6-13	Added Water WellLocation	SDP				
						ıL


Project Location: U.S. 24 Fire Mitigation - Cascade

EL PASO COUNTY, COLORADO

Project Code: Last Mod. Date Subset Sheet No. Sheet Total

RIGHT OF WAY

Region 2

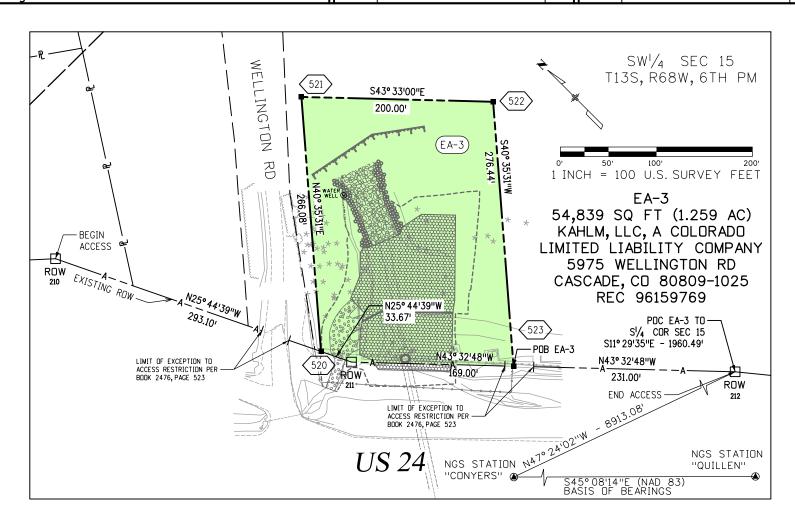

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R	nw

	FOUND R.O.W. MONUMENT COORDINATE TABLE							
Point No.	Northing(ft)	Easting(ft)	Description					
210 147905.17		396467.07	FND. CDOT ROW MON W/ 3 1/4" ALUM. CAP					
211	148047.07	396172.82	FND. CDOT ROW MON W/ 3 1/4" ALUM. CAP					
212	148322.66	395882.87	FND. CDOT ROW MON W/ 3 1/4" ALUM. CAP					



	TABULATION OF R.O.W. MONUMENTS TO BE SET								
Point No.	Northing(ft)	Easting(ft)	Description						
520	396203.15	148032.44	CDOT TYPE I MONUMENT						
521	396405.20	148205.57	CDOT TYPE I MONUMENT						
522	396260.25	148343.37	CDOT TYPE I MONUMENT						
523	396050.32	148163.50	CDOT TYPE I MONUMENT						

Notes:

Sheet Revisions


- 1. The exact location and type of right-of-way of Wellington Road is unknown at this time. Vesting deeds reference Book 601, Page 457 which is illegible in many areas and Book 123, Page 65 which does not exist according to the Title Commitment. The approximate right-of-way line based on fences and utilities is shown.
- 2. Easement for waterline in Book 3534, Page 225 adjacent to Wellington Road cannot be depicted as no width has been designated.
- 3. Easement for Plateau Natural Gas Company in Book 1994, Page 289 along the northerly side of Highway 24 cannot be depicted as no width has been designated.
- 4. Easement for Colorado Telephone Co. in Book 358, Page 577 cannot be depicted as no specific location has been noted.

Basis of Bearings: Bearings are Colorado State Plane, Central Zone, NAD 83/92, based on a line between NGS station "CONYERS" PID - JK1354, a steel rod encased in PVC with NGS logo cap set in 1.6' concrete post near mile post 290.2, and NGS station "QUILLEN" PID - JK1385, a drill hole in sandstone near mile post 298.15. Said line bears S45° 08'14"E per CDOT control diagram for project number 14173.

See www.ngs.noaa.gov for data sheets containing detailed location information.

SURVEYOR STATEMENT (R.O.W. MONUMENTS)

I, Fredrick L. Easton , a professional land surveyor licensed in the State of Colorado, do hereby state to the Colorado Department of Transportation that based upon my knowledge, information and belief, adequate research, calculations and evaluation of survey evidence were performed and the Right-of-Way monuments depicted on this Right-of-Way Plan were set under my responsible charge in accordance with applicable standards of practice defined by Colorado Department of Transportation publications. This statement is not a guaranty or warranty, either expressed or implied.

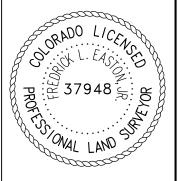



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	Sheet Revisions			Sheet Revisions		
9	Description	Initials	Date	Description	Initials	Dat
						-

Initials	Farnsworth	
	SCIENTISS GROUP	Pr
	4755 FORGE ROAD, SUITE 150 COLORADO SPRINGS, COLORADO 80907	Pr
	(719) 590-9194 / (719) 590-9111 Fax	

RIGHT OF WAY
EXHIBIT EA-4


Project Number: NH 0242-056

Project Location: U.S. 24 Fire Mitigation - Cascade
EL PASO COUNTY, COLORADO

Project Code: Last Mod. Date Subset Sheet No. Sheet Total

Region 2

SECTION 15 T13S, R68W, 6TH PM EL PASO COUNTY, CO

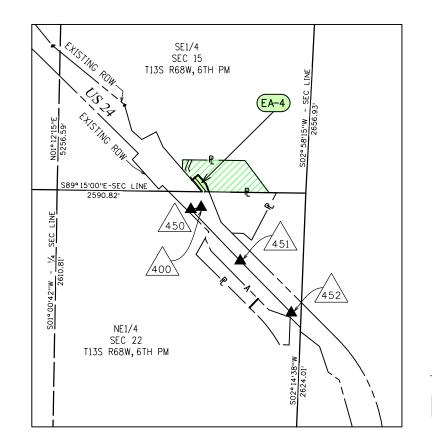



	PROJECT CONTROL TABLE									
Point No.	Project Co	oordinates	⊟ev(ft)	Description						
POINT NO.	Northing(ft)	Easting(ft)	(NAVD88)	Description						
400	393870.32	150213.02	7519.56	MAG NAIL						
450	393758.48	150106.52	7523.40	MAG NAIL IN ASPHALT SHOULDER OF HWY 24						
451	393221.94	150621.04	7482.85	18" #5 REBAR W/RPC "FARNSWORTH CONTROL POINT"						
452	392679.37	151152.33	7479.74	18" #5 REBAR W/RPC "FARNSWORTH CONTROL POINT"						
CONYERS	401915.89	141761.70	7924.85	SMOOTH STEEL ROD IN LOGO BOX'CONYERS 1991'						
QUILLEN	374992.80	168814.07	6438.85	3.25IN DIA BRASS CAP IN STONE OURCROPING 'QUILLEN 1992'						

General Notes:

Sheet Revisions


- 1. This Right-of-Way Exhibit is not a complete boundary survey of all adjoining owners and is prepared for the Colorado Department of Transportation purposes only.
- 2. Notice: According to Colorado law, you must commence any legal action based upon any defect in this survey within three years after you first discover such defect. In no event may any action based upon such defect in this survey be commenced more than ten years from the date of certification hereon.
- 3. Existing right-of-way lines were established using CDOT Project No. F024-2(1) Sec. 1 Right-of-Way Plans. Aliquot section corners and lines are per CDOT Control Diagram Sheet for Project CX 04-0024-45.
- 4. For title information Farnsworth Group, Inc. relied on title commitments provided by H. C. Peck and Associates.

CODRDINATE DATUM: Project coordinates are modified Colorado State Plane Central Zone NAD '83/(92) coordinates. The combined elevation/scale factor used to modify the coordinates from state plane to project coordinates is 1.0003911506. The resulting project coordinates are truncated by 3,000,000sft in the Northing and 1,000,000sft in the Easting after converting from state plane coordinates to project coordinates. The CHARN is based on the NAD '83(92) datum.

Project Coordinates Northing US Survey Feet = (State Plane Coordinate Northing * 1.0003911506 - 3,000,000) * (3937/1200).

Project Coordinates Easting US Survey Feet = (State Plane Coordinate Easting * 1.0003911506 - 1,000,000) * (3937/1200).

Basis of Elevations: Project elevations are based on NAVD 88 values published on the CDDT Control Diagram Sheet, Project No. 141173, dated Feb 19, 2003.

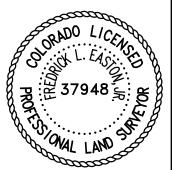

	R.O.W. TABULATION OF PROPERTIES IN EL PASO COUNTY - U.S. NO. 24								200000000000000000000000000000000000000		
3	Oursella Nama and Malling		1		Area I	n Square Fee	et (Acres)	Book and Page No. And/Or	Title Commitment	Remarks	
Parcel No.	Ownership Name and Mailing Address	Site Address	Location T-13-S R-68-W, 6TH PM	Area Of Parcel	Existing ROW	Net Area	Remainder Left	Remainder Right	Reception No.	No.	
EA-4	ANTONI POGERZELSKI &								1		
	LIDIA POGERZELSKI		SE1/4 SEC 15	15,086 SQ FT				218,553 SQ FT		05491A2013	
	8989 W BUSINESS 83			(0.346 AC)				(5.017 AC)			
	HARLINGEN, TX 78552-2283										

DOT

P.O. Box 536 905 Erie Avenue Pueblo, CD 81002 Phone: 719-546-5438 FAX: 719-546-5702

	Sheet Revisions			Sheet Revisions		
te	Description	Initials	Date	Description	Initials	
6-13	Revised Design References	SDP				
	_					

Farnsworth

Short Colorado Springs, Colorado 80907
(719) 590-9194 / (719) 590-9111 Fox

EXHIBIT EA-4

Project Number: NH 0242-056

Project Location: U.S. 24 Fire Mitigation - Cascade

EL PASD COUNTY, COLORADO

Project Code: Last Mod. Date Subset Sheet No. Sheet Total

RIGHT OF WAY

Region 2

1 INCH = 100 U.S. SURVEY FEET SE1/4 SEC 15 T13S, R68W, 6TH PM NGS STATION "CONYERS" N46° 51'04"W - 11,316.51' 30' INGRESS, EGRESS, DRAINAGE AND UTILITY EASEMENT REC. NO. 202013814 EA-4 15,086 SQ FT (0.346 AC) ANTONI POGERZELSKI & LIDIA POGERZELSKI 8989 W BUSINESS 83 HARLINGEN, TX 78552-2283 REC 206105746, REC 206105747 & REC 20610548 PROPOSED ROW POB EA-4 TO SE COR SEC 15 S89° 15'00"E - 1008.18' S89°15'00"E - SEC LINE 74.821 2590.821 ROW 525 ACCESS OPENING SIGS STATION

⊡	FOUND R.O.W. MONUMENT COORDINATE TABLE							
ROW	Point No.	Northing(ft)	Easting(ft)	Description				
	1000	394176.58	150018.01	1.5" AL CAP - LS 12043	_			
	1001	394008.78	149810.29	1.5" AL CAP - LS 15672				
	1500	393949.65	149869.42	3.25" BRASS CAP IN CONC				

	TAB	ULATION OF Calculate	ed Points
Point No.	Northing(ft)	Easting(ft)	Description
901	393941.98	150220.96	

Notes:

Sheet Revisions

1. The following easements are either generally described or cover existing facilities without a defined width or size and cannot be depicted:

Plateau Natural Gas Company, in Book 1994 at Page 289

The Mountain States Telephone and Telegraph Co., in Book 852 at Page 264

Ute Pass Improvement Co., in Book 358 at Page 577

Basis of Bearings: Bearings are Colorado State Plane, Central Zone, NAD 83/92, based on a line between NGS station "CONYERS" PID - JK1354, a steel rod encased in PVC with NGS logo cap set in 1.6' concrete post near mile post 290.2, and NGS station "QUILLEN" PID - JK1385, a drill hole in sandstone near mile post 298.15. Said line bears S45° 08'14"E per CDOT control diagram for project number 14173.


See www.ngs.noaa.gov for data sheets containing detailed location information.



	TABULATIO	OF R.O.W. MONUI	MENTS TO BE SET
Point No.	Northing(ft)	Easting(ft)	Description
525	393941.00	150295.77	CDOT TYPE I MONUMENT
526	394061.76	150117.34	CDOT TYPE I MONUMENT
527	394117.36	150181.60	CDOT TYPE I MONUMENT
528	394022.82	150263.38	CDOT TYPE I MONUMENT

SURVEYOR STATEMENT (R.O.W. MONUMENTS)

I, Fredrick L. Easton, a professional land surveyor licensed in the State of Colorado, do hereby state to the Colorado Department of Transportation that based upon my knowledge, information and belief, adequate research, calculations and evaluation of survey evidence were performed and the Right-of-Way monuments depicted on this Right-of-Way Plan were set under my responsible charge in accordance with applicable standards of practice defined by Colorado Department of Transportation publications. This statement is not a guaranty or warranty, either expressed or implied.

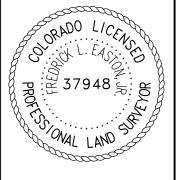

PLS No. 37948

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P.O. Box 536 905 Erie Avenue Pueblo, CD 81002 Phone: 719-546-5438 FAX: 719-546-5702


Sheet Revisions			Sheet Revisions	
Description	Initials	Date	Description	Initial


Farnsworth	
GROUP	Pro
755 FORGE ROAD, SUITE 150 COLORADO SPRINGS, COLORADO 80907	Pro
719) 590-9194 / (719) 590-9111 Fax	

RIGHT OF WAY EXHIBIT EA-5 ject Number: NH 0242-056 ject Location: U.S. 24 Fire Mitigation - Cascade EL PASO COUNTY, COLORADO

Region 2

SECTION 22 T13S, R68W, 6TH PM EL PÁSO COUNTY, CO

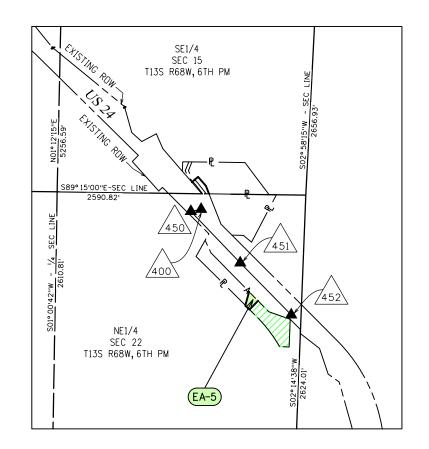

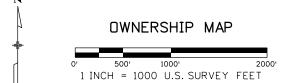

PROJECT CONTROL TABLE					
Point No.	Project Co	oordinates	Elev(ft)	Description	
Politi No.	Northing(ft)	Easting(ft)	(NAVD88)	Description	
400	393870.32	150213.02	7519.56	MAG NAIL	
450	393758.48	150106.52	7523.40	MAG NAIL IN ASPHALT SHOULDER OF HWY 24	
451	393221.94	150621.04	7482.85	18" #5 REBAR W/RPC "FARNSWORTH CONTROL POINT"	
452	392679.37	151152.33	7479.74	18" #5 REBAR W/RPC "FARNSWORTH CONTROL POINT"	
CONYERS	401915.89	141761.70	7924.85	SMOOTH STEEL ROD IN LOGO BOX'CONYERS 1991'	
QUILLEN	374992.80	168814.07	6438.85	3.25IN DIA BRASS CAP IN STONE OURCROPING 'QUILLEN 1992'	

General Notes:

Sheet Revisions

- 1. This Right-of-Way Exhibit is not a complete boundary survey of all adjoining owners and is prepared for the Colorado Department of Transportation purposes only.
- 2. Notice: According to Colorado law, you must commence any legal action based upon any defect in this survey within three years after you first discover such defect. In no event may any action based upon such defect in this survey be commenced more than ten years from the date of certification hereon.
- 3. Existing right-of-way lines were established using CDOT Project No. F024-2(1) Sec. 1 Right-of-Way Plans. Aliquot section corners and lines are per CDDT Control Diagram Sheet for Project CX 04-0024-45.
- 4. For title information Farnsworth Group, Inc. relied on title commitments provided by H. C. Peck and Associates.

COORDINATE DATUM: Project coordinates are modified Colorado State Plane Central Zone NAD '83/(92) coordinates. The combined elevation/scale factor used to modify the coordinates from state plane to project coordinates is 1.0003911506. The resulting project coordinates are truncated by 3,000,000sft in the Northing and 1,000,000sft in the Easting after converting from state plane coordinates to project coordinates. The CHARN is based on the NAD '83(92) datum.

Project Coordinates Northing US Survey Feet = (State Plane Coordinate Northing *1.0003911506 - 3,000,000) * (3937/1200).Project Coordinates Easting US Survey Feet = (State Plane Coordinate Easting * 1.0003911506 - 1,000,000) * (3937/1200).

Basis of Elevations: Project elevations are based on NAVD 88 values published on the CDDT Control Diagram Sheet, Project No. 141173, dated Feb 19, 2003.



	K.O.W. TABUL	LATION OF PRO	PERTIES IN EL PAS	O COUNTY	- 0.3.	NO. 24			Book and Page	Title	
	Ownership Name and Mailing		Location		Area II	n Square Fee	et (Acres)		No. And/Or	Commitment	Remarks
Parcel No.	Ownership Name and Mailing Address	Site Address	T-13-S R-68-W, 6TH PM	Area Of Parcel	Existing ROW	Net Area	Remainder Left	Remainder Right	Reception No.	No.	
EA-5	PATRICIA G ROBBINS		NE1/4 SEC 22	12,462 SQ FT			92,953 SQ FT			05493A2013	
	PO BOX 6			(0.286 AC)			(2.134 AC)				
	MANITOU SPRINGS, CO 80829-0006										

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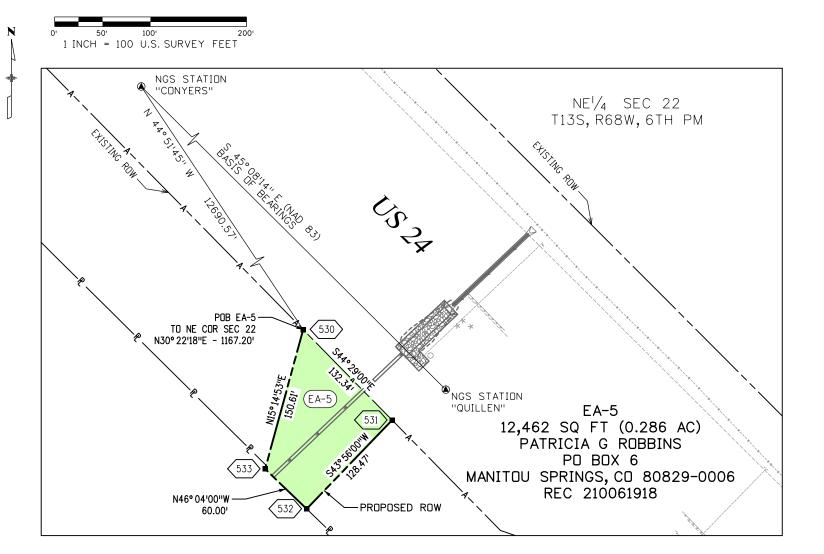
P.O. Box 536 905 Erie Avenue Pueblo, CO 81002 Phone: 719-546-5438 FAX: 719-546-5702

	Sheet Revisions			Sheet Revisions		
te	Description	Initials	Date	Description	Initials	D
6-13	Revised Design References	SDP				

Sheet Revisions			
Description	Initials	Farnsworth	
		SCIENTISS GROUP	Р
		4755 FORGE ROAD, SUITE 150 COLORADO SPRINGS, COLORADO 80907	Р
		(719) 590-9194 / (719) 590-9111 Fax	Г

		RIGHT OF WAY						
h	EXHIBIT EA-5							
	Project Nu	mber: NH 02	42-056					
0907	Project Lo	cation: U.S. 2	24 Fire Mitigation -	Cascade	:			
0907	EL PASO COUNTY, COLORADO							
	Project Code:	Last Mod. Date	Subset	Sheet No.	Sheet Total			
	19358	03-06-13	5.02 of 5.02	5.02	13			

Region 2



Notes:

1. The following easement covers existing facilities without a defined width or size and cannot be depicted:

The Mountain States Telephone and Telegraph Co., in Book 852 at Page 264

Basis of Bearings: Bearings are Colorado State Plane, Central Zone, NAD 83/92, based on a line between NGS station "CONYERS" PID - JK1354, a steel rod encased in PVC with NGS logo cap set in 1.6' concrete post near mile post 290.2, and NGS station "QUILLEN" PID - JK1385, a drill hole in sandstone near mile post 298.15. Said line bears S45° 08'14"E per CDOT control diagram for project number 14173.


See www.ngs.noaa.gov for data sheets containing detailed location information.

XXX ►

	TABULATION OF R.O.W. MONUMENTS TO BE SET					
Point No.	Northing(ft)	Easting(ft)	Description			
530	392920.78	150713.72	CDOT TYPE I MONUMENT			
531	392826.36	150806.45	CDOT TYPE I MONUMENT			
532	392733.84	150717.32	CDOT TYPE I MONUMENT			
533	392775.47	150674.11	CDOT TYPE I MONUMENT			

SURVEYOR STATEMENT (R.O.W. MONUMENTS)

I, Fredrick L. Easton, a professional land surveyor licensed in the State of Colorado, do hereby state to the Colorado Department of Transportation that based upon my knowledge, information and belief, adequate research, calculations and evaluation of survey evidence were performed and the Right-of-Way monuments depicted on this Right-of-Way Plan were set under my responsible charge in accordance with applicable standards of practice defined by Colorado Department of Transportation publications. This statement is not a guaranty or warranty, either expressed or implied.

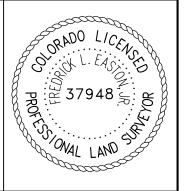

DOT P

P.O. Box 536 905 Erie Avenue Pueblo, CO 81002 Phone: 719-546-5438 FAX: 719-546-5702


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ite	Description	Initials	Date	Description	Initials	Date
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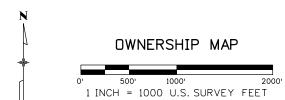
Sheet Revisions			
Description	Initials	ARCHIECIS Farneworth	
		Farnsworth GROUP	
		SCIENTISS GROUP	
		4755 FORGE ROAD, SUITE 150	
		COLORADO SPRINGS, COLORADO 80907	
		(719) 590-9194 / (719) 590-9111 Fax	

th			EA-PE-6 & I	EA-TE	-6
	Project Nu	mber: NH 02	42-056		
80907	Project Lo	cation: U.S. 2	24 Fire Mitigation -	· Cascade	;
			ASO COUNTY, COLO	RADO	
	Project Code:	Last Mod. Date	Subset	Sheet No.	Sheet Tota

RIGHT OF WAY

Region 2



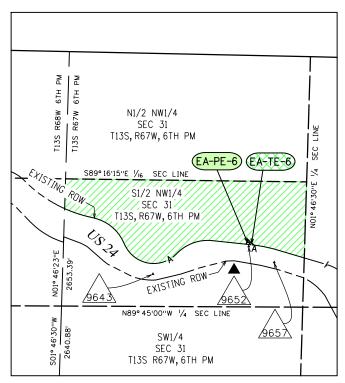

PROJECT CONTROL TABLE							
Point No.	Project Coordinates		Elev(ft)	Description			
Point No.	Northing(ft)	Easting(ft)	(NAVD88)	Description			
9643	380755.29	161775.03	6825.52	CDOT TYPE II 3.25" ALUM, CAP M.P. 296.43			
9652	381044.37	162773.78	6758.02	CDOT TYPE II 3.25" ALUM. CAP M.P. 296.52			
9657	380876.75	163038.92	6738.45	CDOT TYPE II 3.25" ALUM. CAP M.P. 296.57			
CONYERS	401915.89	141761.70	7924.85	SMOOTH STEEL ROD IN LOGO BOX'CONYERS 1991'			
QUILLEN	374992.80	168814.07	6438.85	3.25IN DIA BRASS CAP IN STONE OURCROPING 'QUILLEN 1992'			

SECTION 31 T13S, R67W, 6TH PM EL PASO COUNTY, CO

General Notes:

- 1. This Right-of-Way Exhibit is not a complete boundary survey of all adjoining owners and is prepared for the Colorado Department of Transportation purposes only.
- 2. Notice: According to Colorado law, you must commence any legal action based upon any defect in this survey within three years after you first discover such defect. In no event may any action based upon such defect in this survey be commenced more than ten years from the date of certification hereon.
- 3. Existing right-of-way lines were established using CDOT Project No. F017-1(2) Right-of-Way calculations and control monuments, provided by CDOT. Aliquot section corners and lines are per CDOT Control Diagram Sheet for Project CX 04-0024-45.
- 4. For title information Farnsworth Group, Inc. relied on title commitments provided by H. C. Peck and Associates.

CODRDINATE DATUM: Project coordinates are modified Colorado State Plane Central Zone NAD '83/(92) coordinates. The combined elevation/scale factor used to modify the coordinates from state plane to project coordinates is 1.0003911506. The resulting project coordinates are truncated by 3,000,000sft in the Northing and 1,000,000sft in the Easting after converting from state plane coordinates to project coordinates. The CHARN is based on the NAD '83(92) datum.

Project Coordinates Northing US Survey Feet = (State Plane Coordinate Northing * 1.0003911506 - 3,000,000) * (3937/1200).

Project Coordinates Easting US Survey Feet = (State Plane Coordinate Easting * 1.0003911506 - 1,000,000) * (3937/1200).

Basis of Elevations: Project elevations are based on NAVD 88 values published on the CDDT Control Diagram Sheet, Project No. 141173, dated Feb 19, 2003.



		R.O.W. TABULATION OF PROPERTIES IN EL		ASO COUNTY - U.S. NO. 24 Area In Square Feet (Acres)					Book and Page No. And/Or	Title Commitment	Remarks
Parcel No.	Ownership Name and Mailing Address	Site Address	Location T-13-S R-67-W, 6TH PM	Area Of Parcel	Existing ROW	Net Area	Remainder Left	Remainder Right	Reception No.	No.	
EA-PE-6	AMERICAN CHRISTIAN COLLEGE, INC.,		S1/2 NW1/4 SEC 31	844 SQ FT				1,567,332 SQ FT		05526A2013	
	AN OKLAHOMA CORPORATION, DBA			(0.019 AC)				(35.981 AC)			
	SUMMIT YOUTH MINISTRIES, INC.										
EA-TE-6	PO BOX 207		SAME	1179 SQ FT							For construction and maintenance of headwalls
	MANITOU SPRINGS, CO 80829-0207			(0.027 AC)							and wingwalls for existing culvert


P.O. Box 536 905 Erie Avenue Pueblo, CD 81002 Phone: 719-546-5438 FAX: 719-546-5702

	Sheet Revisions			Sheet Revisions		Γ
ate	Description	Initials	Date	Description	Initials	
06-13	Revised Design References	SDP				

Sheet Revisions Farnsworth 755 FORGE ROAD, SUITE 150 OLORADO SPRINGS, COLORADO 809 '19) 590-9194 / (719) 590-9111 Fax

RIGHT OF WAY EXHIBIT EA-PE-6 & EA-TE-6 Project Number: NH 0242-056 Project Location: U.S. 24 Fire Mitigation - Cascade EL PASO COUNTY, COLORADO

Region 2

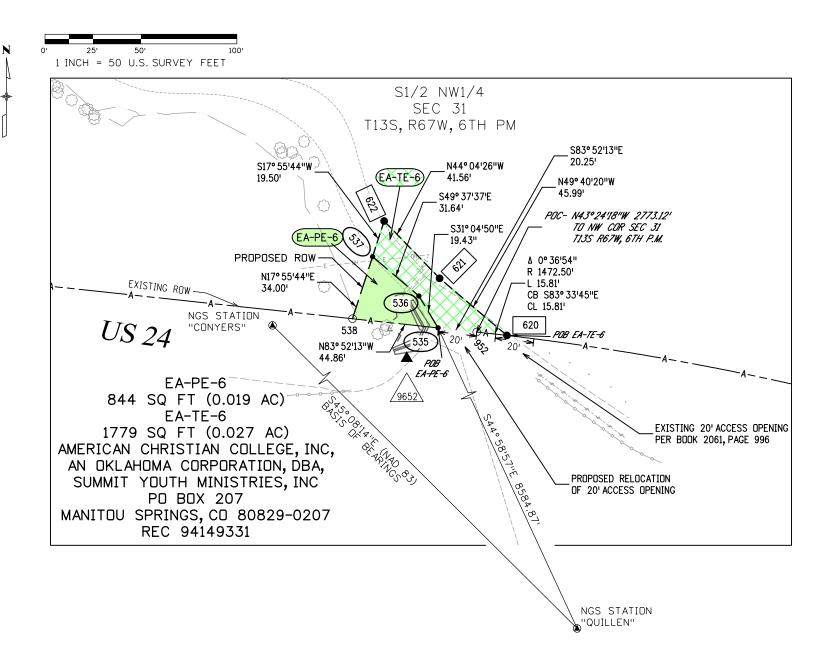

Notes:

1. Right-of-way for Waldo Canyon Creek is an exception to title; however, exact location and size of this right-of-way is unknown at this time, and can not be depicted.

XXX

TABULATION OF TEMPORARY EASEMENT POINTS TO BE STAKED						
Point No.	Northing(ft)	Easting(ft)	Description			
620	381056.34	162825.94				
621	381086.1	162790.88				
622	381115.96	162761.97				



TABULATION OF PERMANENT EASEMENT MONUMENTS TO BE SET								
Point No.	Northing(ft)	Easting(ft)	Description					
535	381060.27	162790.10	CDOT TYPE VI MONUMENT					
536	381076.92	162780.07	CDOT TYPE VI MONUMENT					
537	381097.41	162755.96	CDOT TYPE VI MONUMENT					
538	381065.06	162745.50	CDOT TYPE VI MONUMENT					

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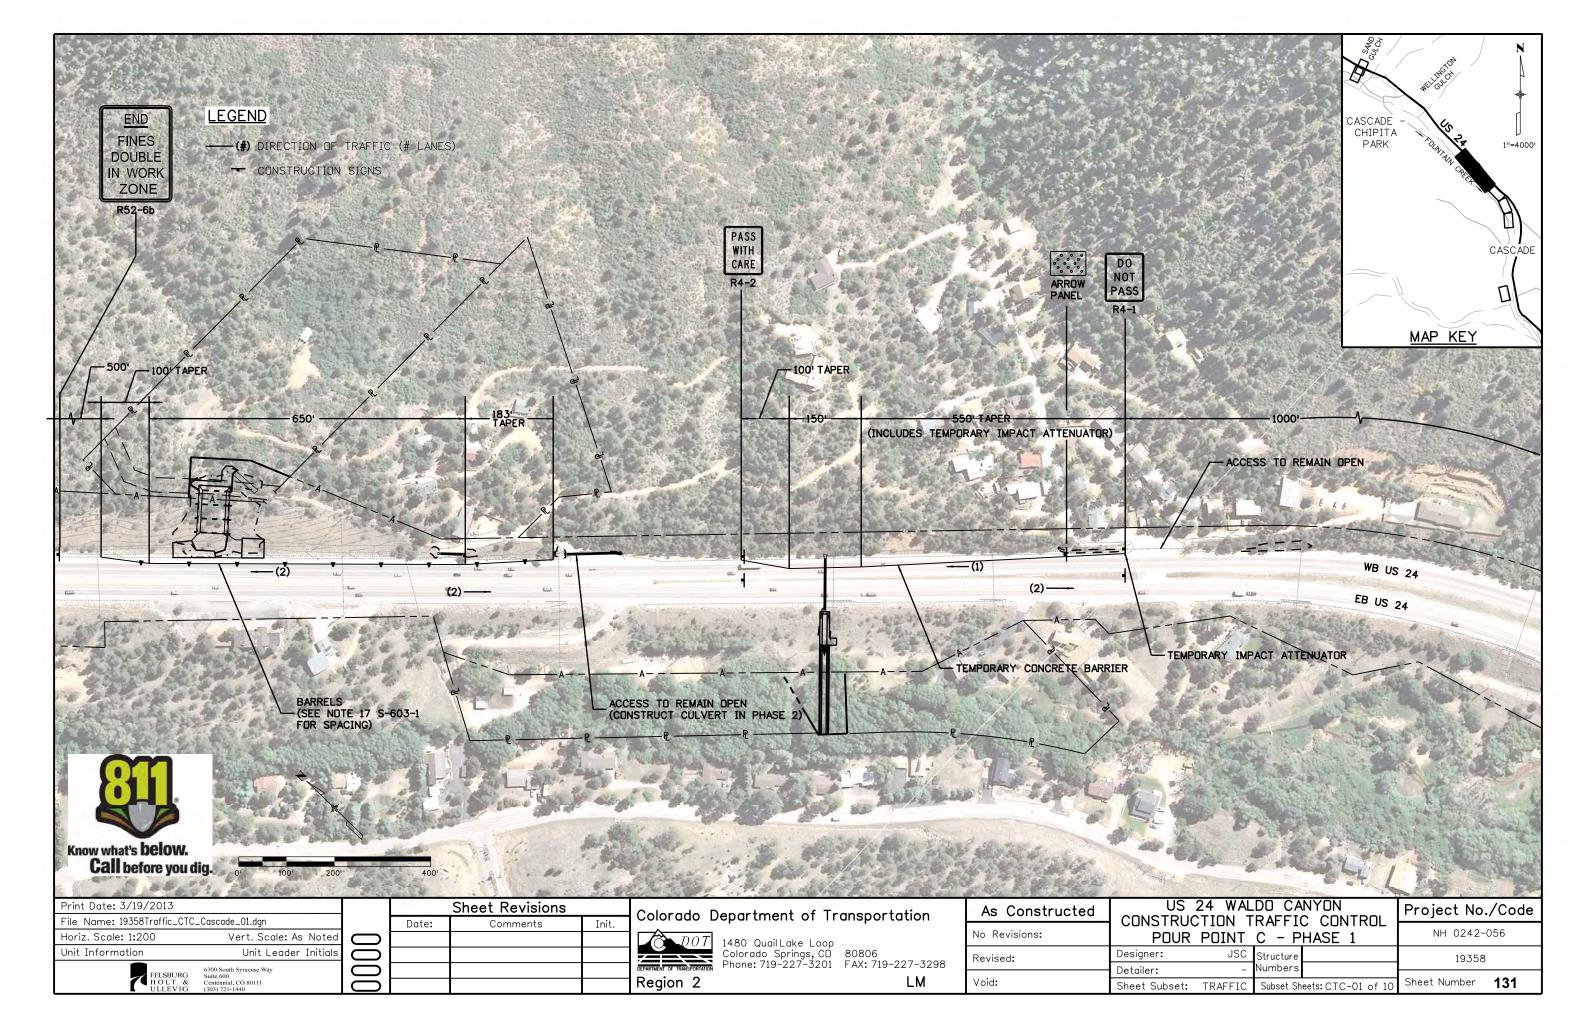
TABULATION OF CALCULATED POINTS						
Point No.	Northing(ft)	Easting(ft)	Description			
952	381058.11	162810.23				


Basis of Bearings: Bearings are Colorado State Plane, Central Zone, NAD 83/92, based on a line between NGS station "CONYERS" PID - JK1354, a steelrod encased in PVC with NGS logo cap set in 1.6' concrete post near mile post 290.2, and NGS station "QUILLEN" PID - JK1385, a drill hole in sandstone near mile post 298.15. Said line bears S45° 08'14"E per CDDT control diagram for project number 14173.


See www.ngs.noaa.gov for data sheets containing detailed location information.


SURVEYOR STATEMENT (R.O.W. MONUMENTS)


Fredrick L. Easton , a professional land surveyor licensed in the State of Colorado, do hereby state to the Colorado Department of Transportation that based upon my knowledge, information and belief, adequate research, calculations and evaluation of survey evidence were performed and the Right-of-Way monuments depicted on this Right-of-Way Plan were set under my responsible charge in accordance with applicable standards of practice defined by Colorado Department of Transportation publications. This statement is not a quaranty or warranty, either expressed or implied.




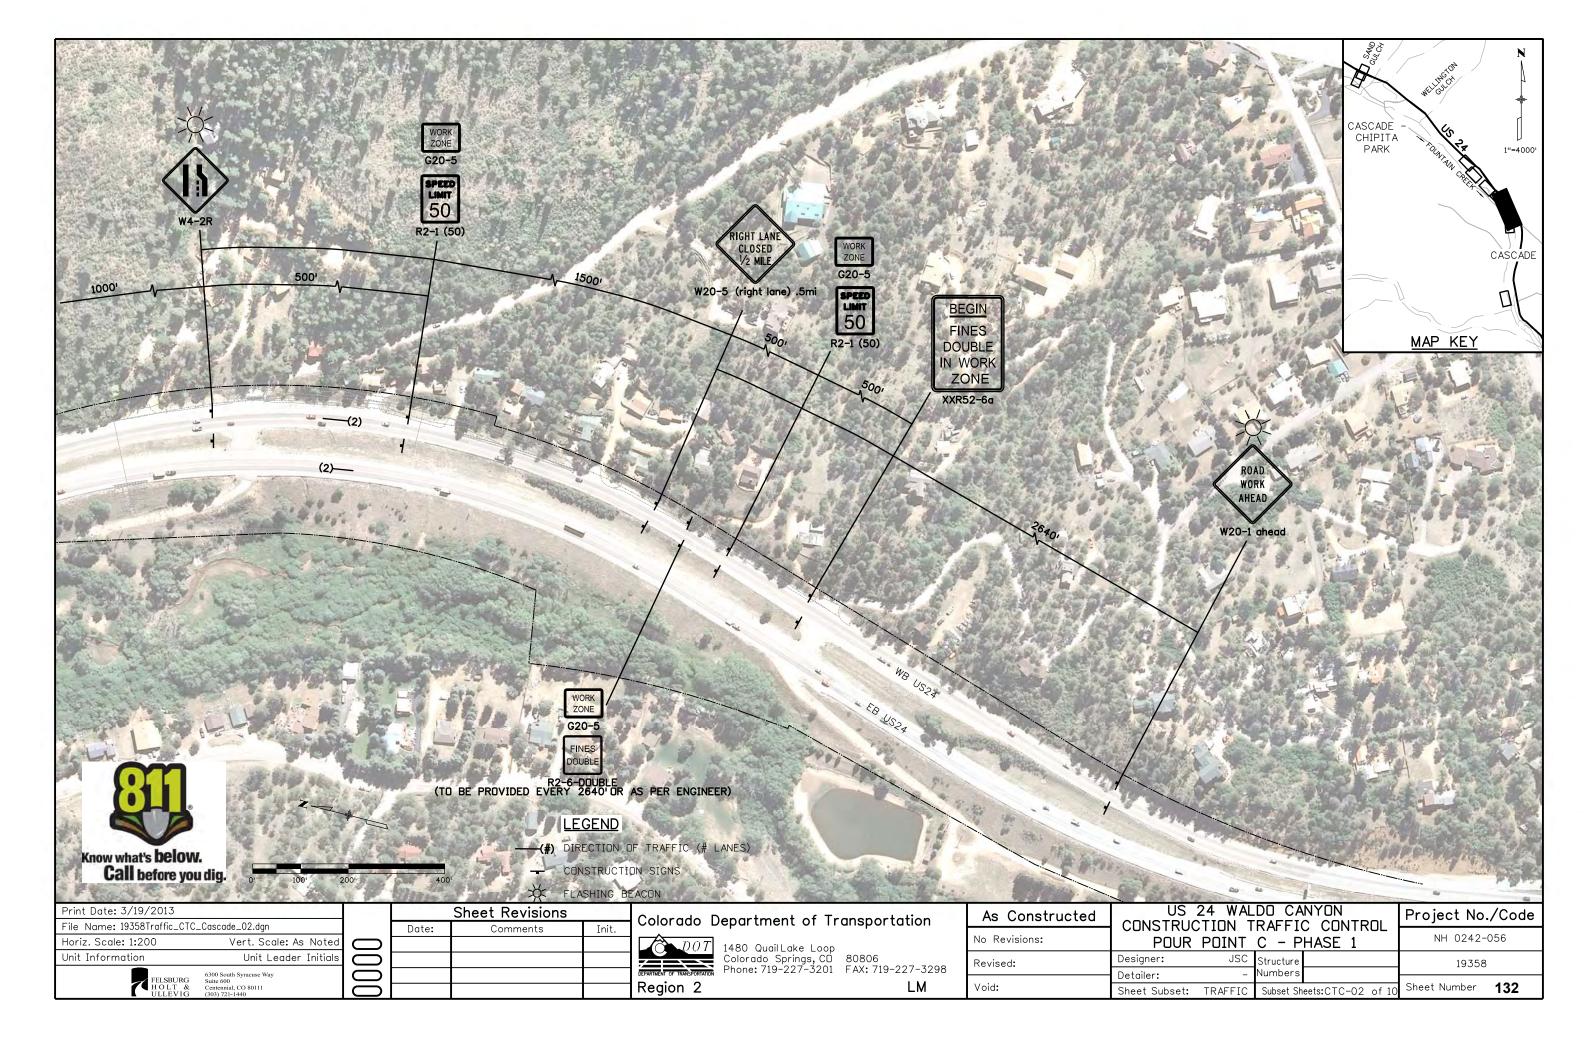


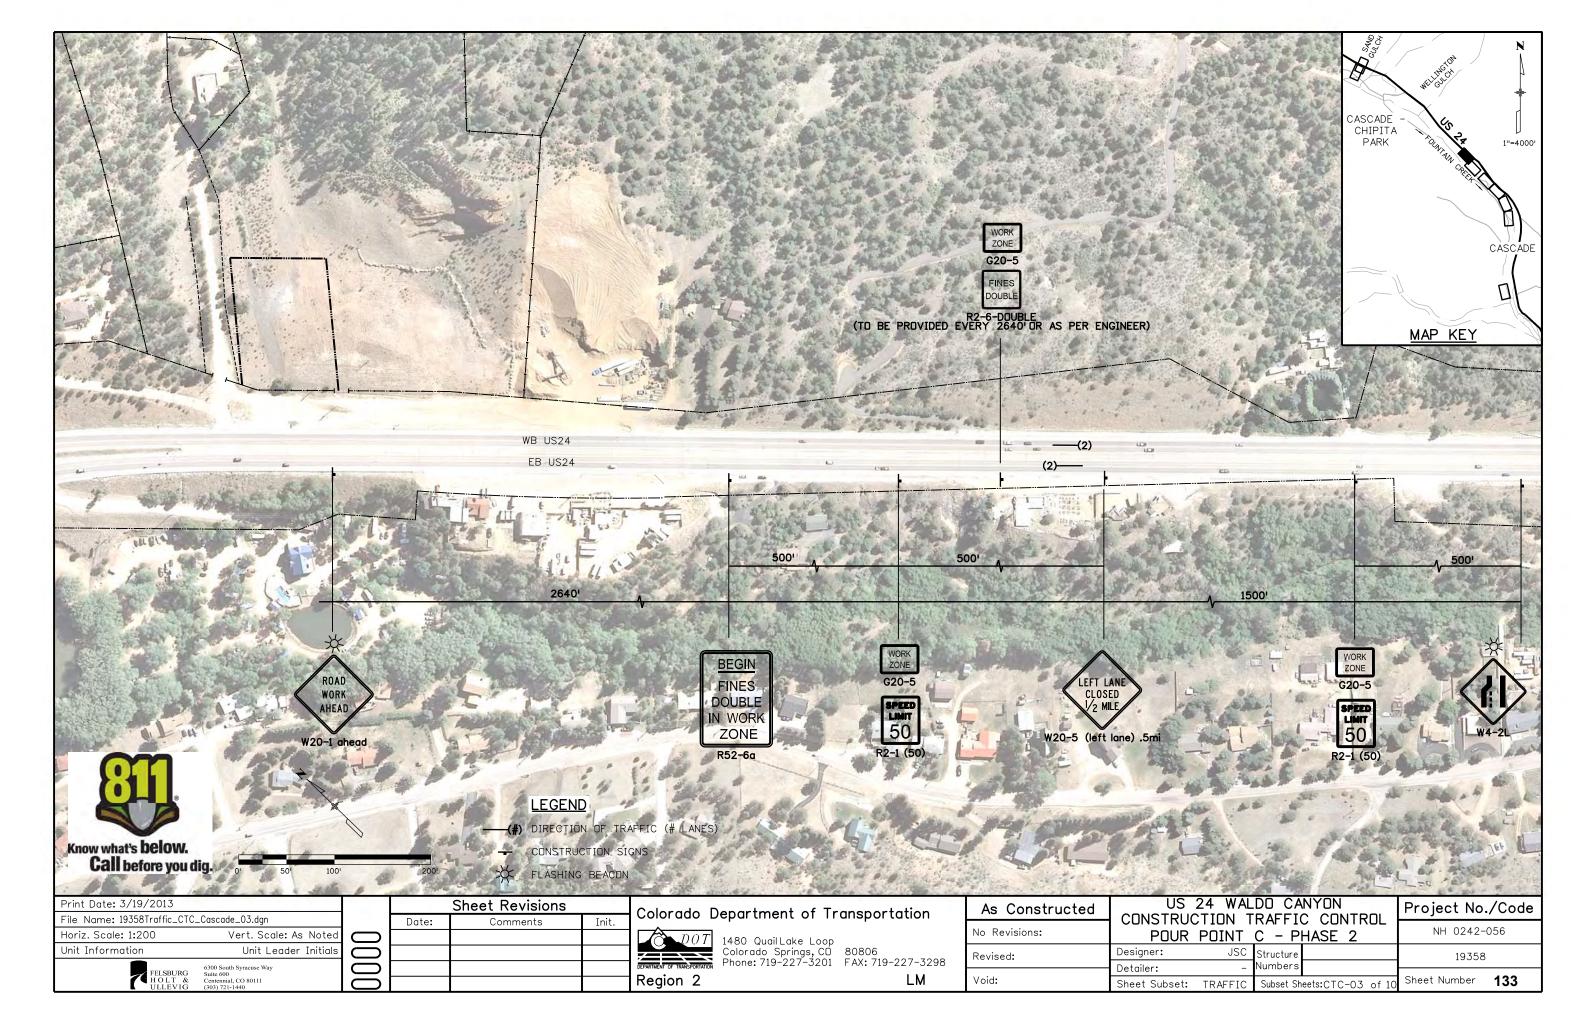


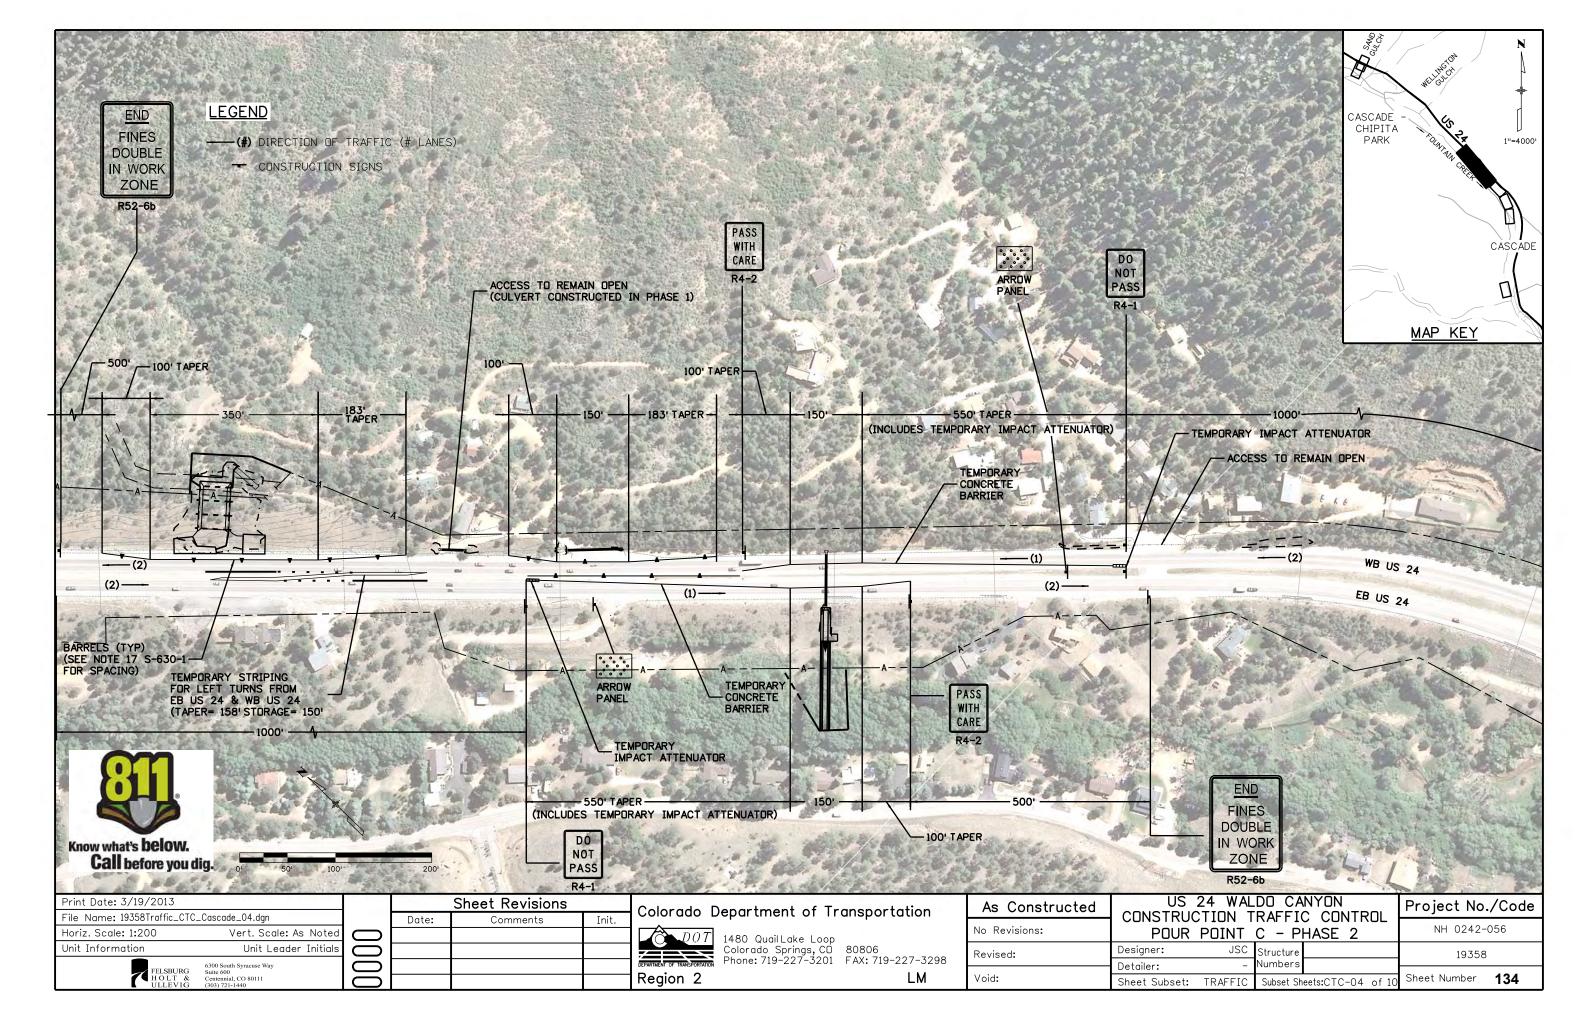

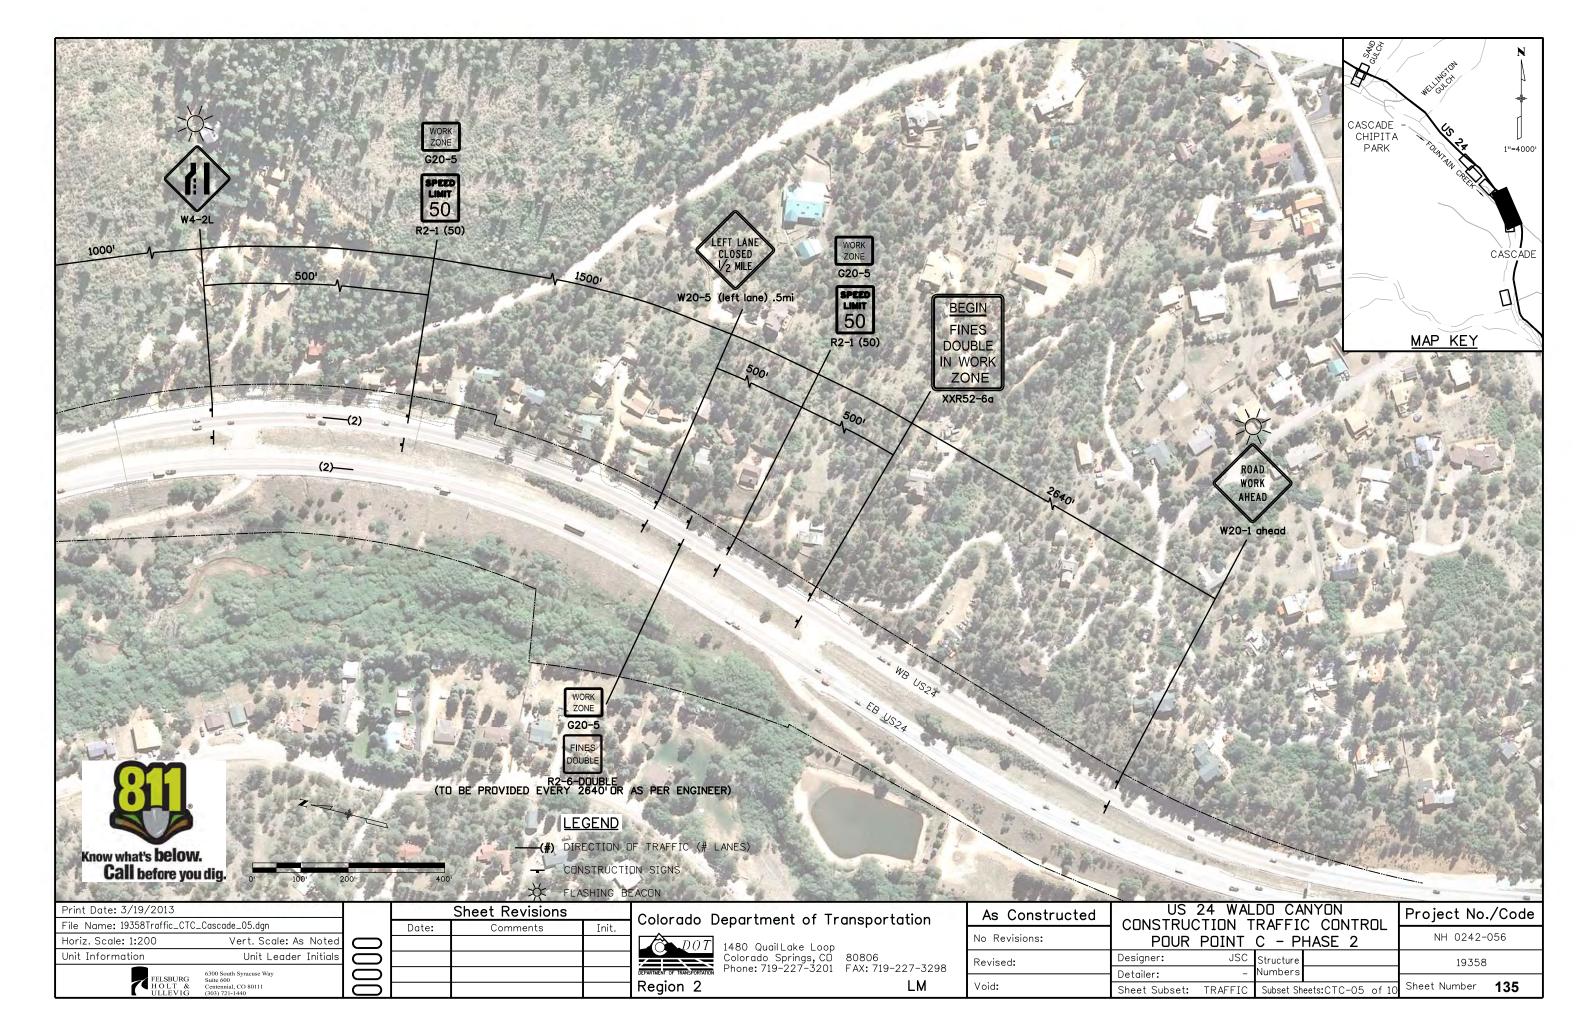

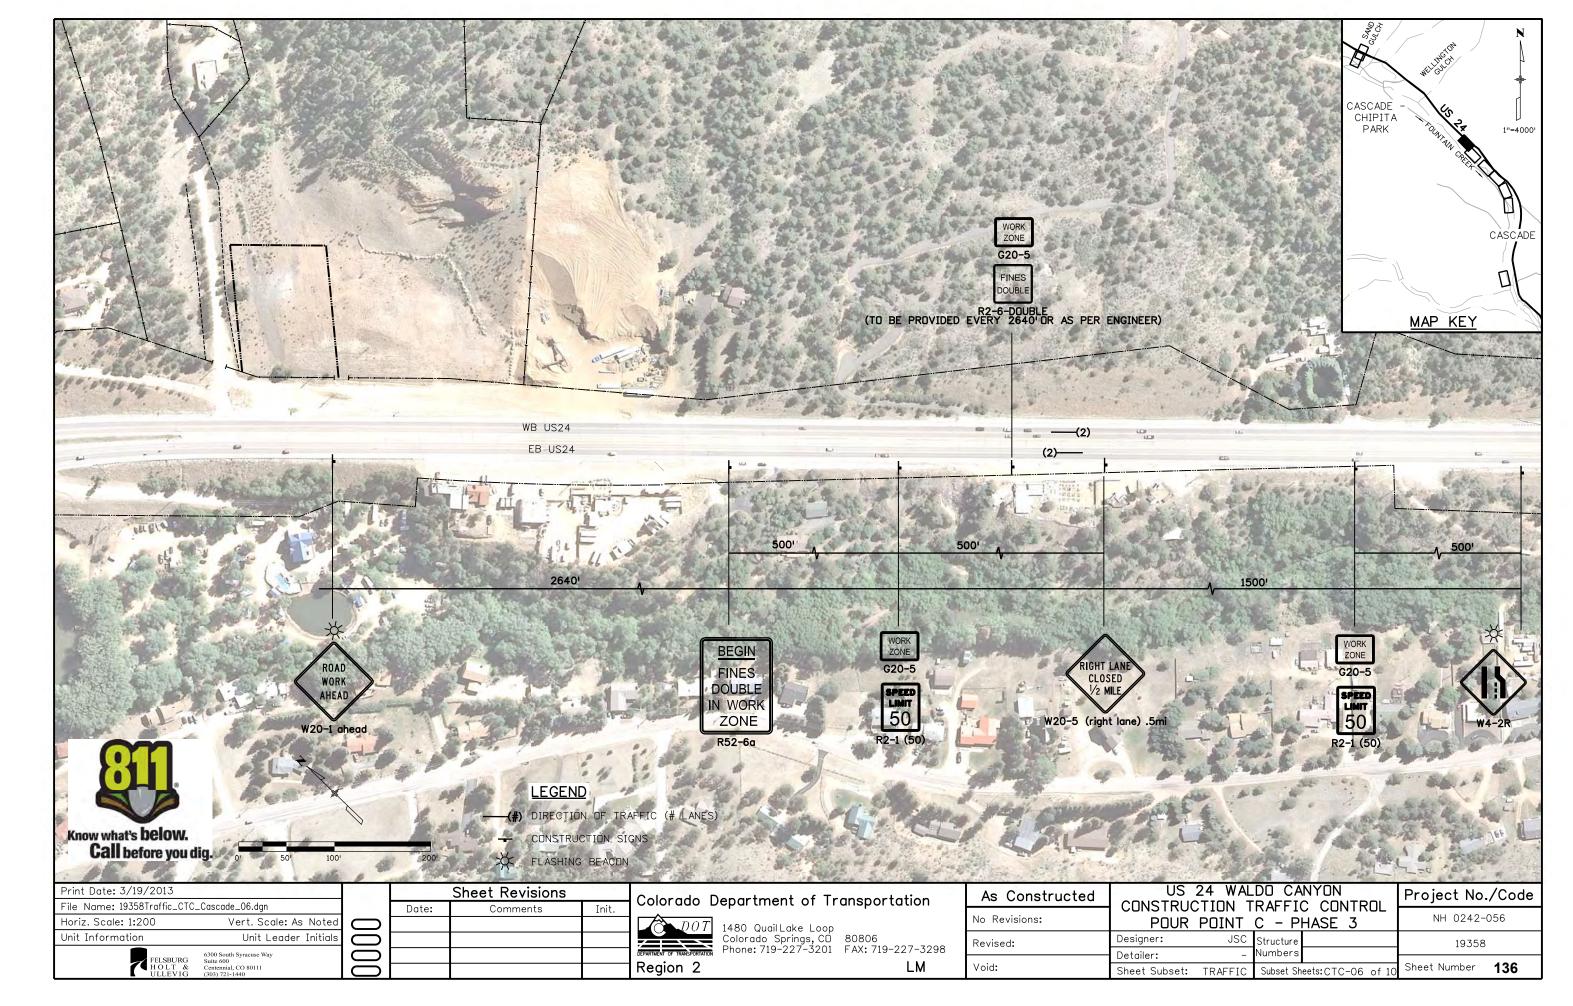

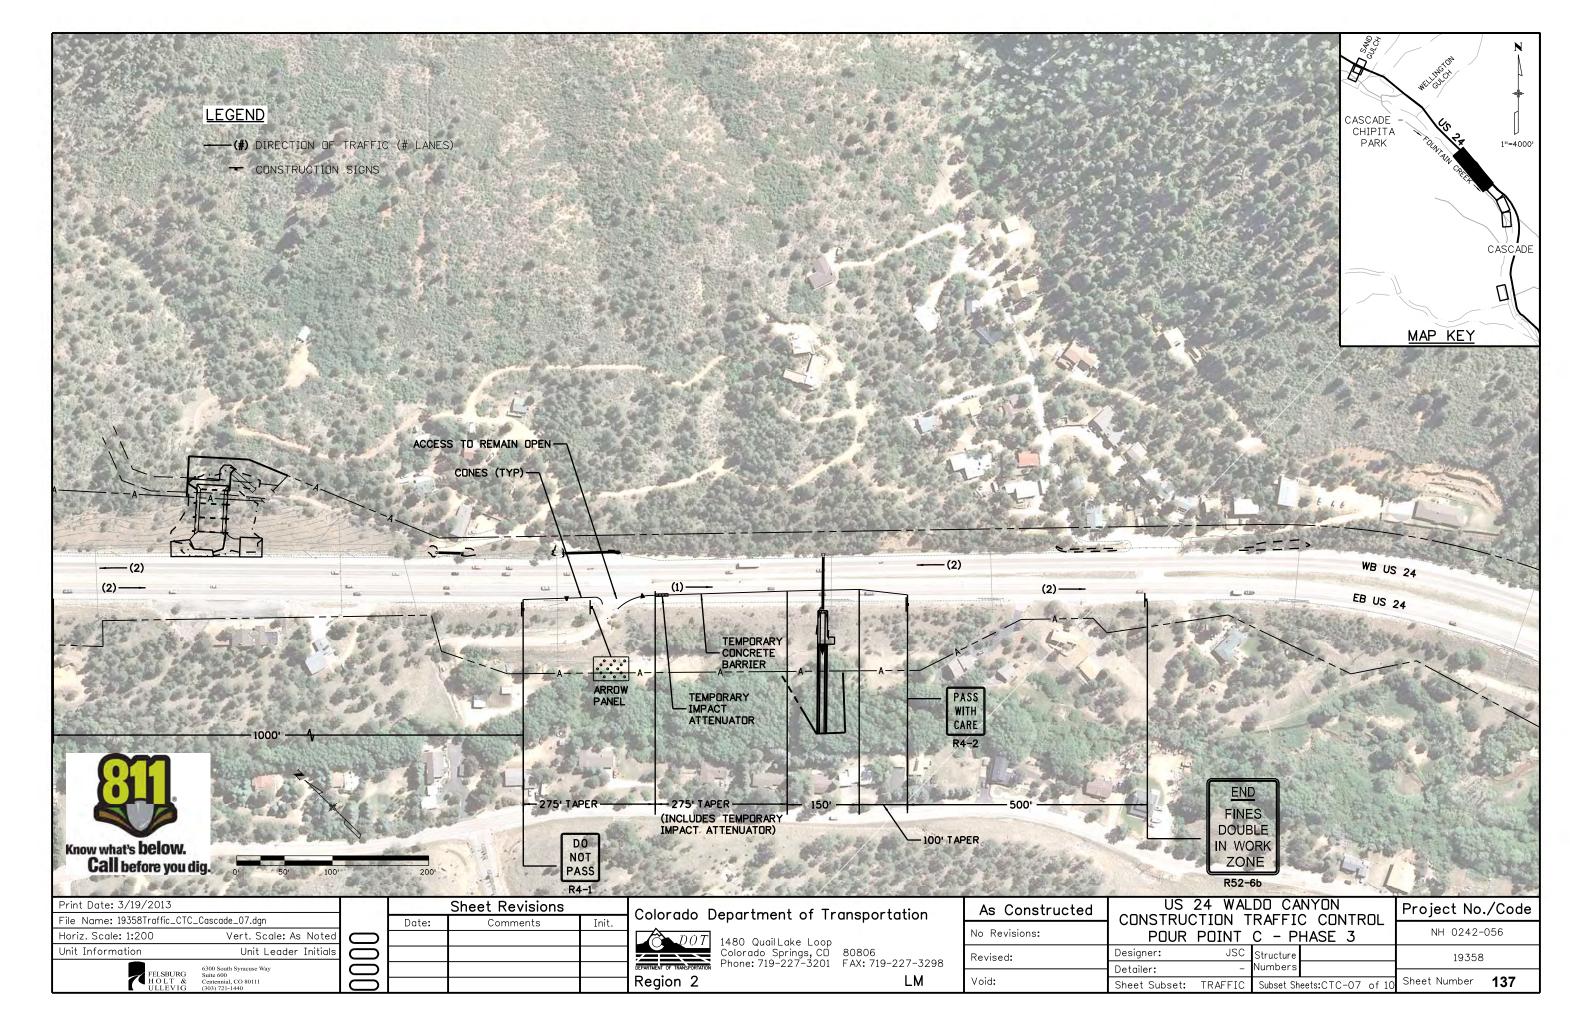

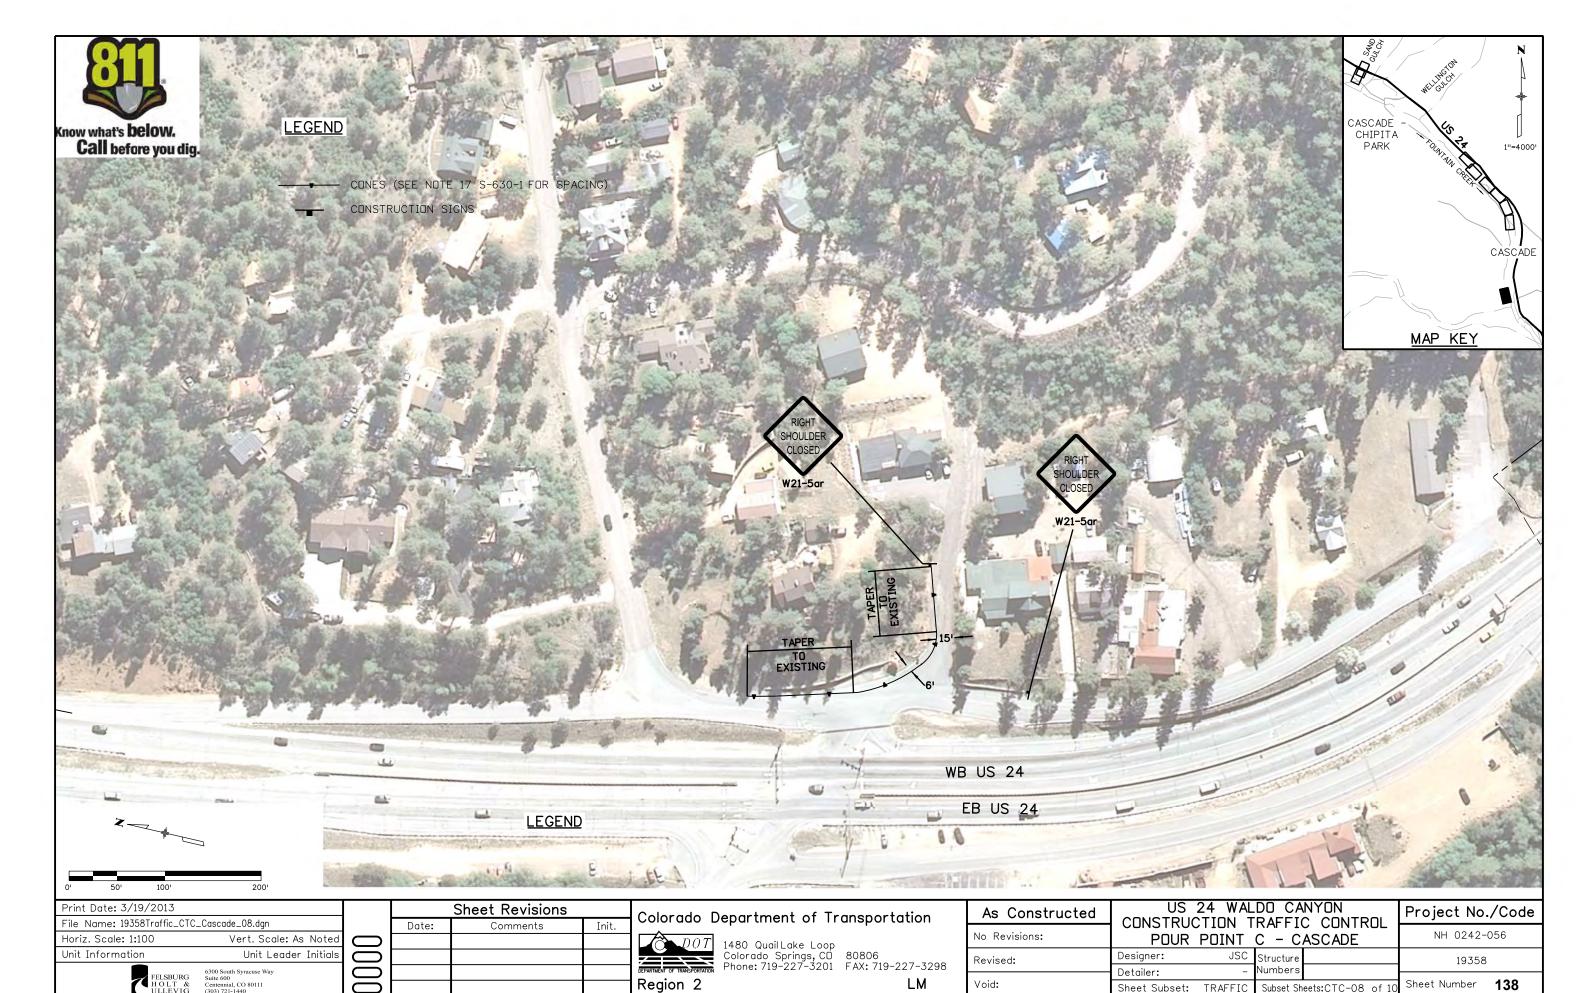

Sheet Subset: TRAFFIC

Subset Sheets:CTC-08 of 10

